



41015SW0003 2.10574 RANEY

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BRIEF REPORT
on the
Lithogeochemical Sampling Program
on the Raney Lake Property
for
GOLDROCK RESOURCES INC.
by
Robert K. Abernethy, B.A.Sc.
November, 1987

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MINING LANDS SECTION

Fifty-nine rock samples were collected on the Raney Lake Property by geologists Tom Guoth and Mark Henrich between October 15 and October 18, 1987. The sampling program was conducted to confirm gold values and delineate enriched zones in the two known gold showings (Darke, 1986), and to test other alteration zones originally outlined by Cairn and Coster (1984). Samples were sent to Chemex Labs Ltd. of Mississauga Ontario for analysis. Analyses included fire assay with an atomic absorption finish on 20 grams of sample for gold and a 32 element geochemical package involving a nitric-aqua regia digestion followed by ICP element detection.


Twelve samples were taken from the zone denoted by Cairn and Coster as Area 1 (L5+00W, L3+00N) and eleven samples were taken from the zone denoted as Area 2 (L7+00W, L1+50N). All but two samples taken from Area 1 returned highly anomalous gold values including one sample which contained 3280 ppb Au and another which contained 1150 ppb Au. All samples taken from Area 2 returned anomalous gold values including one sample which contained greater than the 10,000 ppb Au detection limit and another sample contained 1225 ppb. Samples enriched in gold also tended to show minor, erratic enrichment in lead, molybdenum and arsenic.

All other samples contained background Au values and no noteworthy enrichment in trace elements except for sample 119128

which contained greater than 10.000 ppm (1%) zinc.

The laboratory report and sample location map are included in the appendix of this report.

Respectfully submitted

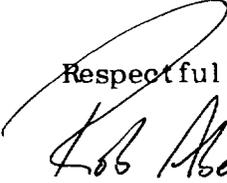

Robert K. Abernethy

Robert K. Abernethy, B.A.Sc.


REFERENCES

CAIRA. N. and COSTER. I.
1984

Geology Reports (2): J-Dex Property.
Raney Township, Ontario. Accompanied
by Geol. maps.

DARKE. KENNETH H.
1986


Preliminary Exploration Report on the
J-Dex Raney Gold Property Raney
Township, Ontario. Swayze Gold Area
for Goldrock Resources Inc. and Glen
Auden Resources Limited.

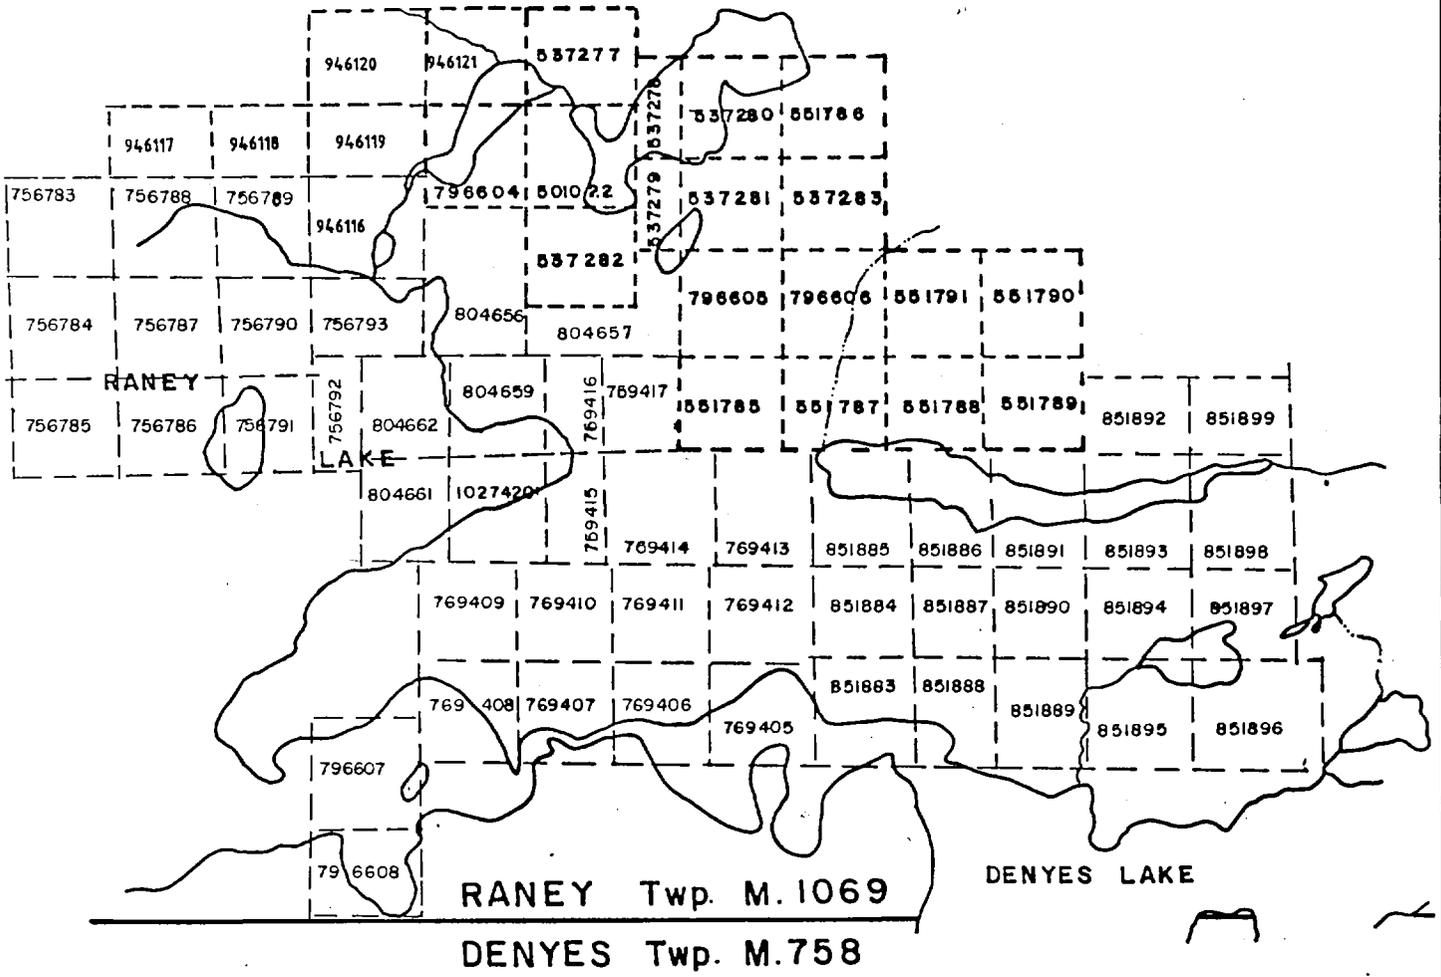

RANEY Twp. M. 1069


DENYES Twp. M. 758

DENYES LAKE

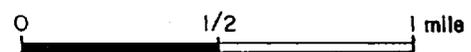

REVISIONS	KENNETH H. DARKE Consultants Limited		
	for	J-DEX RANEY	
	Title	CLAIM INDEX MAP	
	Date	June 1986	Scale: 1" = 1/2 mi. N.T.S.:
	Drawn:	C.G.	Approved:
			File:

FIG. 2

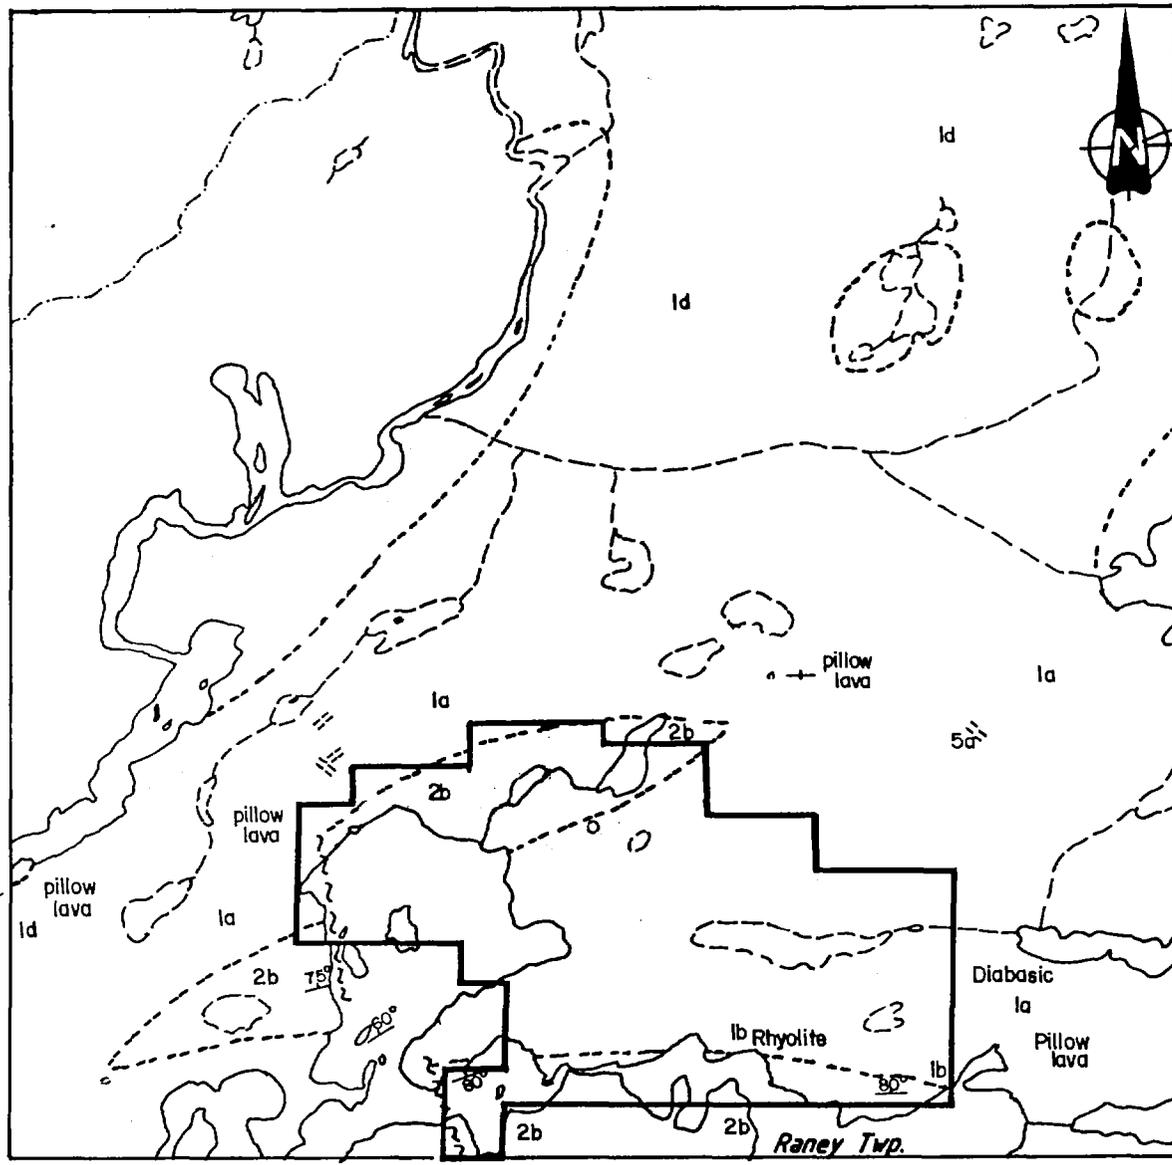

LEGEND

- 5a Quartz diabase, Olivine Diabase
- 2b Greywacke, quartzite, slate
- 1d Hornblende and chlorite schists
- 1b Rhyolite, dacite
- 1a Acid to basic lavas including basalt, andesite, gabbro, diabase

REVISIONS	KENNETH H. DARKE Consultants Limited	
	for J-DEX RANEY	
	Title	FIG. 3
	REGIONAL GEOLOGY MAP	
	From Map No. 43b	H.C. RICKABY in Vol. XLIII, Part 3
	Date JUNE 1986	Scale: 1"=1 mile N.T.S.
	Drawn: C.G.	Approved: File

A P P E N D I X



Chemex Labs Ltd.

Analytical Chemists • Geochemists • Registered Assayers
450 MATHESON BLVD., E., UNIT 54, MISSISSAUGA,
ONTARIO, CANADA L4Z-1R5
PHONE (416) 890-0310

JIDDLEMAN, I. EXI. ATIC. I. RVI

136 CEDAR ST. SOUTH
TIMMINS, ON
P4N 7W8
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Page No. 1-A
Total Pages: 2
Date: 9-NOV-87
Invoice #: I-8725103
P.O. #

CERTIFICATE OF ANALYSIS A8725103

SAMPLE DESCRIPTION	PREP CODE	Au ppb FA+AA	Al %	Ag ppm	As ppm	Ba ppm	Bc ppm	Bi ppm	Ca %	Cd ppm	Co ppm	Cr ppm	Cu ppm	Fe %	Ga ppm	Hg ppm	K %	La ppm	Mg %	Mn ppm
A22301	248 238	< 5	0.43	< 0.2	< 5	60	< 0.5	< 2	0.75	< 0.5	7	1	5	1.71	< 10	< 1	0.06	10	0.25	317
A22302	248 238	10	0.28	< 0.2	10	30	< 0.5	< 2	0.27	< 0.5	10	1	4	1.71	< 10	< 1	0.05	10	0.05	527
A22303	248 238	< 5	0.36	< 0.2	5	40	0.5	< 2	0.21	< 0.5	10	< 1	12	1.88	< 10	< 1	0.08	10	0.03	511
A22304	248 238	< 5	1.21	< 0.2	< 5	20	< 0.5	< 2	0.19	< 0.5	7	2	28	2.52	< 10	< 1	0.09	10	0.37	329
A22305	248 238	< 5	1.88	< 0.2	5	10	< 0.5	< 2	4.84	< 0.5	40	< 1	40	8.39	< 10	< 1	0.02	< 10	1.20	2890
A22306	248 238	< 5	2.57	0.2	25	60	0.5	2	1.61	< 0.5	27	4	38	5.44	< 10	< 1	0.21	< 10	0.80	1065
A22307	248 238	< 5	2.25	< 0.2	30	10	1.5	< 2	4.24	< 0.5	27	< 1	3	7.34	< 10	< 1	0.03	< 10	1.66	1710
A22308	248 238	< 5	1.04	< 0.2	< 5	50	< 0.5	< 2	1.13	< 0.5	10	14	8	1.91	< 10	1	0.14	< 10	0.68	283
A22309	248 238	10	0.84	< 0.2	< 5	50	0.5	< 2	2.18	< 0.5	10	8	1	1.84	< 10	< 1	0.17	< 10	0.72	302
A22310	248 238	115	0.54	< 0.2	< 5	60	0.5	< 2	2.29	< 0.5	8	2	2	1.54	< 10	< 1	0.16	< 10	0.71	296
A22311	248 238	>10000	0.24	2.0	5	20	< 0.5	< 2	1.27	< 0.5	3	3	20	0.36	< 10	< 1	0.08	< 10	0.12	95
A22312	248 238	60	0.62	< 0.2	< 5	50	< 0.5	< 2	2.11	< 0.5	7	3	1	1.50	< 10	< 1	0.16	< 10	0.88	287
A22313	248 238	140	0.56	< 0.2	5	60	< 0.5	< 2	0.13	< 0.5	8	3	2	1.61	< 10	< 1	0.13	< 10	0.10	242
A22314	248 238	5	0.59	< 0.2	< 5	30	< 0.5	< 2	3.76	< 0.5	7	5	1	1.46	< 10	1	0.13	< 10	0.73	325
A22315	248 238	25	0.76	< 0.2	< 5	70	< 0.5	< 2	2.09	< 0.5	8	4	2	1.60	< 10	< 1	0.25	< 10	0.87	274
A22316	248 238	1225	0.33	2.2	< 5	40	< 0.5	2	1.94	0.5	4	1	7	0.99	< 10	< 1	0.13	< 10	0.39	172
A22317	248 238	45	0.79	< 0.2	< 5	60	< 0.5	< 2	1.77	< 0.5	8	9	1	1.50	< 10	< 1	0.20	< 10	0.80	249
A22318	248 238	35	0.89	< 0.2	< 5	80	< 0.5	< 2	1.45	< 0.5	7	7	2	1.52	< 10	< 1	0.15	< 10	0.66	375
A22319	248 238	25	1.42	< 0.2	< 5	70	0.5	< 2	1.03	< 0.5	11	14	14	1.86	< 10	< 1	0.16	< 10	0.75	321
A22320	248 238	< 5	0.89	< 0.2	< 5	60	< 0.5	< 2	1.24	< 0.5	8	7	1	1.58	< 10	< 1	0.11	< 10	0.76	234
A22321	248 238	3280	0.77	1.8	20	30	< 0.5	< 2	3.75	< 0.5	8	10	7	1.74	< 10	< 1	0.10	< 10	0.65	409
A22322	248 238	385	0.94	< 0.2	10	130	< 0.5	< 2	1.67	< 0.5	5	< 1	4	1.71	< 10	< 1	0.42	< 10	0.52	221
A22323	248 238	625	1.18	< 0.2	< 5	10	< 0.5	< 2	3.19	< 0.5	10	14	12	2.08	< 10	< 1	0.05	< 10	0.99	378
A22324	248 238	200	1.07	< 0.2	< 5	70	< 0.5	< 2	2.17	< 0.5	9	4	7	1.76	< 10	< 1	0.23	< 10	0.71	285
A22325	248 238	80	1.72	< 0.2	10	70	< 0.5	< 2	1.32	< 0.5	17	19	28	3.31	< 10	< 1	0.23	< 10	1.09	409
A22326	248 238	< 5	1.46	< 0.2	< 5	60	< 0.5	< 2	1.36	< 0.5	11	12	15	2.33	< 10	< 1	0.23	< 10	0.84	418
A22327	248 238	500	0.18	0.6	< 5	< 10	< 0.5	< 2	2.79	< 0.5	< 1	2	3	0.35	< 10	< 1	0.01	< 10	0.13	197
A22328	248 238	115	0.26	< 0.2	< 5	10	< 0.5	< 2	4.18	< 0.5	< 1	2	2	0.38	< 10	< 1	0.05	< 10	0.16	284
A22329	248 238	30	1.02	< 0.2	5	30	< 0.5	< 2	6.82	< 0.5	7	6	15	1.48	< 10	< 1	0.15	< 10	0.65	466
A22330	248 238	1150	1.98	0.2	5	70	< 0.5	< 2	1.75	< 0.5	18	21	34	3.21	< 10	< 1	0.29	< 10	1.21	381
A22331	248 238	160	2.01	< 0.2	10	50	< 0.5	< 2	2.05	< 0.5	10	18	24	3.38	< 10	< 1	0.23	< 10	1.33	421
A22332	248 238	< 5	0.41	0.2	< 5	10	< 0.5	< 2	1.48	< 0.5	< 1	14	4	0.59	< 10	< 1	0.02	< 10	0.22	185
A22333	248 238	< 5	0.15	< 0.2	< 5	10	< 0.5	< 2	2.31	< 0.5	< 1	2	5	0.67	< 10	< 1	0.01	< 10	0.09	741
A22334	248 238	5	5.11	0.2	75	30	< 0.5	< 2	2.25	< 0.5	42	180	145	11.90	< 10	< 1	0.02	< 10	2.97	1425
A22335	248 238	10	4.14	< 0.2	15	10	< 0.5	< 2	5.46	< 0.5	35	165	114	6.16	< 10	< 1	0.01	< 10	2.92	914
A22336	248 238	5	4.18	< 0.2	15	20	< 0.5	< 2	4.21	< 0.5	41	161	121	8.74	< 10	< 1	0.01	< 10	3.30	1495
A22337	248 238	< 5	4.90	< 0.2	< 5	10	< 0.5	< 2	2.86	< 0.5	44	61	100	8.48	< 10	< 1	< 0.01	< 10	3.56	1240
A22338	248 238	< 5	3.93	0.2	15	< 10	< 0.5	< 2	3.52	< 0.5	40	198	106	7.12	< 10	< 1	< 0.01	< 10	2.75	1265
A22339	248 238	< 5	5.16	< 0.2	< 5	50	< 0.5	< 2	2.38	< 0.5	45	174	122	9.44	< 10	< 1	0.05	< 10	2.79	2050
A22340	248 238	< 5	2.79	< 0.2	25	20	< 0.5	< 2	4.99	< 0.5	34	118	98	6.69	< 10	< 1	0.07	< 10	2.73	1075

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Chemex Labs Ltd.
Analytical Chemists • Geochemists • Registered Assayers
450 MATHESON BLVD, E., UNIT 54, MISSISSAUGA,
ONTARIO, CANADA L4Z-1R5
PHONE (416) 890-0310

136 CEDAR ST. SOUTH
TIMMINS, ON
P4N 7W8
Project: M-69
Comments: ATTN: HAROLD BENT

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SAMPLE DESCRIPTION	PREP CODE	Mo ppm	Na %	Ni ppm	P ppm	Pb ppm	Sb ppm	Se ppm	Sr ppm	Ti %	Tl ppm	U ppm	V ppm	W ppm	Zn ppm
A22301	248 238	< 1	0.06	14	370	< 2	< 5	< 10	29	< 0.01	< 10	< 10	3	< 5	64
A22302	248 238	< 1	0.05	10	400	< 2	< 5	< 10	16	< 0.01	< 10	< 10	3	< 5	76
A22303	248 238	< 1	0.06	18	440	< 2	< 5	< 10	21	< 0.01	< 10	< 10	2	< 5	115
A22304	248 238	< 1	0.05	12	280	< 2	< 5	< 10	17	< 0.01	< 10	< 10	8	< 5	69
A22305	248 238	< 1	0.03	8	470	6	5	< 10	84	< 0.01	< 10	< 10	99	< 5	126
A22306	248 238	< 1	0.02	57	840	< 2	< 5	< 10	26	0.58	< 10	< 10	63	< 5	115
A22307	248 238	< 1	0.02	4	530	< 2	< 5	< 10	89	< 0.01	< 10	< 10	102	< 5	92
A22308	248 238	< 1	0.05	23	450	< 2	< 5	< 10	41	< 0.01	< 10	< 10	11	< 5	60
A22309	248 238	< 1	0.04	21	450	< 2	< 5	< 10	96	< 0.01	< 10	< 10	6	< 5	55
A22310	248 238	< 1	0.03	18	440	< 2	< 5	< 10	94	< 0.01	< 10	< 10	3	< 5	42
A22311	248 238	< 1	0.02	10	150	6	< 5	< 10	51	< 0.01	< 10	< 10	1	< 5	11
A22312	248 238	< 1	0.04	15	430	< 2	< 5	< 10	110	< 0.01	< 10	< 10	5	< 5	43
A22313	248 238	< 1	0.03	20	470	< 2	< 5	< 10	13	< 0.01	< 10	< 10	6	< 5	33
A22314	248 238	< 1	0.03	19	400	< 2	< 5	< 10	181	< 0.01	< 10	< 10	6	< 5	40
A22315	248 238	< 1	0.04	21	460	< 2	< 5	< 10	126	< 0.01	< 10	< 10	6	< 5	38
A22316	248 238	< 1	0.02	11	180	178	< 5	< 10	121	< 0.01	< 10	< 10	2	< 5	268
A22317	248 238	< 1	0.05	17	370	< 2	< 5	< 10	96	< 0.01	< 10	< 10	6	< 5	52
A22318	248 238	< 1	0.08	17	400	< 2	< 5	< 10	64	< 0.01	< 10	< 10	7	< 5	45
A22319	248 238	< 1	0.09	27	470	< 2	< 5	< 10	70	< 0.01	< 10	< 10	10	< 5	63
A22320	248 238	< 1	0.07	18	370	< 2	< 5	< 10	68	< 0.01	< 10	< 10	7	< 5	41
A22321	248 238	34	0.03	16	310	4	< 5	< 10	315	< 0.01	< 10	< 10	10	< 5	23
A22322	248 238	65	0.02	8	460	< 2	< 5	< 10	126	< 0.01	< 10	< 10	9	< 5	35
A22323	248 238	1	0.04	15	340	2	< 5	< 10	278	< 0.01	< 10	< 10	24	< 5	43
A22324	248 238	< 1	0.02	16	390	< 2	< 5	< 10	170	< 0.01	< 10	< 10	9	< 5	56
A22325	248 238	< 1	0.02	31	630	2	< 5	< 10	112	< 0.01	< 10	< 10	23	< 5	82
A22326	248 238	< 1	0.04	23	490	< 2	< 5	< 10	86	< 0.01	< 10	< 10	19	< 5	51
A22327	248 238	13	0.01	4	70	344	< 5	< 10	224	< 0.01	< 10	< 10	1	< 5	26
A22328	248 238	< 1	0.01	5	130	42	< 5	< 10	346	< 0.01	< 10	< 10	2	< 5	18
A22329	248 238	< 1	0.03	12	350	22	< 5	< 10	492	< 0.01	< 10	< 10	12	< 5	46
A22330	248 238	< 1	0.03	32	630	4	< 5	< 10	126	< 0.01	< 10	< 10	28	< 5	81
A22331	248 238	< 1	0.03	29	580	< 2	< 5	< 10	137	< 0.01	< 10	< 10	25	< 5	93
A22332	248 238	< 1	0.02	25	190	6	< 5	< 10	80	< 0.01	< 10	< 10	4	< 5	14
A22333	248 238	< 1	0.01	4	120	< 2	< 5	< 10	46	< 0.01	< 10	< 10	6	< 5	9
A22334	248 238	< 1	0.03	82	260	< 2	5	< 10	17	< 0.01	< 10	< 10	247	< 5	162
A22335	248 238	< 1	0.04	92	250	< 2	5	< 10	104	< 0.01	< 10	< 10	172	< 5	97
A22336	248 238	< 1	0.04	76	260	< 2	< 5	< 10	23	< 0.01	< 10	< 10	192	< 5	99
A22337	248 238	< 1	0.01	66	290	< 2	5	< 10	37	0.01	< 10	< 10	293	< 5	97
A22338	248 238	< 1	0.01	100	230	2	< 5	< 10	25	0.46	< 10	< 10	203	< 5	75
A22339	248 238	< 1	0.01	99	270	< 2	< 5	< 10	13	< 0.01	< 10	< 10	166	< 5	113
A22340	248 238	< 1	0.03	72	230	< 2	< 5	< 10	19	< 0.01	< 10	< 10	103	< 5	88

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Chemex Labs Ltd.
Analytical Chemists • Geochemists • Registered Assayers
450 MATHESON BLVD., E., UNIT 54, MISSISSAUGA,
ONTARIO, CANADA L4Z-1R5

PHONE (416) 890-0310

To: MIDDLETON, R.S. EXPLORATION SERVICES

136 CEDAR ST. SOUTH
TIMMINS, ON
P4N 7W8

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SAMPLE DESCRIPTION	PREP CODE	Au ppb Pt+AA	Al %	Ag ppb	As ppb	Ba ppb	Bc ppb	Bi ppb	Ca %	Cd ppb	Co ppb	Cr ppb	Cu ppb	Fe %	Ga ppb	Hg ppb	K %	La ppm	Mg %	Mn ppm
A22341	248 238	< 5	2.60	0.2	40	10	< 0.5	< 2	6.19	< 0.5	45	141	97	6.61	< 10	1	0.02	< 10	3.86	1245
A22342	248 238	< 5	2.33	0.2	5	60	< 0.5	< 2	2.03	< 0.5	49	23	124	4.75	< 10	< 1	0.11	< 10	1.46	579
A22343	248 238	< 5	2.47	0.2	< 5	50	< 0.5	< 2	1.72	< 0.5	48	28	126	5.03	< 10	< 1	0.10	< 10	1.56	594
A22344	248 238	< 5	2.33	0.2	10	100	< 0.5	< 2	1.87	< 0.5	41	< 1	63	4.59	< 10	1	0.13	< 10	1.56	666
A22345	248 238	< 5	2.31	0.2	< 5	50	< 0.5	< 2	2.37	< 0.5	41	< 1	52	4.70	< 10	< 1	0.06	< 10	1.43	721
A22347	248 238	< 5	3.37	0.2	10	10	< 0.5	< 2	2.17	< 0.5	46	< 1	55	6.38	< 10	< 1	< 0.01	< 10	2.39	987
A22348	248 238	< 5	2.75	0.2	< 5	20	< 0.5	< 2	1.48	< 0.5	35	25	46	5.39	< 10	< 1	< 0.01	< 10	1.73	1035
A22349	248 238	< 5	2.06	0.2	< 5	20	< 0.5	< 2	1.64	< 0.5	34	22	54	4.27	< 10	< 1	0.01	< 10	1.18	714
A22350	248 238	< 5	2.51	0.2	< 5	10	< 0.5	< 2	1.35	< 0.5	37	14	96	5.51	< 10	< 1	0.01	< 10	1.46	1170
119126	248 238	< 5	2.57	0.2	10	10	< 0.5	< 2	0.35	< 0.5	12	28	67	7.83	< 10	< 1	0.05	< 10	2.52	638
119127	248 238	< 5	2.35	0.2	15	< 10	< 0.5	< 2	1.05	< 0.5	37	27	86	5.21	< 10	< 1	0.01	< 10	1.88	766
119128	248 238	< 5	0.82	0.2	10	30	< 0.5	< 2	0.14	32.0	16	3	95	9.88	< 10	< 1	0.12	10	0.54	326
119129	248 238	< 5	0.31	0.2	5	< 10	< 0.5	< 2	5.58	< 0.5	24	< 1	128	6.04	< 10	< 1	0.01	< 10	0.28	689
119130	248 238	< 5	2.41	0.2	5	20	< 0.5	< 2	1.68	< 0.5	39	14	87	5.32	< 10	< 1	0.01	< 10	1.41	1145
119131	248 238	< 5	2.41	0.2	< 5	20	< 0.5	< 2	1.13	< 0.5	33	23	61	5.11	< 10	1	0.01	< 10	1.54	939
119132	248 238	< 5	2.32	0.2	< 5	20	< 0.5	< 2	1.17	< 0.5	38	20	64	4.99	< 10	1	0.01	< 10	1.55	843
119133	248 238	< 5	3.01	0.2	15	10	< 0.5	< 2	2.41	< 0.5	34	14	92	5.82	< 10	< 1	< 0.01	< 10	1.65	1320
119134	248 238	< 5	0.34	0.6	< 5	< 10	< 0.5	< 2	8.74	< 0.5	7	< 1	142	5.73	< 10	< 1	< 0.01	< 10	0.29	975
119135	248 238	< 5	1.69	0.2	< 5	10	< 0.5	< 2	0.61	< 0.5	26	24	60	6.19	< 10	< 1	0.04	< 10	1.64	552

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Chemex Labs Ltd.
 Analytical Chemists • Geochemists • Registered Assayers
 450 MATTHESON BLVD. E., UNIT 54, MISSISSAUGA,
 ONTARIO, CANADA L4Z-1R5
 PHONE (416) 890-0310

136 CEDAR ST. SOUTH
 TIMMINS, ON
 P4N 7W8
 Project: MF-69
 Comments: ATTN: HAROLD BENT

** No. 1B
 Tot. Pages: 2
 Date: 9-NOV-87
 Invoice #: I-8725103
 P.O. #

CERTIFICATE OF ANALYSIS A8725103

SAMPLE DESCRIPTION	PREP CODE	Mo ppm	Na %	Ni ppm	P ppm	Pb ppm	Sb ppm	Se ppm	Sr ppm	Ti %	Tl ppm	U ppm	V ppm	W ppm	Zn ppm
A22341	248 238	< 1	0.09	164	240	< 2	< 5	< 10	34	< 0.01	< 10	< 10	103	5	68
A22342	248 238	< 1	0.03	48	500	< 2	< 5	< 10	13	0.64	< 10	< 10	217	< 5	99
A22343	248 238	< 1	0.04	46	530	< 2	< 5	< 10	12	0.72	< 10	< 10	258	< 5	120
A22344	248 238	< 1	0.02	25	620	< 2	< 5	< 10	11	0.57	< 10	< 10	200	< 5	151
A22345	248 238	< 1	0.03	18	700	2	< 5	< 10	13	0.57	< 10	< 10	229	< 5	129
A22347	248 238	< 1	0.02	28	560	< 2	< 5	< 10	21	0.69	< 10	< 10	408	< 5	129
A22348	248 238	< 1	0.03	36	470	< 2	< 5	< 10	14	0.76	< 10	< 10	215	< 5	89
A22349	248 238	< 1	0.03	38	440	< 2	< 5	< 10	26	0.70	< 10	< 10	187	< 5	74
A22350	248 238	< 1	0.03	37	400	< 2	< 5	< 10	12	0.73	< 10	< 10	237	< 5	79
I19126	248 238	< 1	0.03	10	490	< 2	< 5	< 10	7	0.34	< 10	< 10	314	< 5	85
I19127	248 238	< 1	0.04	39	420	< 2	5	< 10	9	0.69	< 10	< 10	273	< 5	86
I19128	248 238	< 1	0.02	41	250	< 2	< 5	< 10	3	< 0.01	< 10	< 10	32	< 5	>10000
I19129	248 238	< 1	0.01	22	110	< 2	5	< 10	85	0.02	< 10	< 10	23	< 5	286
I19130	248 238	< 1	0.02	36	390	< 2	< 5	< 10	14	0.63	< 10	< 10	226	< 5	115
I19131	248 238	< 1	0.03	33	460	< 2	< 5	< 10	14	0.72	< 10	< 10	218	< 5	77
I19132	248 238	< 1	0.03	36	400	2	< 5	< 10	23	0.68	< 10	< 10	206	< 5	100
I19133	248 238	< 1	0.02	32	370	< 2	< 5	< 10	31	0.63	< 10	< 10	259	< 5	94
I19134	248 238	< 1	< 0.01	26	100	4	< 5	< 10	129	0.01	< 10	< 10	21	< 5	26
I19135	248 238	< 1	0.04	26	410	< 2	< 5	< 10	7	0.20	< 10	< 10	187	< 5	49

CERTIFICATION :

[Handwritten signature]



Chemex Labs Ltd.

Analytical Chemists * Geochemists * Registered Assayers
212 BROOKSBANK AVE., NORTH VANCOUVER,
BRITISH COLUMBIA, CANADA V7J-2C1

PHONE (604) 984-0221

136 CEDAR ST. SOUTH

TIMMINS, ON

P4N 7W8

* INVOICE NUMBER 18725103 *

BILLING INFORMATION

Date : 9-NOV-87
Project : M-69
P.O. # :
Account : FSD

Billing : For analysis performed on
Certificate A8725103

Terms : Net payment in 30 Days
1.5% per month (18% per annum)
charged on overdue accounts.

Please remit payments to:

CHEMEX LABS LTD.
212 Brooksbank Ave.,
North Vancouver, B.C.
Canada V7J-2C1

CHEMEX CODE	ANALYSIS DESCRIPTION	SAMPLES ANALYZED	UNIT PRICE	AMOUNT
982	Au ppb			
921	AI			
922	Ag			
923	As			
924	Ba			
925	Bc			
926	Bi			
927	Ca			
928	Cd			
929	Co			
930	Cr			
931	Cu			
932	Fe			
933	Ga			
934	Hg			
935	K			
936	La			
937	Mg			
938	Mn			
939	Mo			
940	Na			
941	Ni			
942	P			
943	Pb			
944	Sb			
945	Sc			
946	Sr			
947	Ti			
948	Tl			
949	U			
950	V			
950	W			
950	Zn			
Sample preparation and other charges :				
248	Rock prep - Zr rings	59	3.50	206.50
238	ICP aqua-regia digestion	59	0.00	0.00
Total Cost \$				1062.00
TOTAL PAYABLE \$				1062.00

Approved S.C.D. Nadeau



Ministry of
Northern Development
and Mines



41015SW0003 2.10574 RANEY

900


Ontario

Ministère du
Développement du Nord
et des Mines

February 5, 1988

Your File: 320/87
Our file: 2.10574

Mining Recorder
Ministry of Northern Development and Mines
60 Wilson Avenue
Timmins, Ontario
P4N 2S7

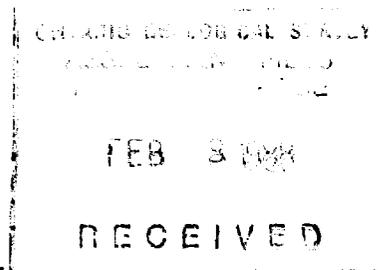

Dear Sir:

RE: Notice of Intent dated January 21, 1988
Data for Assaying submitted on Mining Claims
P 769409 et al in the Township of Raney

The assessment work credits, as listed with the above-mentioned Notice of Intent, have been approved as of the above date.

Please inform the recorded holder of these mining claims and so indicate on your records.

Yours sincerely,

W.R. Cowan, Manager
Mining Lands Section
Mines and Minerals Division

Whitney Block, Room 6610
Queen's Park
Toronto, Ontario
M7A 1W3

Telephone: (416) 965-4888

SH:p1
Enclosure: Technical Assessment Work Credits

cc: Mr. G.H. Ferguson
Mining & Lands Commissioner
Toronto, Ontario

Resident Geologist
Timmins, Ontario

Goldrock Resources Inc.
P.O. Box 1637
Timmins, Ontario
P4N 7W8



Ontario

Recorded Holder Goldrock Resources Inc.

Township ~~XXXX~~ Raney Township

Type of survey and number of Assessment days credit per claim	Mining Claims Assessed
Geophysical Electromagnetic _____ days Magnetometer _____ days Radiometric _____ days Induced polarization _____ days Other _____ days Section 77 (19) See "Mining Claims Assessed" column Geological _____ days Geochemical _____ days Man days <input type="checkbox"/> Airborne <input type="checkbox"/> Special provision <input type="checkbox"/> Ground <input type="checkbox"/> <input type="checkbox"/> Credits have been reduced because of partial coverage of claims. <input type="checkbox"/> Credits have been reduced because of corrections to work dates and figures of applicant.	<p>\$1,062.00 SPENT ON ASSAYING SAMPLES TAKEN FROM MINING CLAIMS:</p> <p>P 501022 537282 769404-06-09 804656-57</p> <p>70.8 days credit allowed which may be grouped in accordance with Section 76(6) of the Mining Act R.S.O. 1980</p>

Special credits under section 77 (16) for the following mining claims

No credits have been allowed for the following mining claims

not sufficiently covered by the survey insufficient technical data filed

Assay costs only are an allowable expense under Section 77(19).

The Mining Recorder may reduce the above credits if necessary in order that the total number of approved assessment days recorded on each claim does not exceed the maximum allowed as follows: Geophysical - 80; Geological - 40; Geochemical - 40; Section 77(19) - 60.



Ministry of Northern Development and Mines

Report of Work
(Geophysical, Geological, Geochemical and Expenditures)

- Instructions: - Please type or print.
- If number of mining claims traversed exceeds space on this form, attach a list.
Note: - Only days credits calculated in the "Expenditures" section may be entered in the "Expend. Days Cr." columns.
- Do not use shaded areas below.

#320/87
Mining Act 2.10574

Type of Survey(s) LITHOGEOCHEMICAL SURVEY	Township or Area RANEY TWP
Claim Holder(s) GOLDROCK RESOURCES INC.	Prospector's Licence No. T-4715
Address P.O. Box 1637, TIMMINS, ONTARIO, P4N 7W8	
Survey Company ROBERT S. MIDDLETON EXPLORATION SERVICES INC.	Date of Survey (from & to) Day Mo. Yr. 14 10 87 Day Mo. Yr. 18 10 87
Total Miles of line Cut NONE	
Name and Address of Author (of Geo-Technical report) ROBERT ABERNETHY, 136 CEDAR SOUTH, TIMMINS, ON. P4N 7W8	

Credits Requested per Each Claim in Columns at right

Special Provisions	Geophysical	Days per Claim
For first survey: Enter 40 days (This includes line setting)	- Electromagnetic Magnetometer	
For each additional survey: using the same grid: Enter 20 days (for each)	- Radiometric Geological Geochemical	

Man Days

Complete reverse side and enter total(s) here	Geophysical	Days per Claim
	- Electromagnetic Magnetometer	
	- Radiometric	
	- Other Geological Geochemical	

Airborne Credits

Note: Special provisions credits do not apply to Airborne Surveys.	Geophysical	Days per Claim
	- Electromagnetic Magnetometer	
	- Radiometric	

Mining Claims Traversed (List in numerical sequence)

Prefix	Mining Claim Number	Expend. Days Cr.
P	769409	20
	769412	20
	769416	29.3
	851888	5
	851894	5
	851895	5
	851897	5
	804656	18.3
	804657	18.3
	804659	29.3
	905890	20
	905891	20
	905892	20
	905893	20
	905894	20
	905895	20
	905896	20
	1027420	10

Expenditures (excludes power stripping)

Type of Work Performed
LITHOGEOCHEMICAL SURVEY (ASSAYING)

Performed on Claim(s) **769409, 769406, 501022, 796604, 537282 & 804656, 804657**

Calculation of Expenditure Days Credits

Total Expenditures **\$ 4,594.16** ÷ Total Days Credits **15** = **306.3**

Instructions
Total Days Credits may be apportioned at the claim holder's choice. Enter number of days credits per claim selected in columns at right.

RECORDED
NOV 19 1987

Total number of mining claims covered by this report of work. **18**

For Office Use Only

Total Days Cr. Recorded 305.2	Date Recorded Nov. 19/87	Mining Recorder <i>[Signature]</i>
Date Approved Nov. 18/87	Date Recorded	Branch Director

Date **Nov. 18/87** Recorder Holder or Agent (Signature) *[Signature]*

Certification Verifying Report of Work

I hereby certify that I have a personal and intimate knowledge of the facts set forth in the Report of Work annexed hereto, having performed the work or witnessed same during and/or after its completion and the annexed report is true.

Name and Postal Address of Person Certifying
ROBERT ABERNETHY, % RSMES, 136 CEDAR SOUTH, TIMMINS, ON. P4N 7W8

Date Certified **Nov 18 / 1987** Certified by (Signature) *[Signature]*


AREAS WITHDRAWN FROM DISPOSITION

- M.R.O. - MINING RIGHTS ONLY
- S.R.O. - SURFACE RIGHTS ONLY
- M.+S. - MINING AND SURFACE RIGHTS

Description Order No. Date Disposition File

*SMA withdrawn from status
15A+MA withdrawn from status
15A+MA 1/18/86 cancelled*

HELLYER TWP.

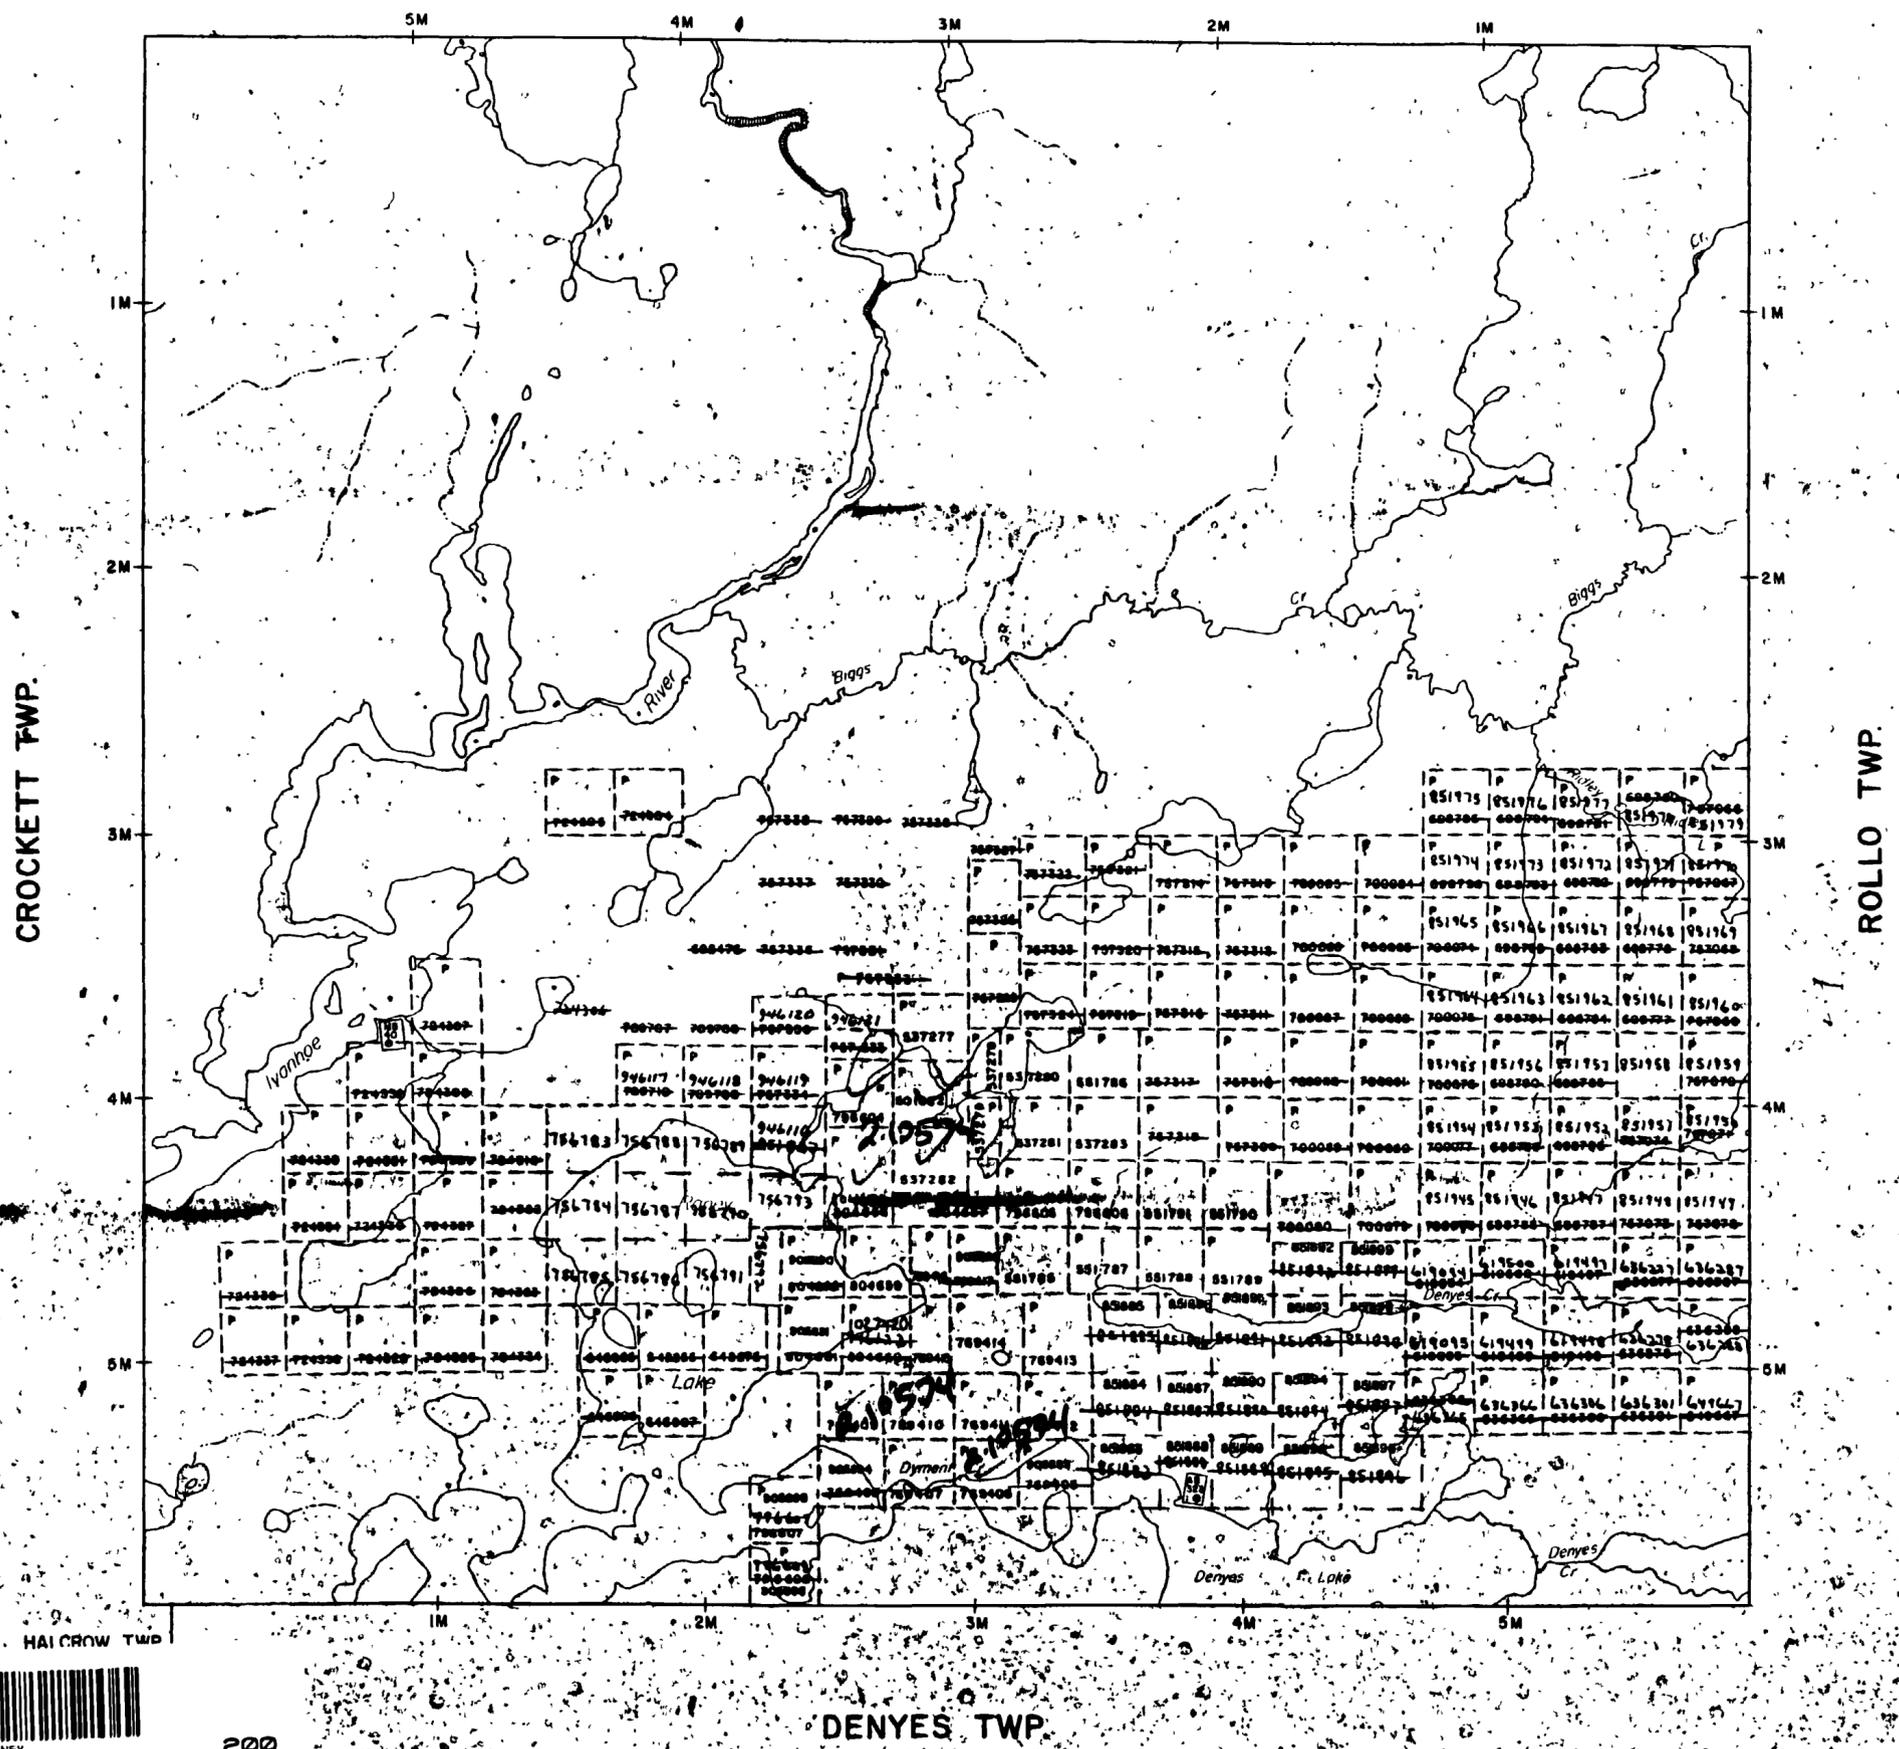


LEGEND

- HIGHWAY AND ROUTE No.
- OTHER ROADS
- TRAILS
- SURVEYED LINES
- TOWNSHIPS, BASE LINES, ETC.
- LOTS, MINING CLAIMS, PARCELS, ETC.
- UNSURVEYED LINES:
- LOT LINES
- PARCEL BOUNDARY
- MINING CLAIMS ETC.
- RAILWAY AND RIGHT OF WAY
- UTILITY LINES
- NON-PERENNIAL STREAM
- FLOODING OR FLOODING RIGHTS
- SUBDIVISION OR COMPOSITE PLAN
- RESERVATIONS
- ORIGINAL SHORELINE
- MARSH OR MUSKEG
- MINES
- TRAVERSE MONUMENT

DISPOSITION OF CROWN LANDS

TYPE OF DOCUMENT	SYMBOL
PATENT, SURFACE & MINING RIGHTS	●
" SURFACE RIGHTS ONLY	○
" MINING RIGHTS ONLY	◐
LEASE, SURFACE & MINING RIGHTS	■
" SURFACE RIGHTS ONLY	□
" MINING RIGHTS ONLY	◑
LICENCE OF OCCUPATION	▼
ORDER-IN-COUNCIL	OC
RESERVATION	⊙
CANCELLED	⊖
SAND & GRAVEL	⊙

NOTE: MINING RIGHTS IN PARCELS PATENTED PRIOR TO MAY 6, 1913, VESTED IN ORIGINAL PATENTEE BY THE PUBLIC LANDS ACT, R.S.O. 1970, CHAP. 300, SEC. 63, SUBSEC 1.

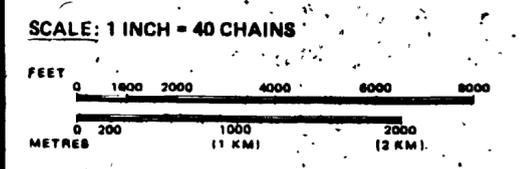

TOWNSHIP

RANEY

M.N.R. ADMINISTRATIVE DISTRICT

CHAPLEAU

MINING DIVISION

PORCUPINE

LAND TITLES / REGISTRY DIVISION


SUDBURY

OCT 28 1987

Ontario Ministry of Natural Resources Land Management Branch

Date MARCH, 1985 Number G-3245



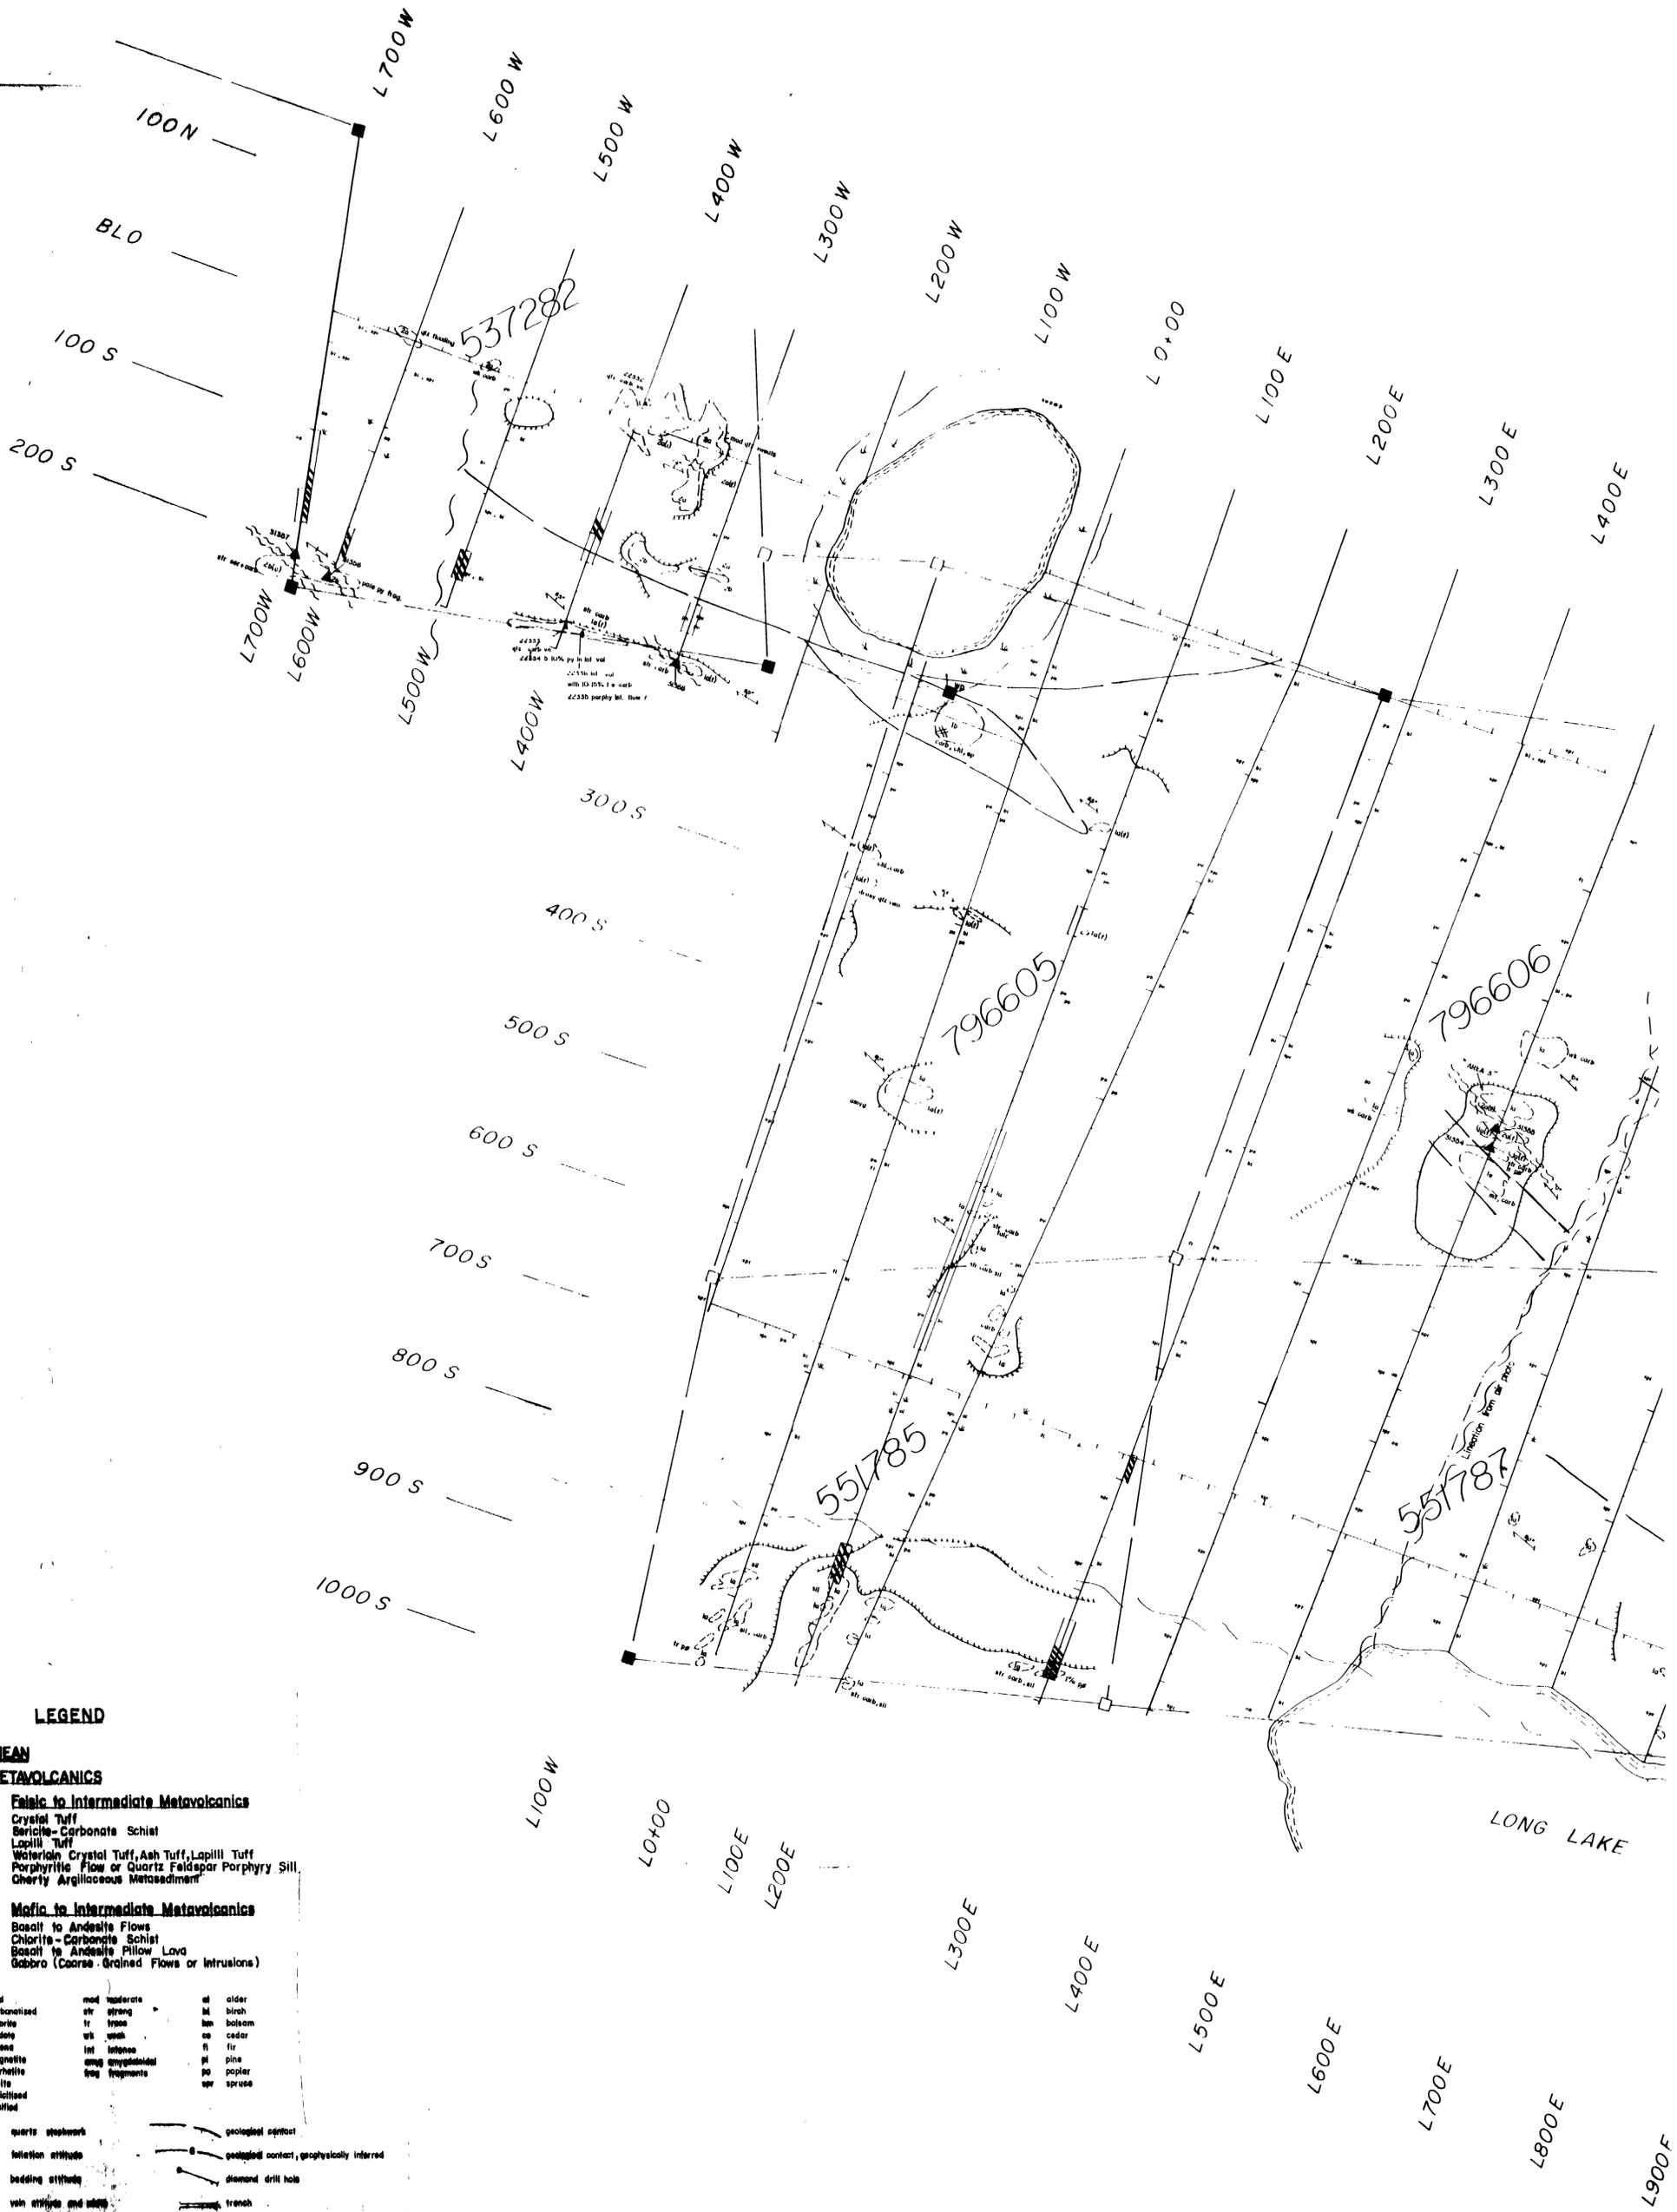

LEGEND

ARCHEAN

METAVOLCANICS

Felsic to Intermediate Metavolcanics

- 2a Crystal Tuff
- 2a(f) Sericite-Carbonate Schist
- 2b Lapilli Tuff
- 2c Waterlain Crystal Tuff, Ash Tuff, Lapilli Tuff
- 2d Porphyritic Flow or Quartz Feldspar Porphyry Sill
- 2e Cherty Argillaceous Metasediment


Mafic to Intermediate Metavolcanics

- 1a Basalt to Andesite Flows
- 1a(f) Chlorite-Carbonate Schist
- 1b Basalt to Andesite Pillow Lava
- 1c Gabbro (Coarse Grained Flows or Intrusions)

- | | | |
|-----------------|------------------|-----------|
| Au gold | mod moderate | al alder |
| carb carbonized | str strong | bl birch |
| ch chert | tr trace | ba balsam |
| ep epidote | wk weak | ca cedar |
| gn garnet | int intense | fr fir |
| mg magnetite | ang amygdaloidal | pl pine |
| py pyrite | frag fragments | pp poplar |
| pr pyrrhotite | | sp spruce |
| sil silicified | | |

- | | |
|-----------------------|--|
| quartz streakwork | geological contact |
| bedding attitude | geological contact, geophysically inferred |
| vain strike and width | diamond drill hole |
| cutting | trench |
| step of fault | ▲ sample number and location |
| step of fault | ■ site part, location known |
| step of fault | □ site part, location assumed |
| step of fault | ○ site part, location uncertain |



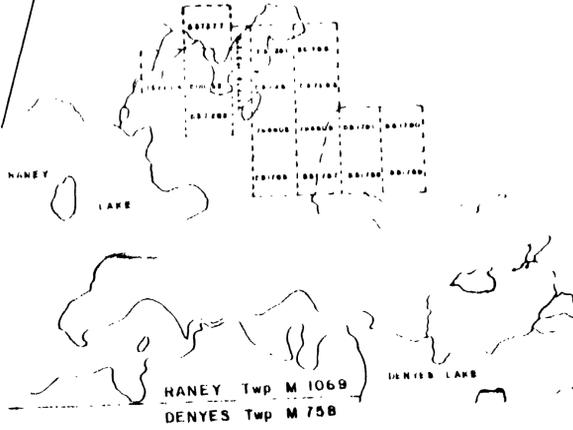

SOUTH SHEET

REVISIONS	ROBERT S. MIDDLETON EXPLORATION SERVICES INC.
	J-28X
	MINING EXPLORATION LTD
	GEOLOGY



LEGEND

ARCHEAN

METAVOLCANICS

Felsic to Intermediate Metavolcanics

- 2a Crystal Tuff
- 2a(f) Sericite-Carbonate Schist
- 2b Lapilli Tuff
- 2c Waterlain Crystal Tuff, Ash Tuff, Lapilli Tuff
- 2d Porphyritic Flow or Quartz Feldspar Porphyry Sill
- 2e Cherty Argillaceous Metasediment

Mafic to Intermediate Metavolcanics



- 1a Basalt to Andesite Flows
- 1a(f) Chlorite-Carbonate Schist
- 1b Basalt to Andesite Pillow Lava
- 1c Gabbro (Coarse Grained Flows or Intrusions)

- Au gold
- carb carbonized
- chl chlorite
- ep epidote
- gn galena
- mt magnetite
- py pyrite
- ser sericitized
- sil silicified
- mod moderate
- str strong
- wk weak
- al alder
- bl birch
- bm balsam
- ce cedar
- fi fir
- pi pine
- pa poplar
- spr spruce

- quartz stockwork
- foliation attitude
- bedding attitude
- vein attitude and width
- outcrop
- edge of ridge
- fault, showing direction of slip
- shear zone
- geological contact
- geological contact, geophysically inferred
- diamond drill hole
- trench
- ▲ 1:2500 sample number and location
- claim post, location known
- claim post, location assumed
- witness post indicating direction to true post location



LAKE

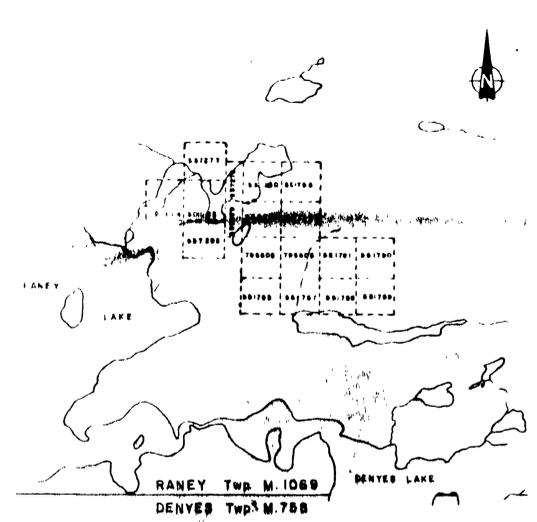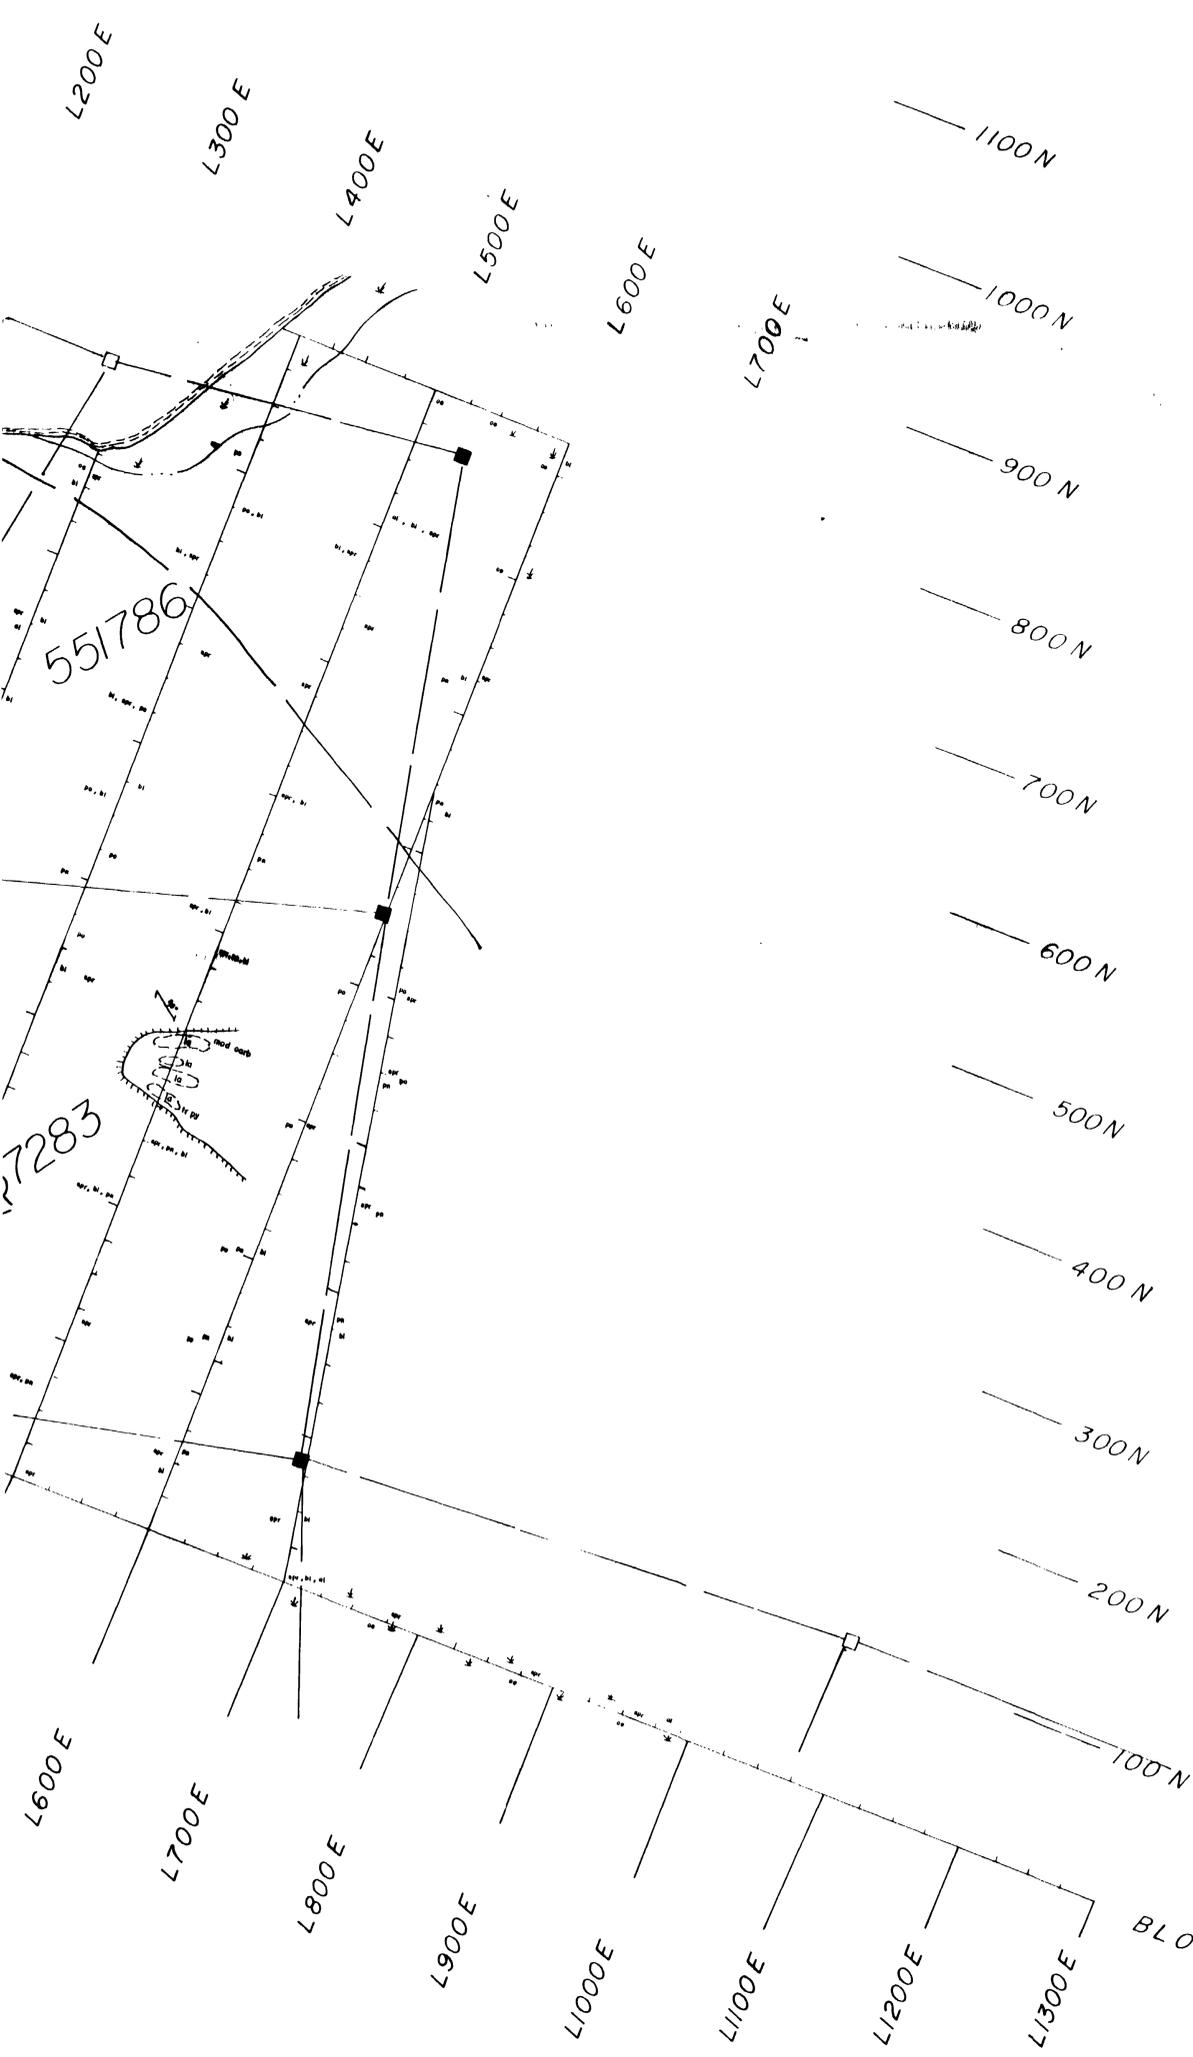

NORTH SHEET

REVISIONS	ROBERT S. MIDDLETON EXPLORATION SERVICES INC.
	J-DEX
	MINING EXPLORATION LTD
	GEOLOGY
	Fig. 5
	Dec / 86 1:50,000 N.T.S.: 41 O/NE

2105/14



LEGEND

ARCHEAN

Mafic Intrusive Rocks

- 9 Diabase
- Invasive Contact

METAVOLCANICS

Felsic to Intermediate Metavolcanics


- 2a Crystal Tuff and Rhyolitic Ash
- 2a(f) Quartz Sericite-Carbonate Schist
- 2b Waterlain Crystal Tuff, Ash Tuff, Lapilli Tuff
- 2c Porphyritic Flow or Feldspar Porphyry Sill
- 2d Cherty Argillaceous Metasediment

Mafic to Intermediate Metavolcanics

- 1a Basalt to Andesite Flows (Massive, fine-grained)
- 1a(f) Chlorite-Carbonate Schist
- 1b Basalt to Andesite Pillow Lava Flow
- 1c Gabbro, Tholeiitic Flow (Coarse Grained Flows)
- 1c(f) Chlorite Carbonate Schist


- | | | |
|-----------------|-------------|-----------|
| ab basalt | md moderate | ol older |
| carb carbonized | str strong | bl black |
| chl chlorite | tr trace | ca cedar |
| mag magnetite | wt weak | pn pine |
| py pyrite | | pp poplar |
| ser sericized | | sp spruce |
| sil silicified | | |

- quartz stockwork
- injection attitude
- bedding attitude
- vein attitude and width
- outcrop
- edge of ridge
- fault, showing direction of slip
- shear zone
- geological contact
- disused drill hole
- trench
- sample number and location
- chain post, location known
- chain post, location assumed
- chain post indicating direction to true post location

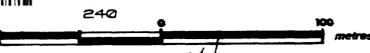

*John C. ...
North Carolina*

ROBERT S. MIDDLETON EXPLORATION SERVICES INC.		
J-DEX (B) (21 claims)		
GEOLOGY (NORTH SHEET)		
Date: NOV. 1984	Scale: 1:2000	N.T.S.
Drawn: C6	Approved:	File: M-69

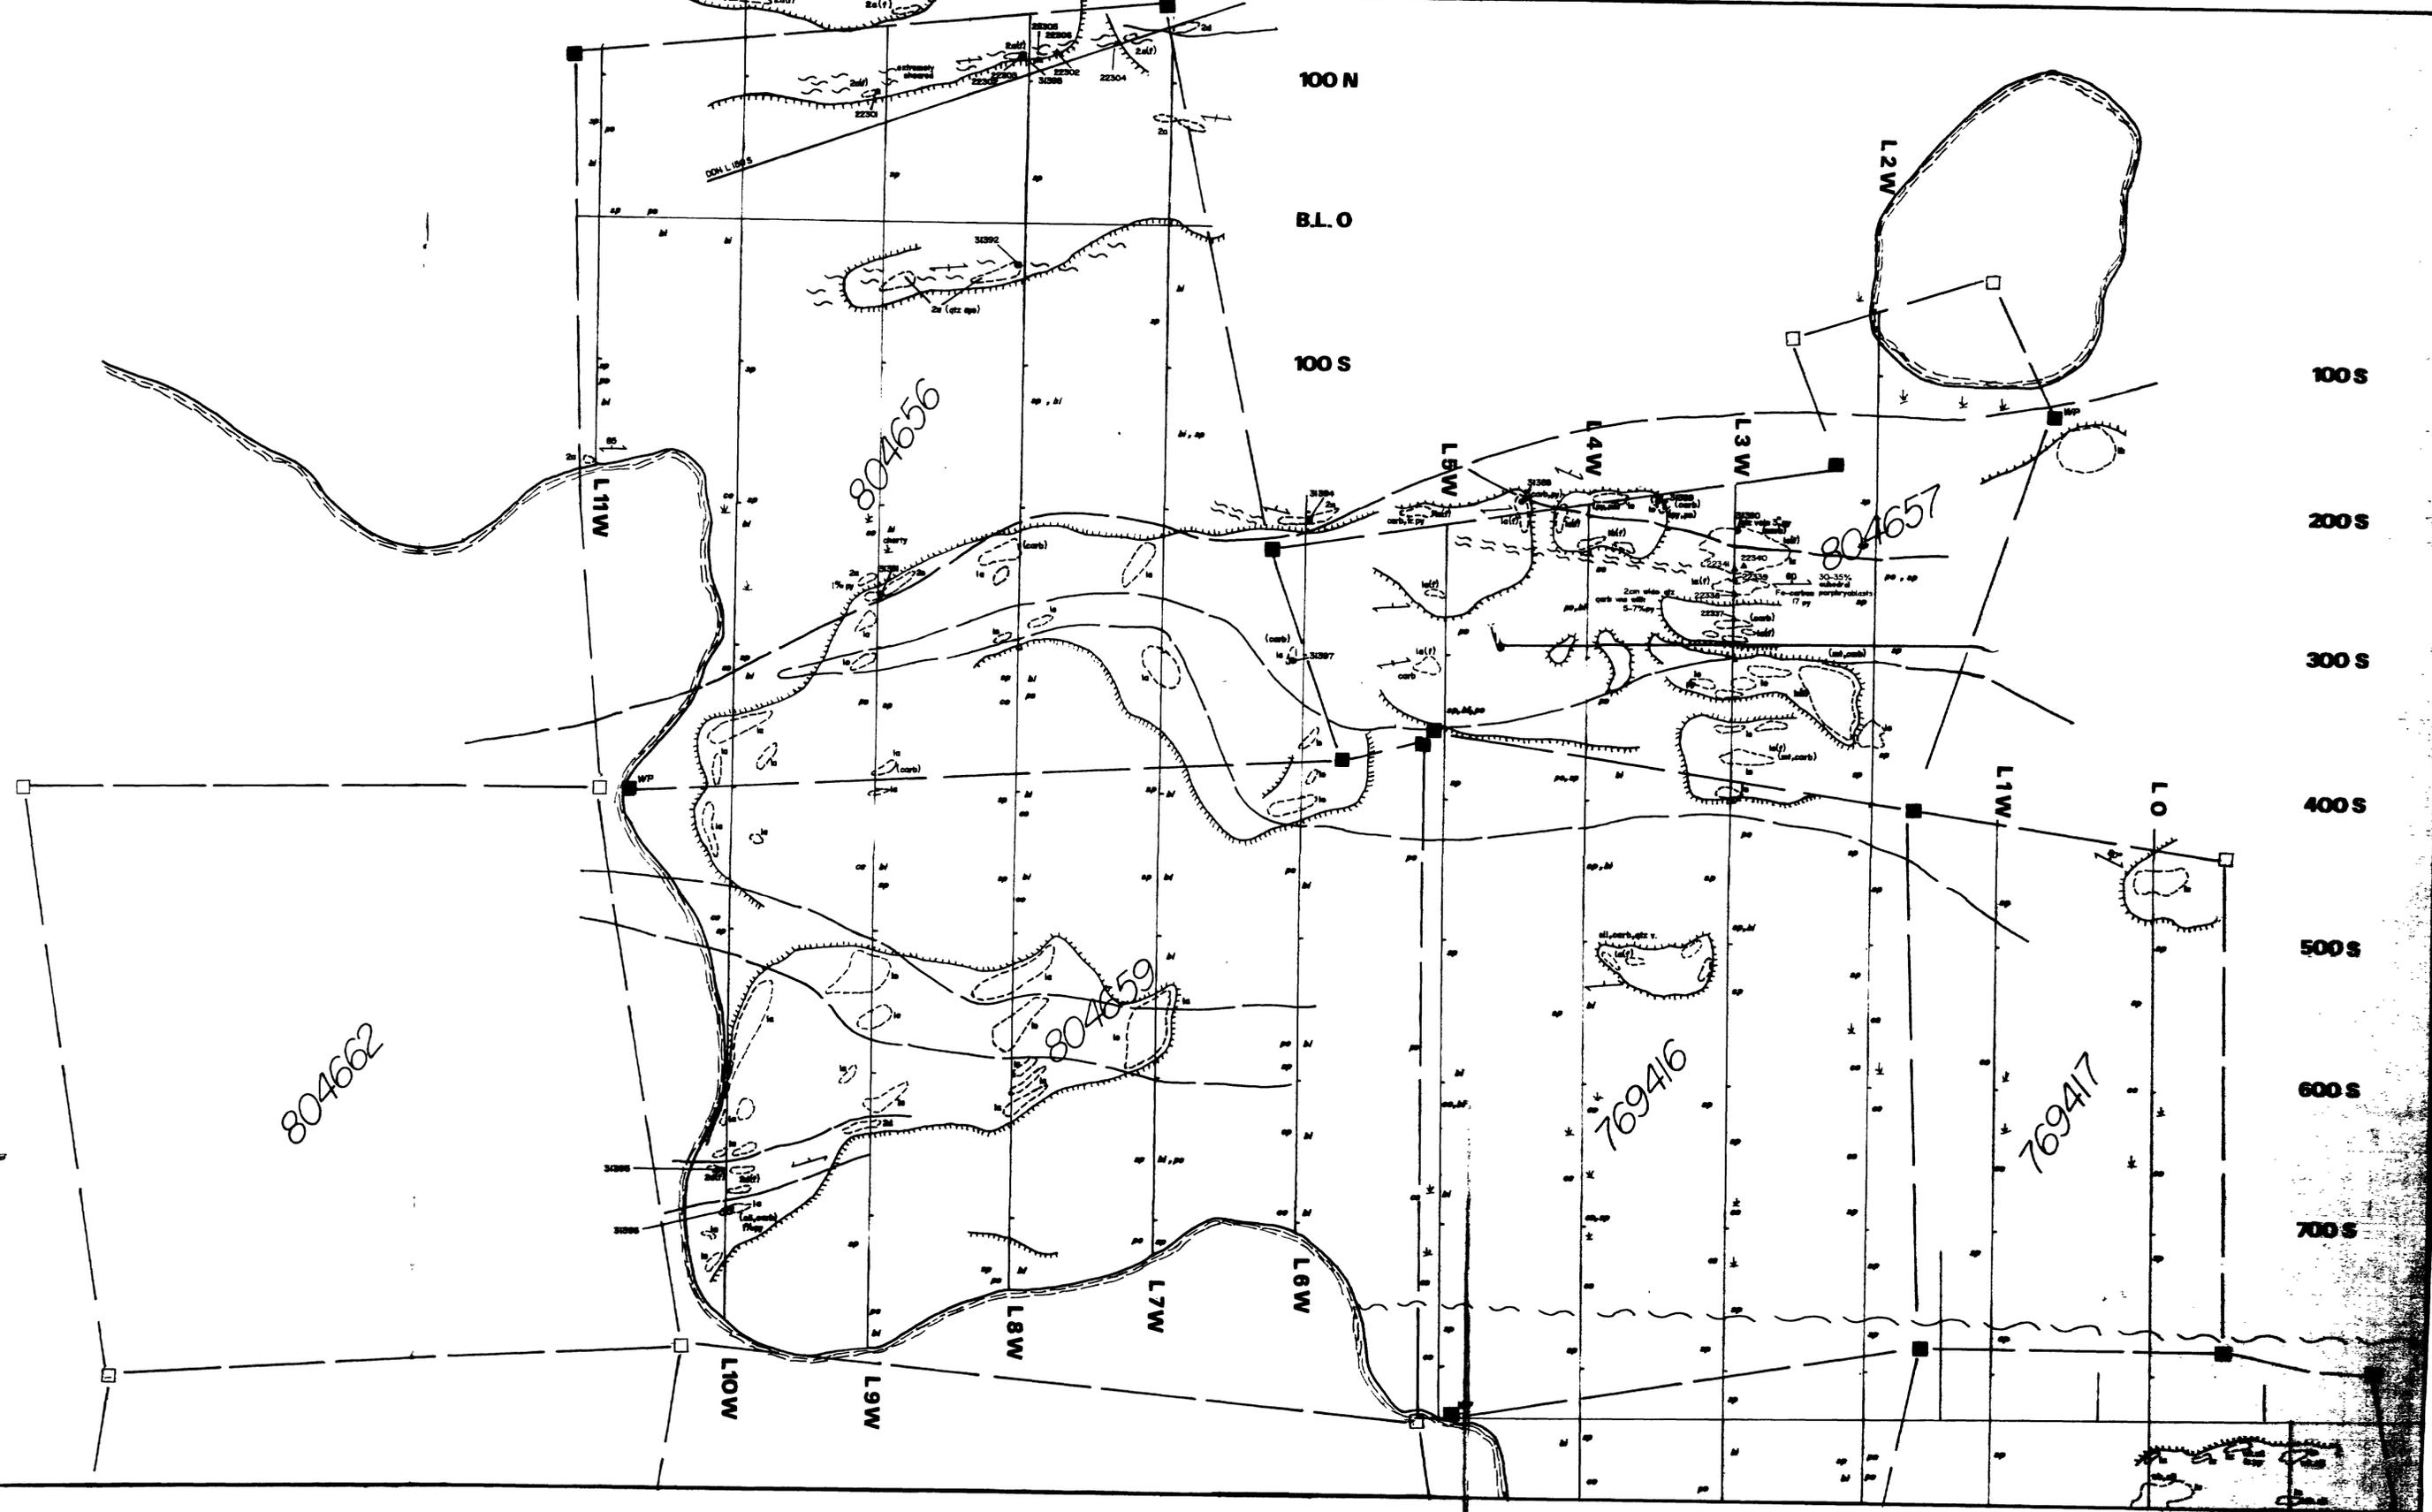

Raney Lake

804661

804660

769415

769409

769410

769407

769408

796607

796608

Raney Lake

LEGEND

ARCHEAN

Mafic intrusives

- 9 Diabase

METAVOLCANICS

Felsic to Inte

- 2a Crystal Tuff and
- 2a(f) Quartz Sericite-
- 2c Waterlain Cryst
- 2d Porphyritic Flo
- 2e Cherty Argillac


Mafic to Inte

- la Basalt to Ande
- la(f) Chlorite - Carbo
- lb Basalt to Ande
- lc Gabbro, Tholeiitic
- la(f) Chlorite Carbon

- ΔΔΔ breccia
- carb carbonized
- chl chlorite
- mt magnetite
- pe pyrrhotite
- py pyrite
- ser sericitized
- sil silicified
- mod r
- str s
- tr t
- wk w

- # quartz stockwork
- sp foliation attitude
- sb bedding attitude
- v vein attitude and w
- o outcrop
- ~ edge of ridge
- fault, showing direct
- ~ shear zone



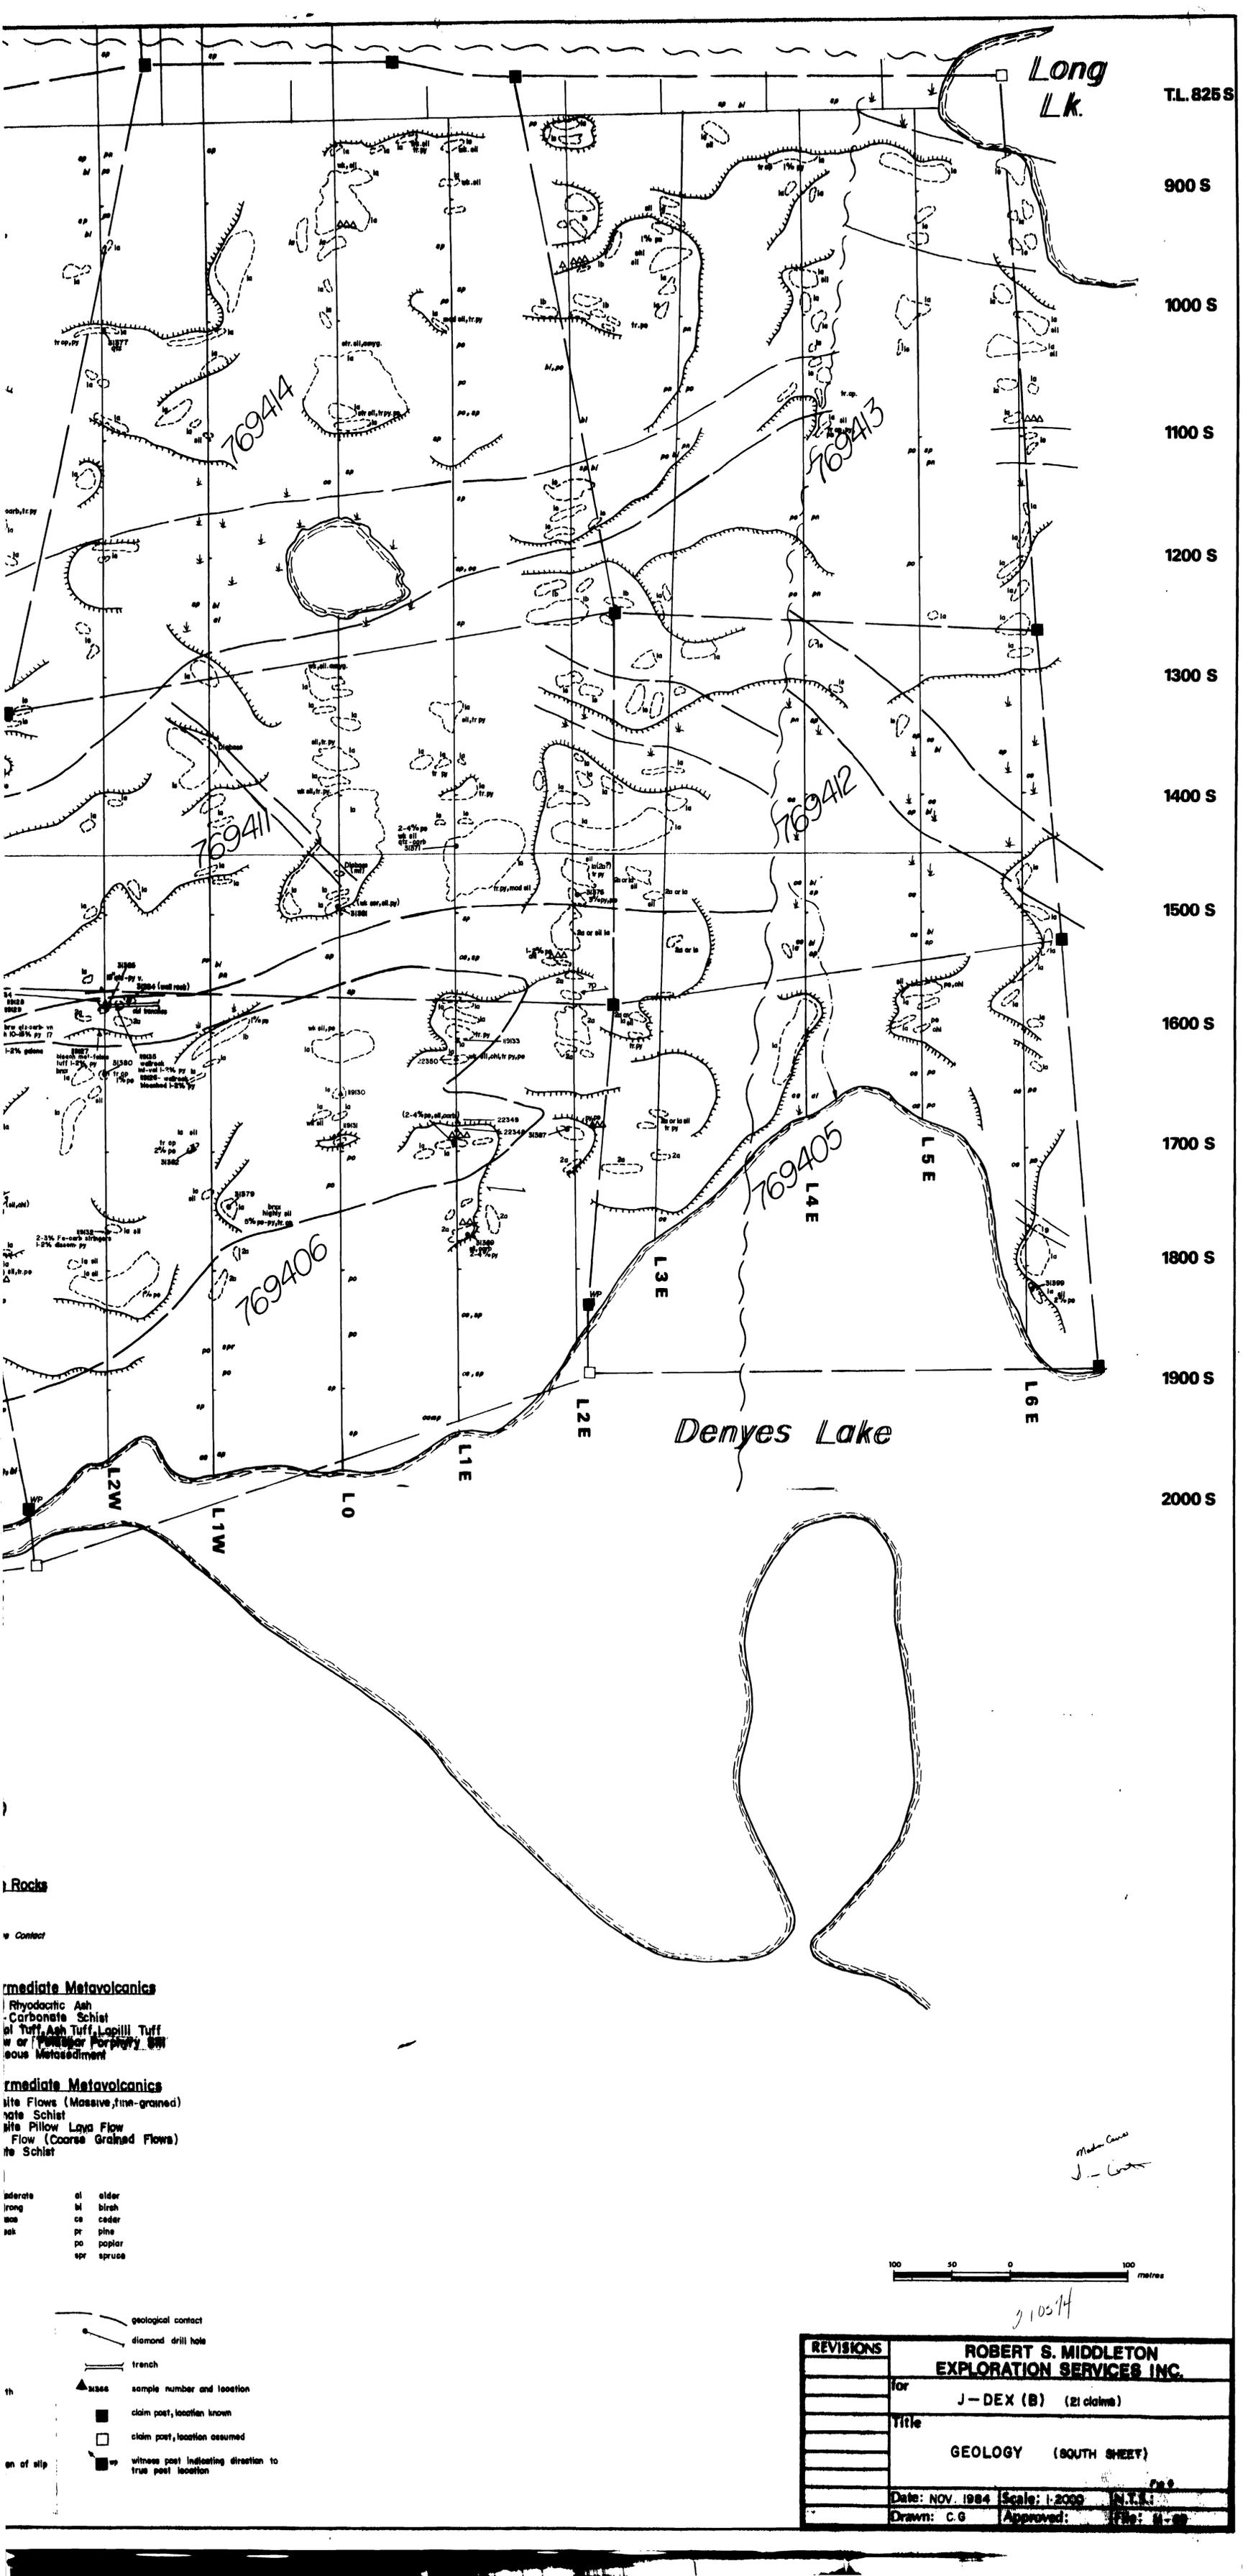

T.L. 825 S
 900 S
 1000 S
 1100 S
 1200 S
 1300 S
 1400 S
 1500 S
 1600 S
 1700 S
 1800 S
 1900 S
 2000 S

Long Lk.


Denyes Lake

Rocks
 Intermediate Metavolcanics
 Rhyodacitic Ash
 Carbonate Schist
 Ash Tuff, Ash Tuff, Lapilli Tuff
 or
 Porphyry
 Metasediment

Intermediate Metavolcanics
 Lava Flows (Massive, fine-grained)
 Slate Schist
 Lava Flow
 Flow (Coarse Grained Flows)
 Slate Schist

al alder
 bl birch
 ca cedar
 pr pine
 po poplar
 spr spruce

geological contact
 diamond drill hole
 trench
 sample number and location
 claim post, location known
 claim post, location assumed
 witness post indicating direction to true post location

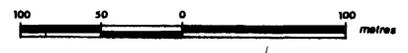

*Robert S. Middleton
 J. - DEX*

REVISIONS		ROBERT S. MIDDLETON EXPLORATION SERVICES INC.	
	for	J - DEX (B) (21 claims)	
	Title	GEOLOGY (SOUTH SHEET)	
	Date: NOV. 1984	Scale: 1:2000	N.T.L.
	Drawn: C.G.	Approved:	File: H-89

710574