

INMET MINING CORPORATION

MAGNETOMETER SURVEY

HUTT & ZAVITZ TWPS.

MATAWEST PROJECT

April 1997

2.17456



42A03SE0027 2.17456 ZAVITZ

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MAPS

1 - Claim Map	1:20 000
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3 - Location Map	1:600 000



42A03SE0027 2.17456 ZAVITZ

I - INTRODUCTION:

At the request of INMET MINING CORPORATION, a magnetometer survey was undertaken, by Exploration Services Reg'd, during the month of April, 1997, on the Company's Hutt and Zavitz township property.

The magnetometer survey was undertaken to obtain information which could be usefull to the interpretation of the local geology.

The partial survey was carried out at this time to enable coverage over the iced surfaces of areas containing numerous lakes and streams - a summer grid will be cut to pursue the survey over the entire property.

II - PROPERTY:

The MATAWEST property is composed of 17 claims containing 78 claim units. The claim numbers are as follows:

<u>Claim Number</u>	<u>Number of Units</u>
1177274	01
1177276	01
1177277	01
1177278	01
1177279	01
121 ████7920	01
1213426	04

1217437	10
1217438	10
1217439	02
1217918	10
1217919	04
1217921	10
1217922	06
1217923	06
1218867	09
1218868	01

III - LOCATION & ACCESIBILITY:

The claim group straddles the Hutt-Zavitz township boundary at an approximate distance of 53 Km due south of the town of PORCUPINE.

The claim group is accessible by driving southwards, from the town of South Porcupine, along an access road for an approximate distance of 50 Km, then eastwards along the Matachewan road for a few kilometers; this road traverses the central part of the claim group in an east-west direction.

IV - MAGNETOMETER SURVEY:

The magnetometer survey was carried out along a previously cut grid whose 3.8 Km long base line trends East-West. Cross lines, spaced at 200 m intervals extend northwards and southwards to cover the property area. Since the line cutting and survey are not completed, the partial line cutting to the West is referred as GRID (A) and the smaller project to the East is referred to as GRID (B). There are 30.5 line Km of cross lines cut and surveyed on GRID (A) and 7.5 line Km cut and surveyed on GRID (B).

- Instrumentation:

An OMNI IV nuclear precession magnetometer was used for the survey accompanied by a base station for diurnal corrections; readings were taken at every 12.5 meter intervals.

- Data Presentation:

The data were plotted on two separate maps (A) and (B) at the scale of 1:5 000. The report includes a map with posted readings, a map with contour intervals and an interpretation map.

- Interpretation:

The 600 gamma contour interval outlines Northeast trending Iron Formations on GRID (A) and the 1 000 gamma contour line outlines the Southeast trending formations on GRID (B).

The Iron Formations appear as narrow bands which are often

discontinuous and occasionally folded. Their maximum width is in the range of 1 500 m. The 500 gamma contour interval appears to outline an area of sedimentary rocks which hosts the Iron Formations on GRID (B).

On GRID (A), the 400 gamma contour interval defines 2 Northwest-Southeast trending diabase dykes.


Values ranging from 200 to 400 gammas appear to indicate the presence of the volcanic rocks of the area.

V - CONCLUSION & RECOMMENDATIONS:



The partial magnetometer survey has outlined the presence of narrow bands of Iron Formations trending Northeast and Southeast; the survey has also indicated the presence of 2 diabase dykes trending Northwest and Southeast. A more comprehensive interpretation will be possible once the survey has been completed over the entire property.

Respectfully submitted:

E. Chartré: B.A., B. Sc.:

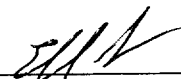

April 30, 1997

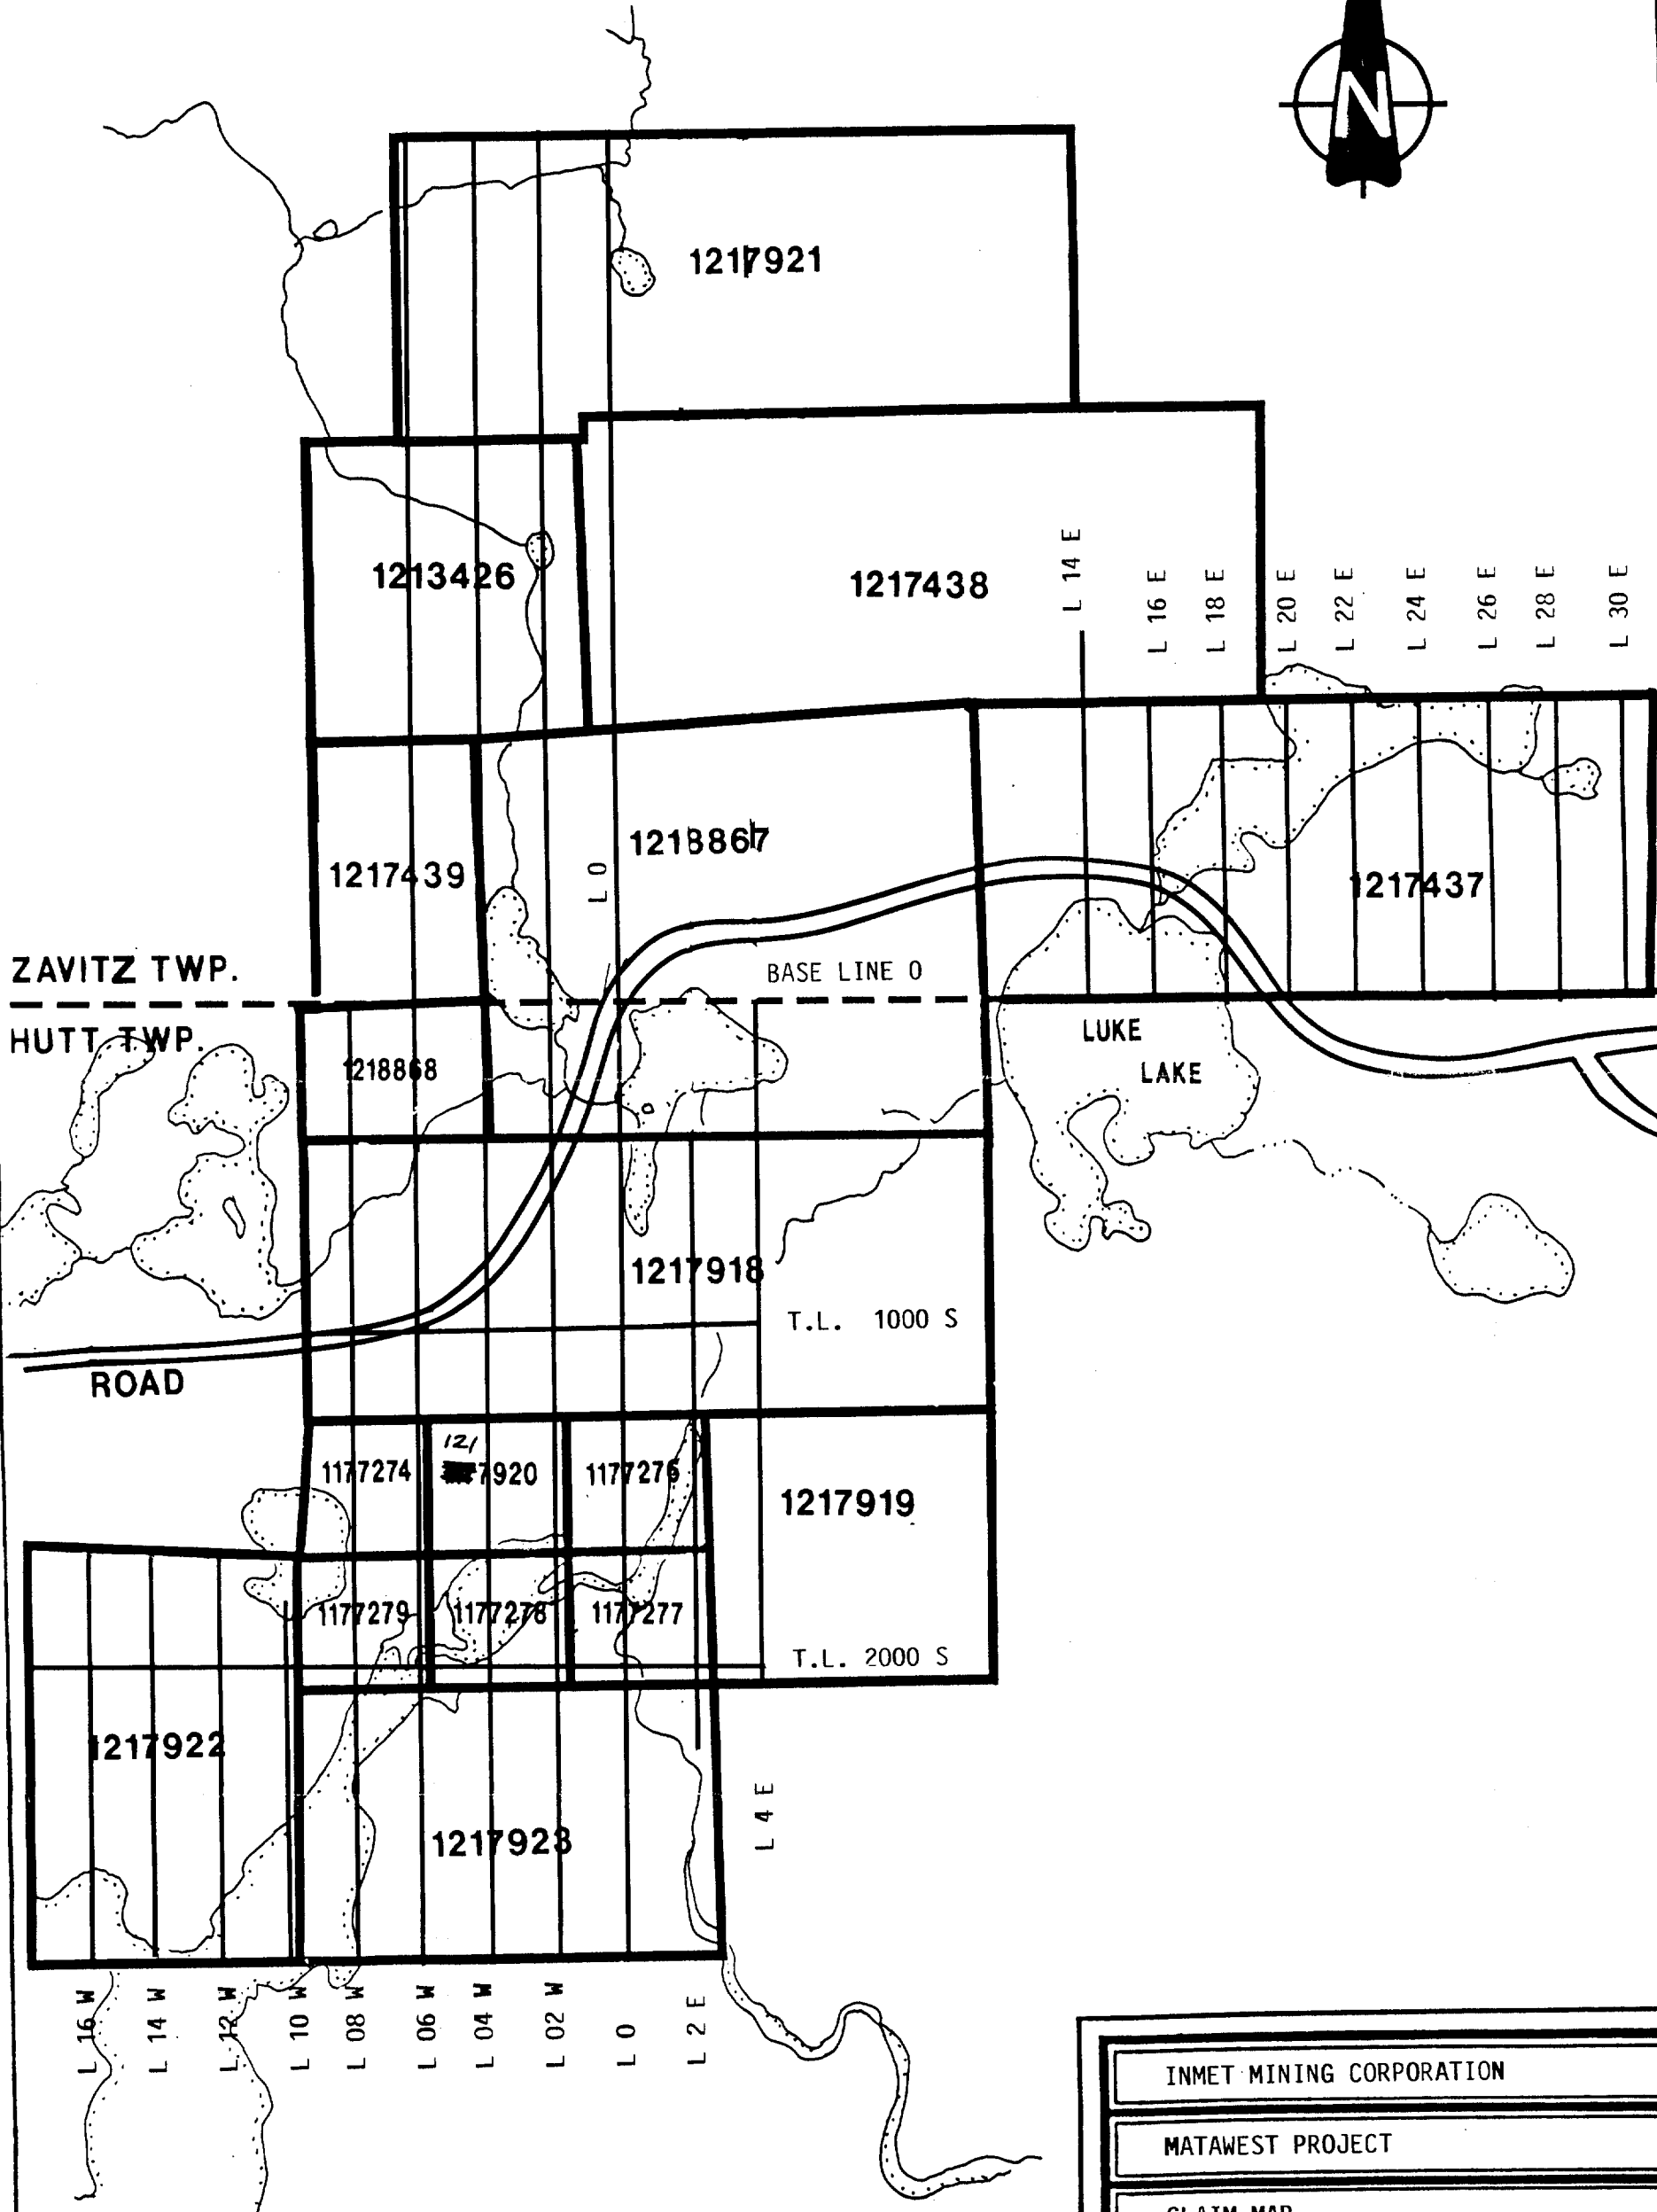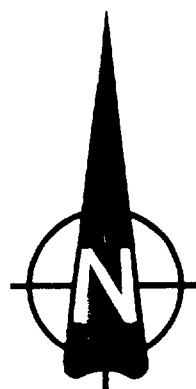


INMET MINING CORPORATION	
MATAWEST PROJECT	
CLAIM MAP	
April 1997	1:20 000




MAP "A"

MAP "B"

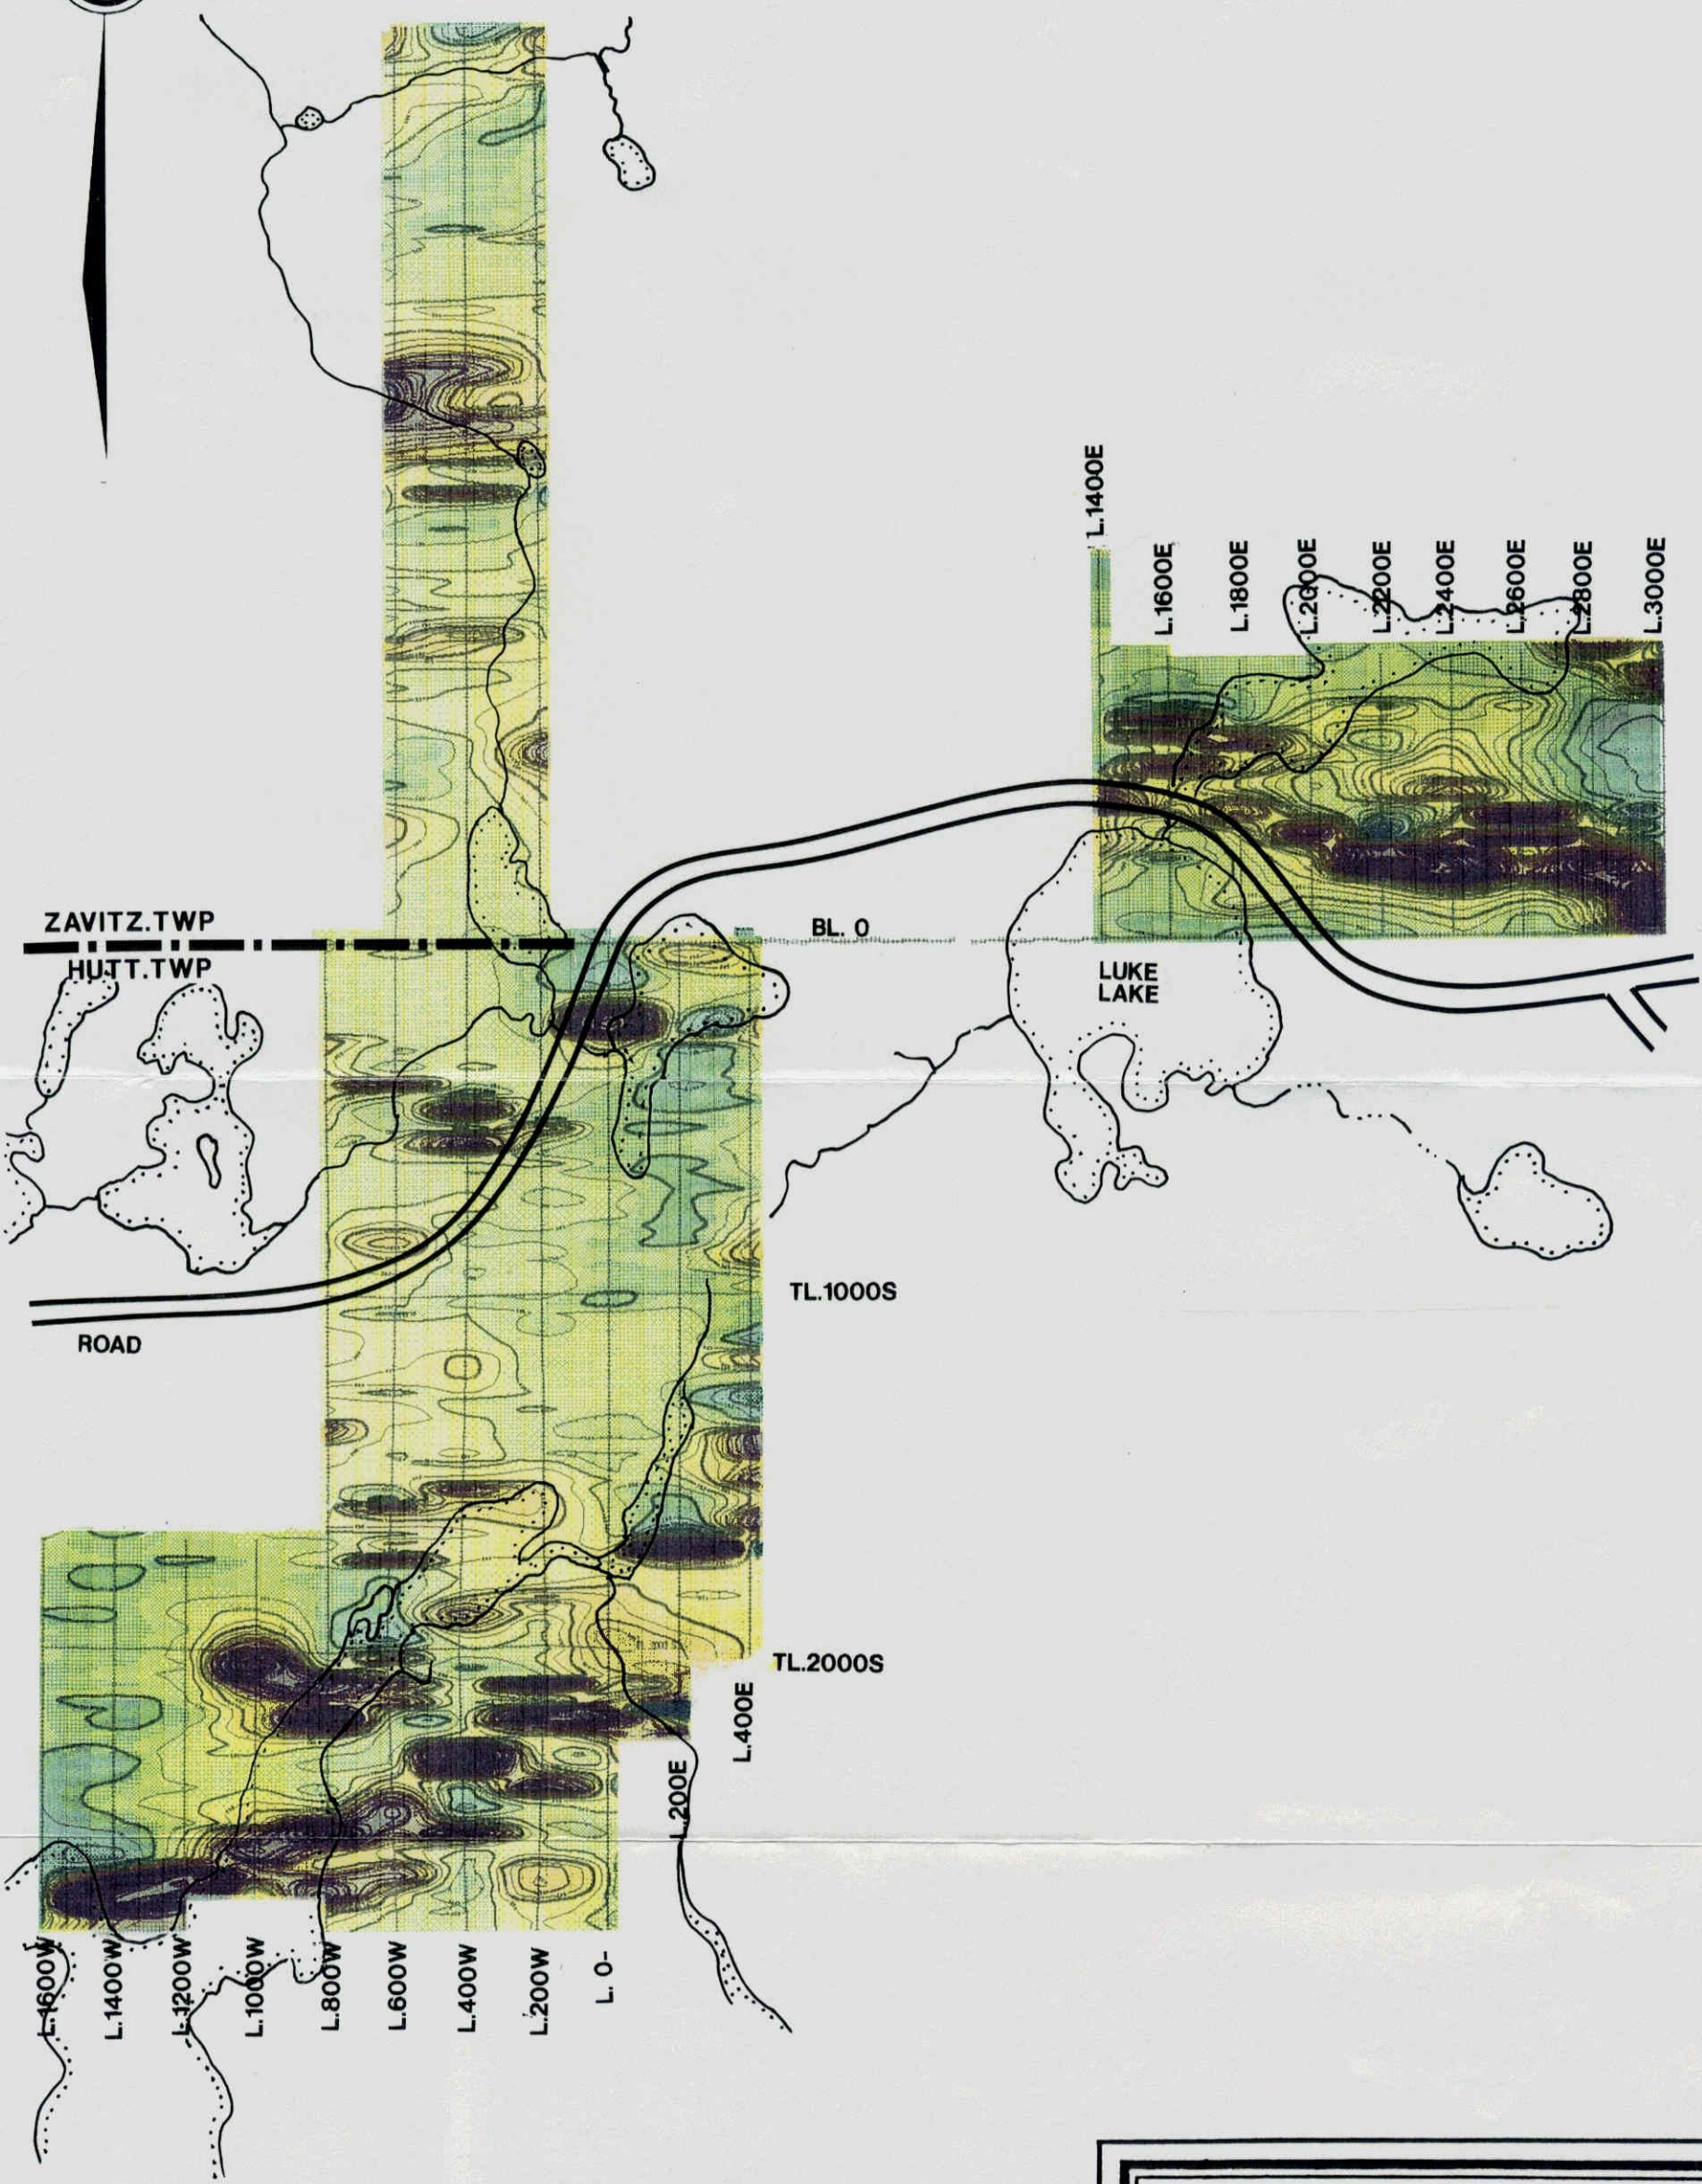

INMET MINING CORPORATION	
MATAWEST PROJECT	
MAGNETOMETER SURVEY	
MAI 1997	1:20,000

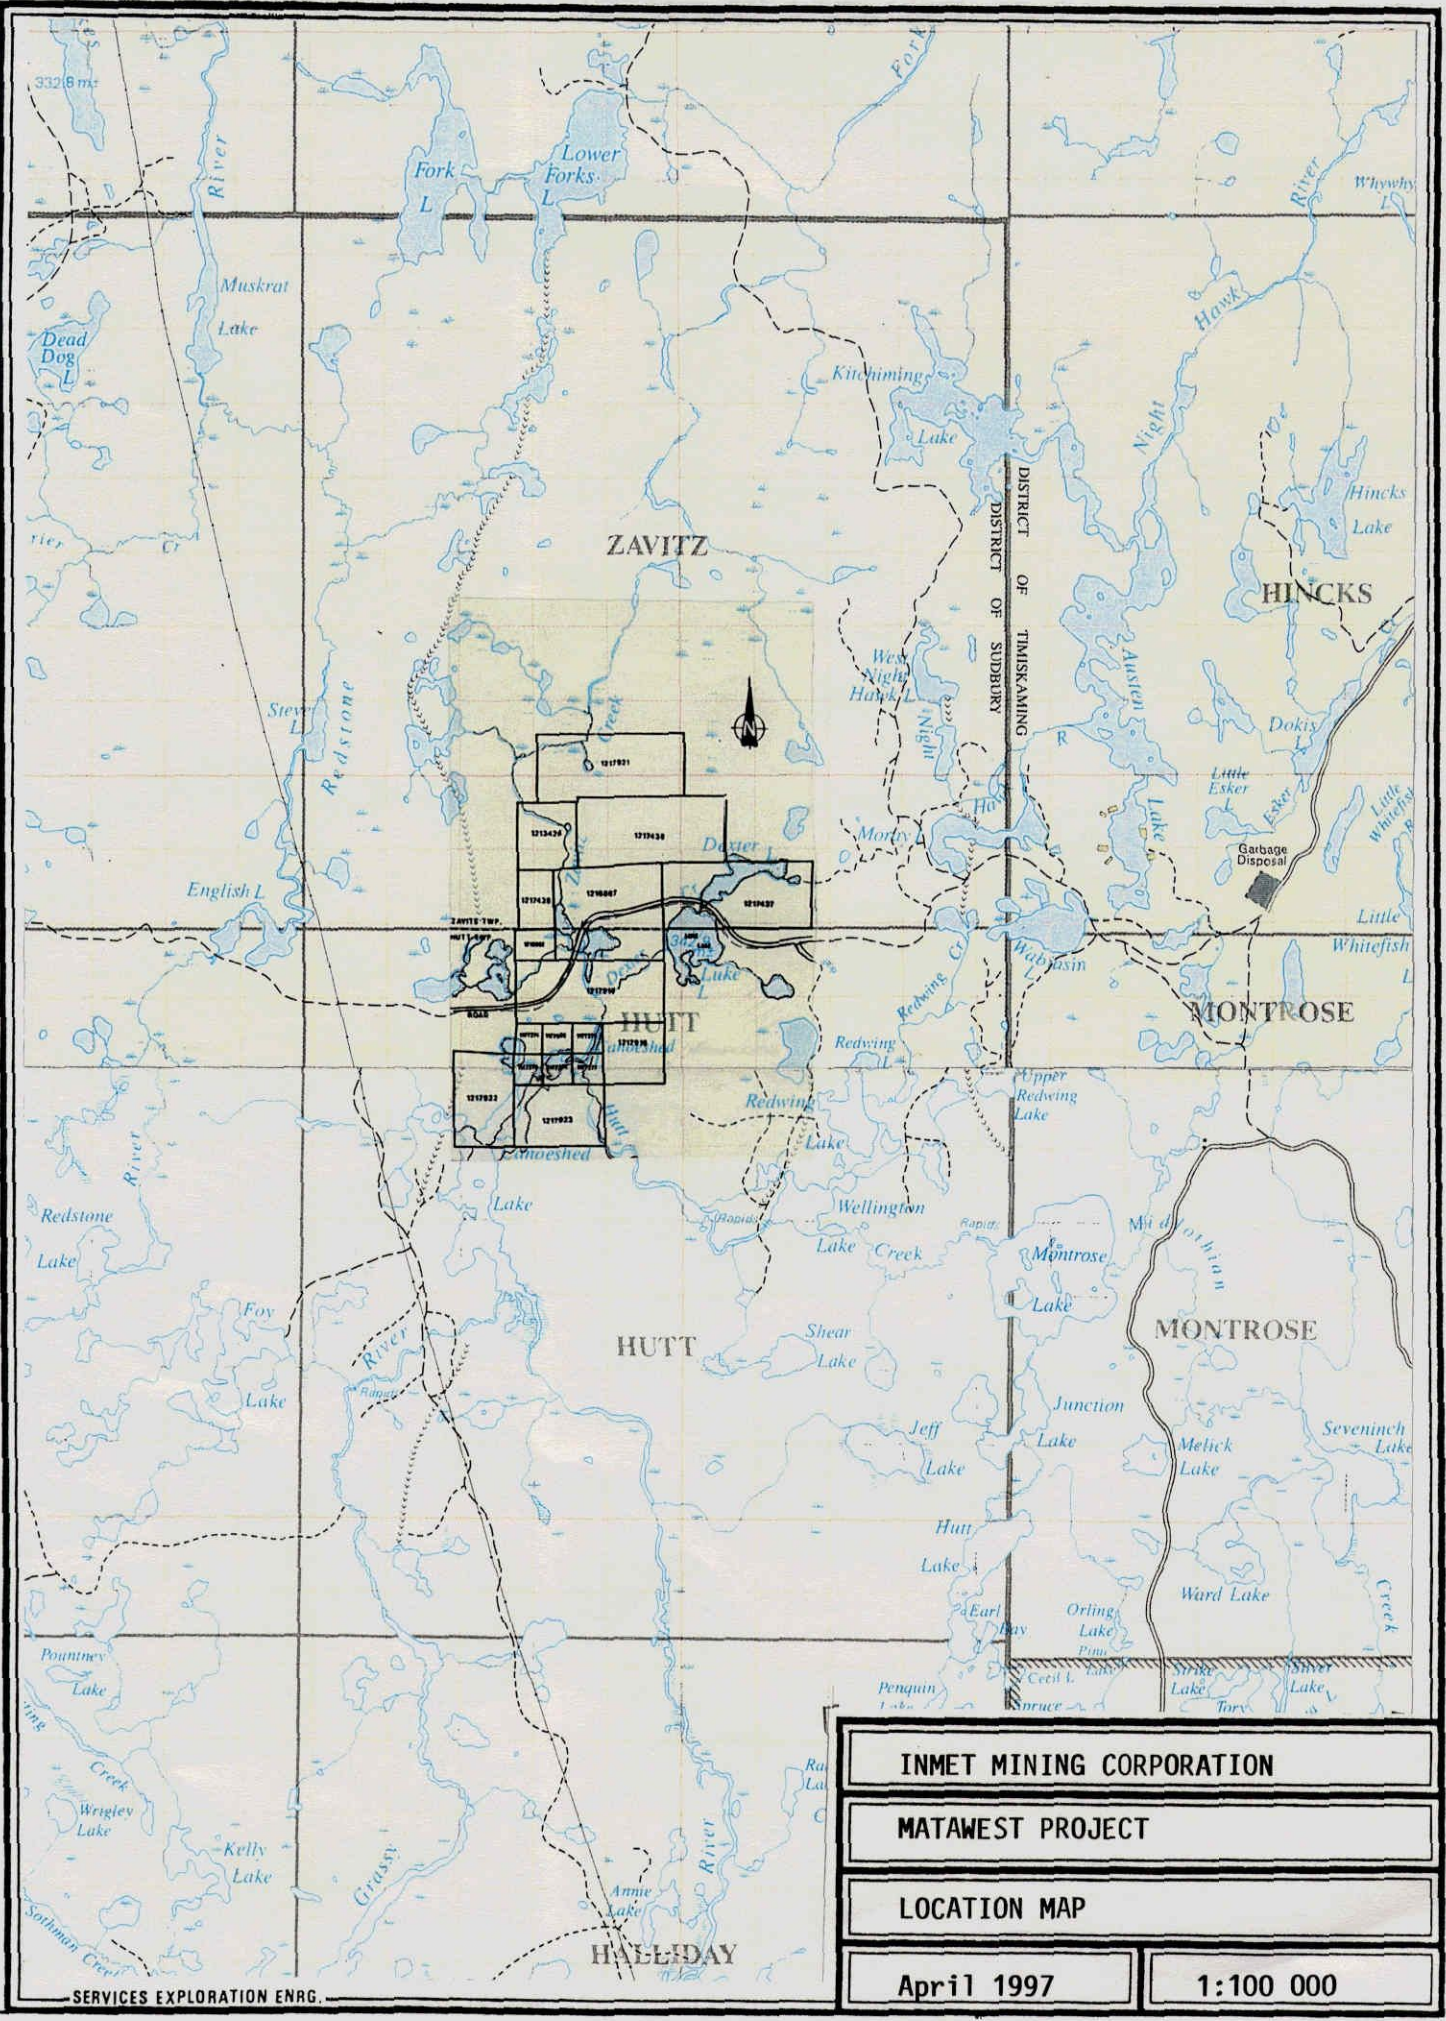

INMET MINING CORPORATION

MATAWEST PROJECT

LOCATION MAP

April 1997

1:100 000



INMET MINING CORPORATION

LOCATION MAP

MATAWEST PROJECT

April 1997

1:600 000



Declaration of Assessment Work Performed on Mining Land

Mining Act, Subsection 65(2) and 66(3), R.S.O. 1990

Transaction Number (office use) W 9760.00153 Assessment Files Research Imaging


Personal info Mining Act, II Questions at 933 Ramsey



35(2) and 66(3) of the Mining Act. Under section 8 of the assessment work and correspond with the mining land holder. Ministry of Northern Development and Mines, 6th Floor,

900

Instructions: - For work performed on Crown Lands before recording a claim, use form 0240. - Please type or print in ink.

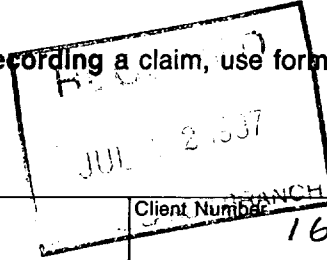

1. Recorded holder(s) (Attach a list if necessary)

Form with fields for Name, Address, Telephone Number, Fax Number, Client Number. Includes handwritten entry '2.17456'.

2. Type of work performed: Check (✓) and report on only ONE of the following groups for this declaration.

Form with checkboxes for Geotechnical, Physical, and Rehabilitation work. Includes fields for Work Type, Office Use, Dates Work Performed, and Township/Area.

Please remember to: - obtain a work permit from the Ministry of Natural Resources as required; - provide proper notice to surface rights holders before starting work; - complete and attach a Statement of Costs, form 0212; - provide a map showing contiguous mining lands that are linked for assigning work; - include two copies of your technical report.

3. Person or companies who prepared the technical report (Attach a list if necessary)

Form with fields for Name, Address, Telephone Number, Fax Number. Includes a large RECEIVED stamp dated MAY 20 1997 from PORCUPINE MINING DIVISION.

4. Certification by Recorded Holder or Agent

I, BERNARD BOILY, do hereby certify that I have personal knowledge of the facts set forth in this Declaration of Assessment Work having caused the work to be performed or witnessed the same during or after its completion and, to the best of my knowledge, the annexed report is true.

Signature of Recorded Holder or Agent: Bernard Boily, Date: MAY 13, 1997, Agent's Address: INMET MINING, 1300 SAGUENAY, SUITE 200, ROUYN-NORANDA, P.Q. J9X 5A6, Telephone Number: 819-764-6666, Fax Number: 819-764-6404.

5. Work to be recorded and distributed. Work can only be assigned to claims that are contiguous (adjoining) to the mining land where work was performed, at the time work was performed. A map showing the contiguous link must accompany this form.

W. 9760. 00153

Mining Claim Number. Or if work was done on other eligible mining land, show in this column the location number indicated on the claim map.	Number of Claim Units. For other mining land, list hectares.	Value of work performed on this claim or other mining land.	Value of work applied to this claim.	Value of work assigned to other mining claims.	Bank. Value of work to be distributed at a future date.
eg TB 7827	16 ha	\$26, 825	N/A	\$24,000	\$2,825
eg 1234567	12	0	\$24,000	0	0
eg 1234568	2	\$ 8, 892	\$ 4,000	0	\$4,892
1. 1177274'	1	\$ 169	\$ 400	\$ 169	0
2. 1177276'	1	\$ 169	\$ 400	\$ 169	0
3. 1177277'	1	\$ 507	0	\$ 231	\$ 276
4. 1177278'	1	\$ 507	0	\$ 231	\$ 276
5. 1177279'	1	\$ 507	0	0	\$ 507
6. 1213426'	4	\$ 1,016	0	0	\$ 1,016
7. 1217437'	10	\$ 3,723	0	0	\$ 3,723
8. 1217438'	10	\$ 169	0	0	\$ 169
9. 1217439'	2	\$ 339	0	0	\$ 339
10. 1217918'	10	\$ 2,707	0	0	\$ 2,707
11. 1217919'	4	\$ 339	0	0	\$ 339
12. 1217920'	1	\$ 169	0	0	\$ 169
13. 1217921'	10	\$ 1,016	0	0	\$ 1,016
14. 1217922'	6	\$ 2,032	0	0	\$ 2,032
15. 1217923'	6	\$ 1,523	0	0	\$ 1,523
Column Totals		\$14,892	\$ 800	\$ 800	\$14,092

I, BERNARD Bailey (Print Full Name), do hereby certify that the above work credits are eligible under subsection 7(1) of the Assessment Work Regulation 6/96 for assignment to contiguous claims or for application to the claim where the work was done.

Signature of Recorded Holder or Agent Authorized in Writing: Bernard Bailey Date: MAY 13, 1997

6. Instructions for cutting back credits that are not approved.

Some of the credits claimed in this declaration may be cut back. Please check (✓) in the boxes below to show how you wish to prioritize the deletion of credits:

- 1. Credits are to be cut back from the Bank first, followed by option 2 or 3 or 4 as indicated.
- 2. Credits are to be cut back starting with the claims listed last, working backwards; or
- 3. Credits are to be cut back equally over all claims listed in this declaration; or
- 4. Credits are to be cut back as prioritized on the attached appendix or as follows (describe):

2. 17436

Note: If you have not indicated how your credits are to be deleted, credits will be cut back from the Bank first, followed by option number 2 if necessary.

For Office Use Only Received Stamp		Deemed Approved Date	Date Notification Sent
		Date Approved	Total Value of Credit Approved
		Approved for Recording by Mining Recorder (Signature)	

Ministry of
Northern Development
and Mines

Ministère du
Développement du Nord
et des Mines



Geoscience Assessment Office
933 Ramsey Lake Road
6th Floor
Sudbury, Ontario
P3E 6B5

July 31, 1997

INMET MINING CORPORATION
SUITE 3400, AETNA TOWER, P.O. BOX 19
TORONTO DOMINION CENTRE
TORONTO, Ontario
M5K-1A1

Telephone: (888) 415-9846
Fax: (705) 670-5863

Dear Sir or Madam:

Submission Number: 2.17456

Status

Subject: Transaction Number(s): W9760.00153 Deemed Approval

We have reviewed your Assessment Work submission with the above noted Transaction Number(s). The attached summary page(s) indicate the results of the review. **WE RECOMMEND YOU READ THIS SUMMARY FOR THE DETAILS PERTAINING TO YOUR ASSESSMENT WORK.**

If the status for a transaction is a 45 Day Notice, the summary will outline the reasons for the notice, and any steps you can take to remedy deficiencies. The 90-day deemed approval provision, subsection 6(7) of the Assessment Work Regulation, will no longer be in effect for assessment work which has received a 45 Day Notice.

Please note any revisions must be submitted in **DUPLICATE** to the Geoscience Assessment Office, by the response date on the summary.

If you have any questions regarding this correspondence, please contact Steve Beneteau by e-mail at beneteau_s@torv05.ndm.gov.on.ca or by telephone at (705) 670-5855.

Yours sincerely,

A handwritten signature in black ink, appearing to read "Blair Kite".

ORIGINAL SIGNED BY
Blair Kite
Supervisor, Geoscience Assessment Office
Mining Lands Section

Work Report Assessment Results

Submission Number: 2.17456

Date Correspondence Sent: July 31, 1997

Assessor: Steve Beneteau

Transaction Number	First Claim Number	Township(s) / Area(s)	Status	Approval Date
W9760.00153	1177274	ZAVITZ, HUTT	Deemed Approval	July 31, 1997

Section:

14 Geophysical MAG

Correspondence to:

Resident Geologist
South Porcupine, ON

Assessment Files Library
Sudbury, ON

Recorded Holder(s) and/or Agent(s):

Bernard Boily
ROUYN-NORANDA, QUEBEC


INMET MINING CORPORATION
TORONTO, Ontario

LES MINES
INMET**2.17456**DIVISION EXPLORATION
1300 Boul. Saguenay, Suite 200
C.P. 2187, Rouyn-Noranda (Québec) J9X 5A6
Fax:(819) 764-6404 Tel: (819) 764-6666FORMULE DE TRANSMISSION - TELECOPIEUR
RAPIFAX MESSAGE FORMDATE: July 30, 1997DESTINATAIRE: Steven Beneteau
DESTINATION:ENDROIT: Assessment Office - Sudbury
LOCATION:TELECOPIEUR: (705) 670 - 5863ENVOI DE : **BERNARD BOILY**
SENDER:Subject: **Magnetometer survey - Hutt & Zavitz Twps. - Matawest Project - April 1997**

Dear Mr. Beneteau,

On the maps accompanying the report, the Profile base is 57,500 gammas. Thus, 57,500 gammas should be added to the posted values to have the real values.


Regards,

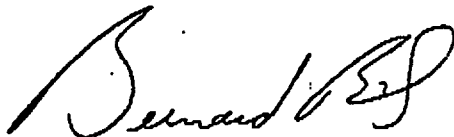Bernard Boily
Senior Project Geologist**BONNE JOURNEE ! HAVE A NICE DAY !**Par: **B.B.**
By:Nombre de page (s) incluant celle-ci: **1** Heure: **16:45**
Number of page (s) including this one: **Time:**



M. 1189

Geikie Twp.(M.320)

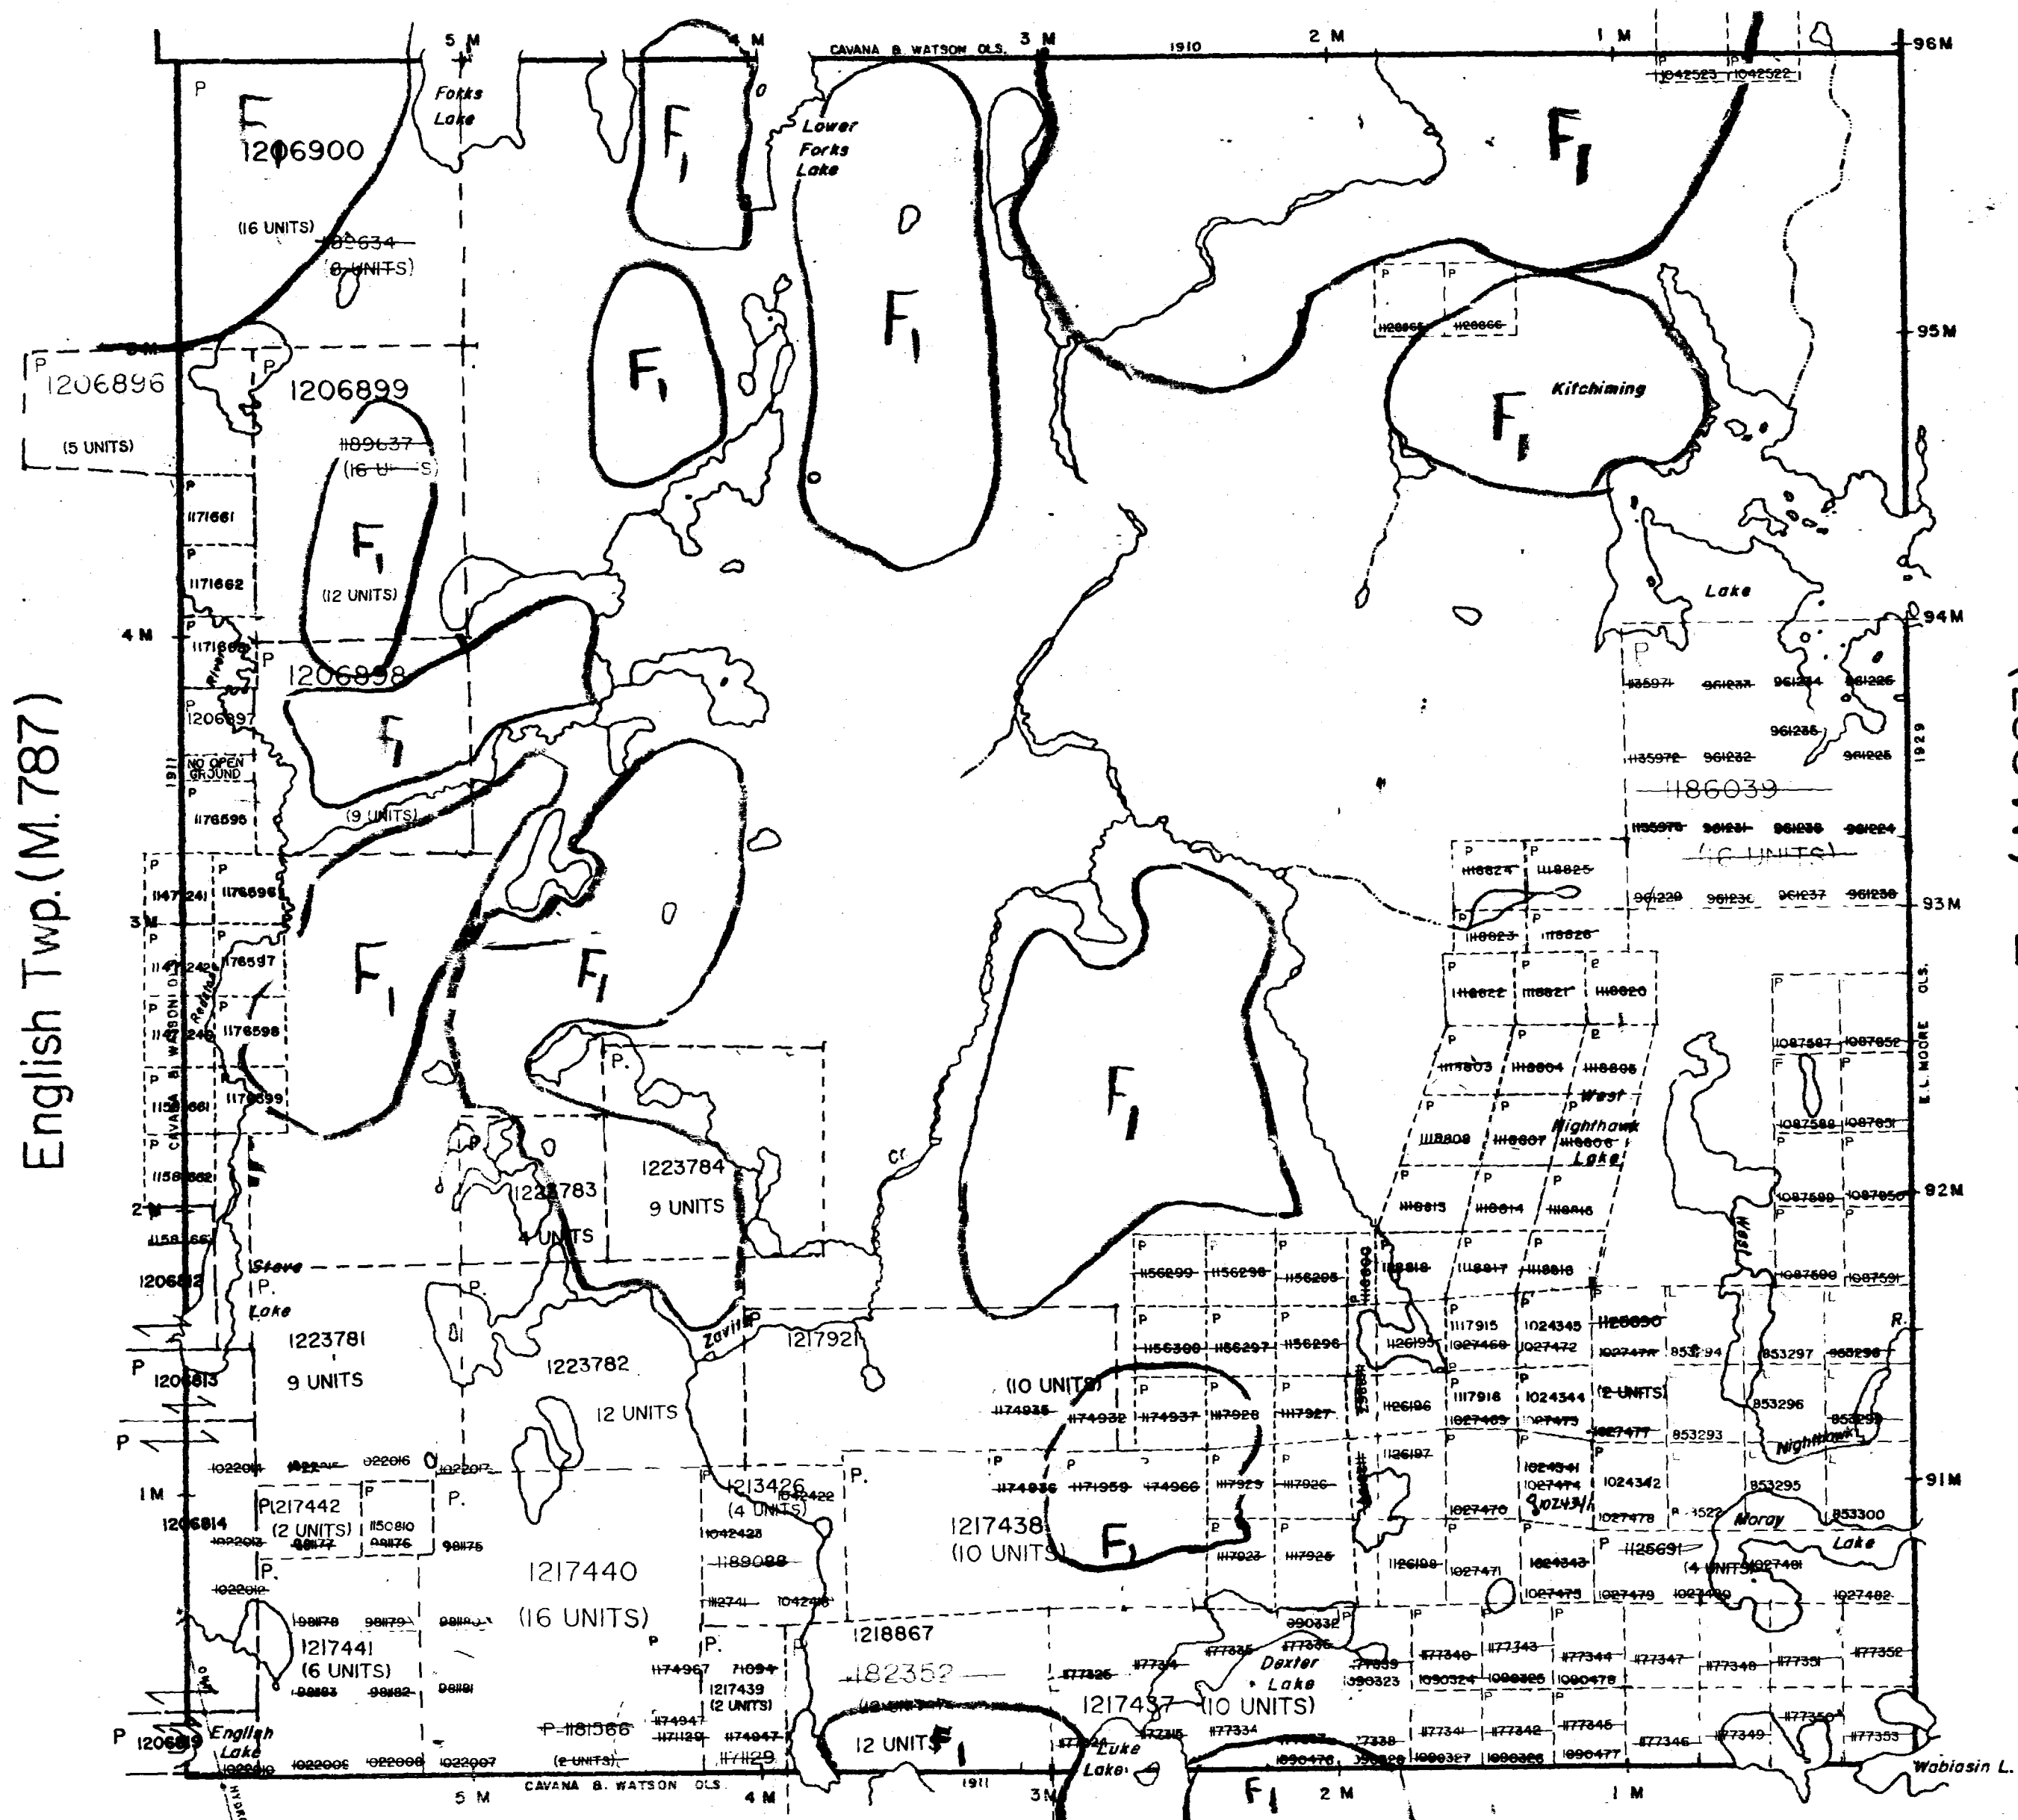

English Twp.(M.787)

Hincks Twp.(M.223)

Hutt Twp.(M.943) 2.17456
MAG

THE TOWNSHIP OF ZAVITZ

DISTRICT OF SUDBURY

PORCUPINE MINING DIVISION

SCALE: 1-INCH = 40 CHAINS

LEGEND

- PATENTED LAND
- CROWN LAND SALE
- LEASES
- LOCATED LAND
- LICENSE OF OCCUPATION
- MINING RIGHTS ONLY
- SURFACE RIGHTS ONLY
- ROADS
- IMPROVED ROADS
- KING'S HIGHWAYS
- RAILWAYS
- POWER LINES
- MARSH OR MUSKEG
- MINES
- CANCELLED

NOTES

400' SURFACE RIGHTS RESERVATION ALONG THE SHORES OF ALL LAKES AND RIVERS.

F1 - SUBJECT TO FURTHER ACTIVITY IN 1994/95 & 1995/96

THE INFORMATION THAT APPEARS ON THIS MAP HAS BEEN COMPILED FROM VARIOUS SOURCES AND ACCURACY IS NOT GUARANTEED. THOSE WISHING TO STAKE MINING CLAIMS SHOULD CONSULT WITH THE MINING RECORDER, MINISTRY OF NORTHERN DEVELOPMENT AND MINES FOR ADDITIONAL INFORMATION ON THE STATUS OF THE LANDS SHOWN HEREON.

PLAN NO. M. 1189

ONTARIO
MINISTRY OF NATURAL RESOURCES
SURVEYS AND MAPPING BRANCH

RECEIVED
JUL 22 1997
SURVEYS BRANCH

ZAVITZ M. 1189


M. 1189

2.17456

G-3948

2.17456
MAG

ZAVITZ TWP.

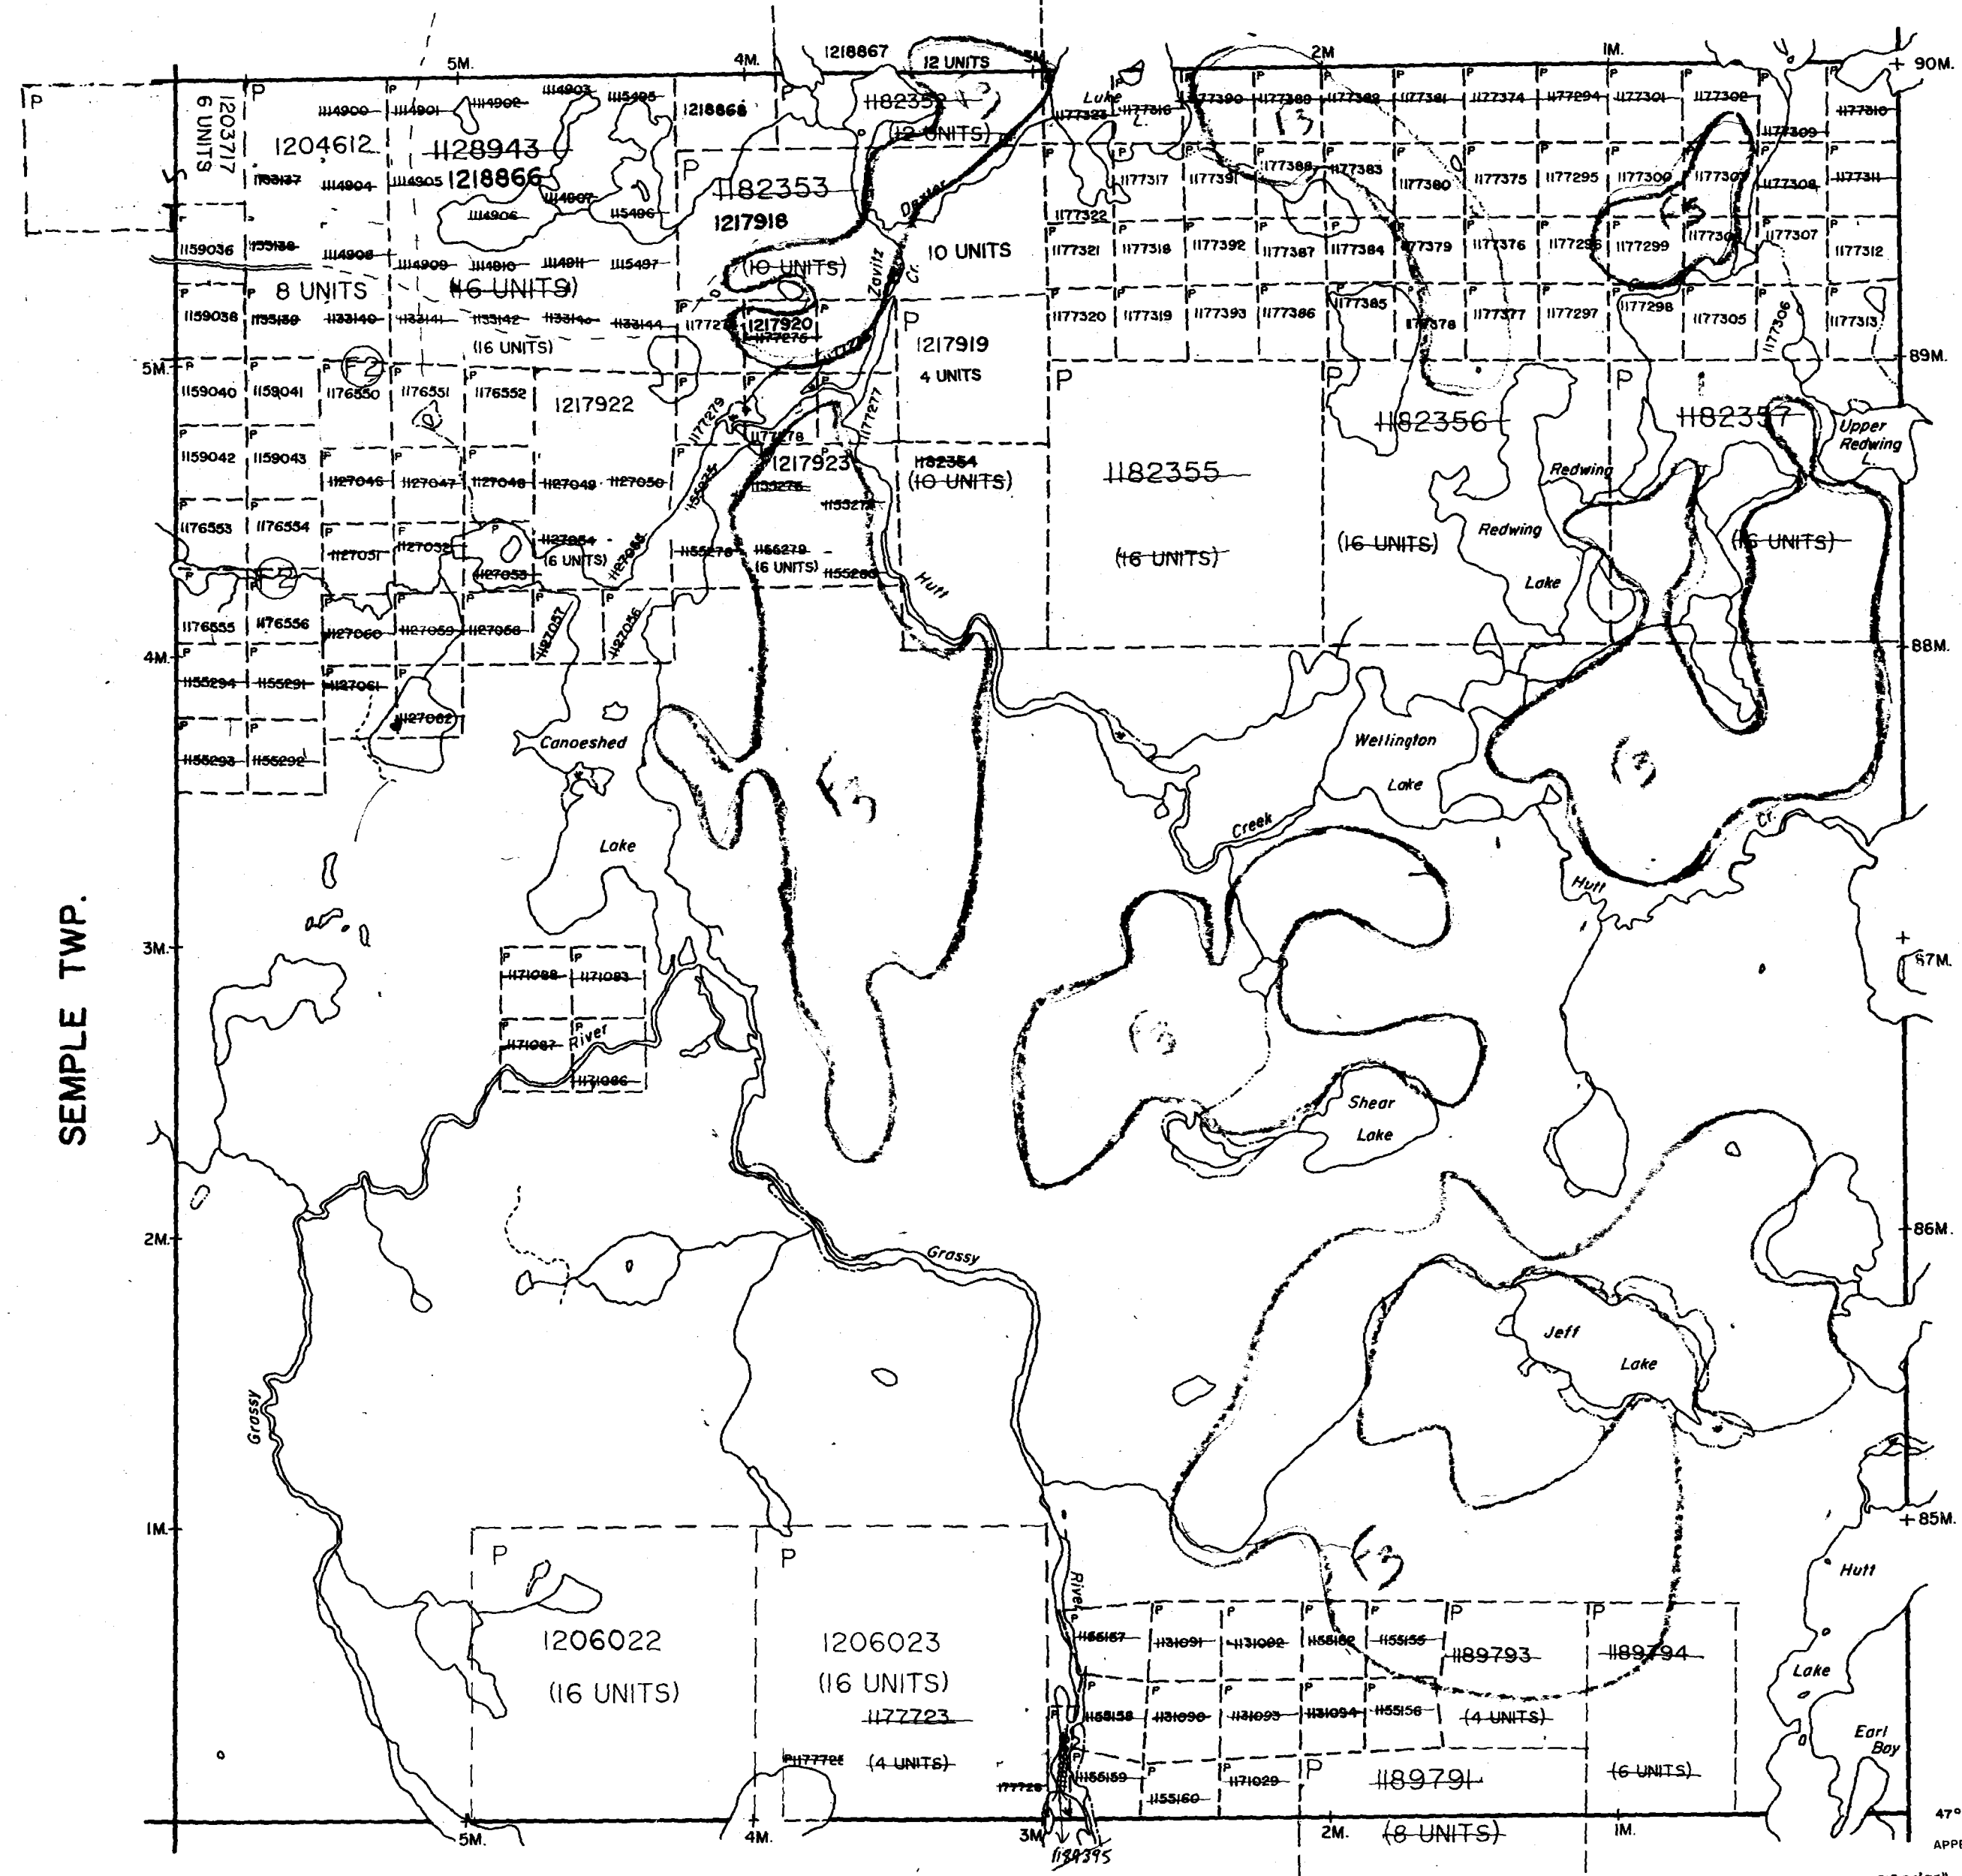

HALLIDAY TWP.

MONTROSE TWP.


LEGEND

- HIGHWAY AND ROUTE No.
- OTHER ROADS
- TRAILS
- SURVEYED LINES:
 - TOWNSHIPS, BASE LINES, ETC.
 - LOTS, MINING CLAIMS, PARCELS, ETC.
- UNSURVEYED LINES:
 - LOT LINES
 - PARCEL BOUNDARY
 - MINING CLAIMS ETC.
- RAILWAY AND RIGHT OF WAY
- UTILITY LINES
- NON-PERENNIAL STREAM
- FLOODING OR FLOODING RIGHTS
- SUBDIVISION OR COMPOSITE PLAN
- RESERVATIONS
- ORIGINAL SHORELINE
- MARSH OR MUSKEG
- MINES
- TRAVERSE MONUMENT

DISPOSITION OF CROWN LANDS

TYPE OF DOCUMENT	SYMBOL
PATENT, SURFACE & MINING RIGHTS	●
" SURFACE RIGHTS ONLY	○
" MINING RIGHTS ONLY	◐
LEASE, SURFACE & MINING RIGHTS	■
" SURFACE RIGHTS ONLY	◼
" MINING RIGHTS ONLY	◑
LICENCE OF OCCUPATION	○
ORDER-IN-COUNCIL	○
RESERVATION	○
CANCELLED	○
SAND & GRAVEL	○

THIS TWP IS SUBJECT TO FOREST ACTIVITY IN 1992/93. FURTHER INFORMATION ON FILE.
 THIS TWP IS SUBJECT TO FOREST ACTIVITY IN 1993/94. FURTHER INFORMATION ON FILE.

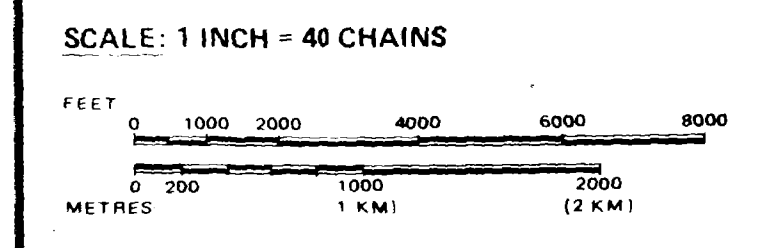


F1 THIS TWP IS SUBJECT TO FOREST ACTIVITY IN 1995/96. FURTHER INFORMATION AVAILABLE ON FILE.

TOWNSHIP
HUTT

M.N.R. ADMINISTRATIVE DISTRICT
TIMMINS

MINING DIVISION
PORCUPINE

LAND TITLES / REGISTRY DIVISION
SUDBURY

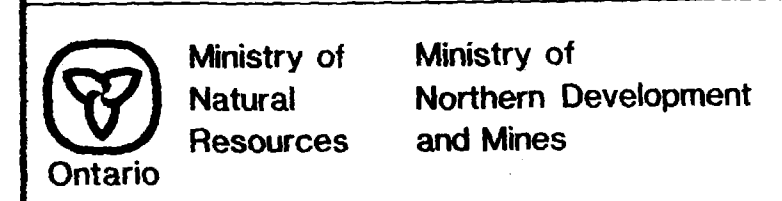


Date JUNE, 1992 Number
 ACTIVATED JULY 16, 1992 BY D.C. G-3948
 CHECKED BY G.W.

RECEIVED
JUL 22 1992

HUTT TWP

210

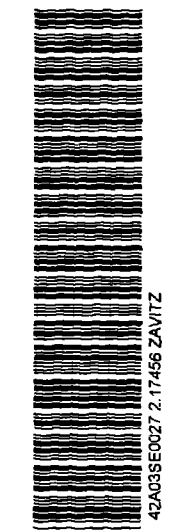

SEMPL TWP

THE INFORMATION THAT APPEARS ON THIS MAP HAS BEEN COMPILED FROM VARIOUS SOURCES, AND ACCURACY IS NOT GUARANTEED. THOSE WISHING TO STAKE MINING CLAIMS SHOULD CONSULT WITH THE MINING RECORDER, MINISTRY OF NORTHERN DEVELOPMENT AND MINES, FOR ADDITIONAL INFORMATION ON THE STATUS OF THE LANDS SHOWN HEREON.

G-3

1400 N.
1300 N.
1200 N.
1100 N.
1000 N.
900 N.
800 N.
700 N.
600 N.
500 N.
400 N.
300 N.
200 N.
100 N.
0 BASELINE

1217438

1218867

L 1400 E

L 1600 E

L 1800 E

L 2000 E

L 2200 E

L 2400 E

L 2600 E

L 2800 E

L 3000 E

L 1400 E

L 1600 E

L 1800 E

L 2000 E

L 2200 E

L 2400 E

L 2600 E

L 2800 E

L 3000 E

LUKE LAKE

ROAD

MAP "A"



MAP "B"

BASELINE

BASELINE

ZAVITZ.TWP
HUTT.TWP

MAP "B"

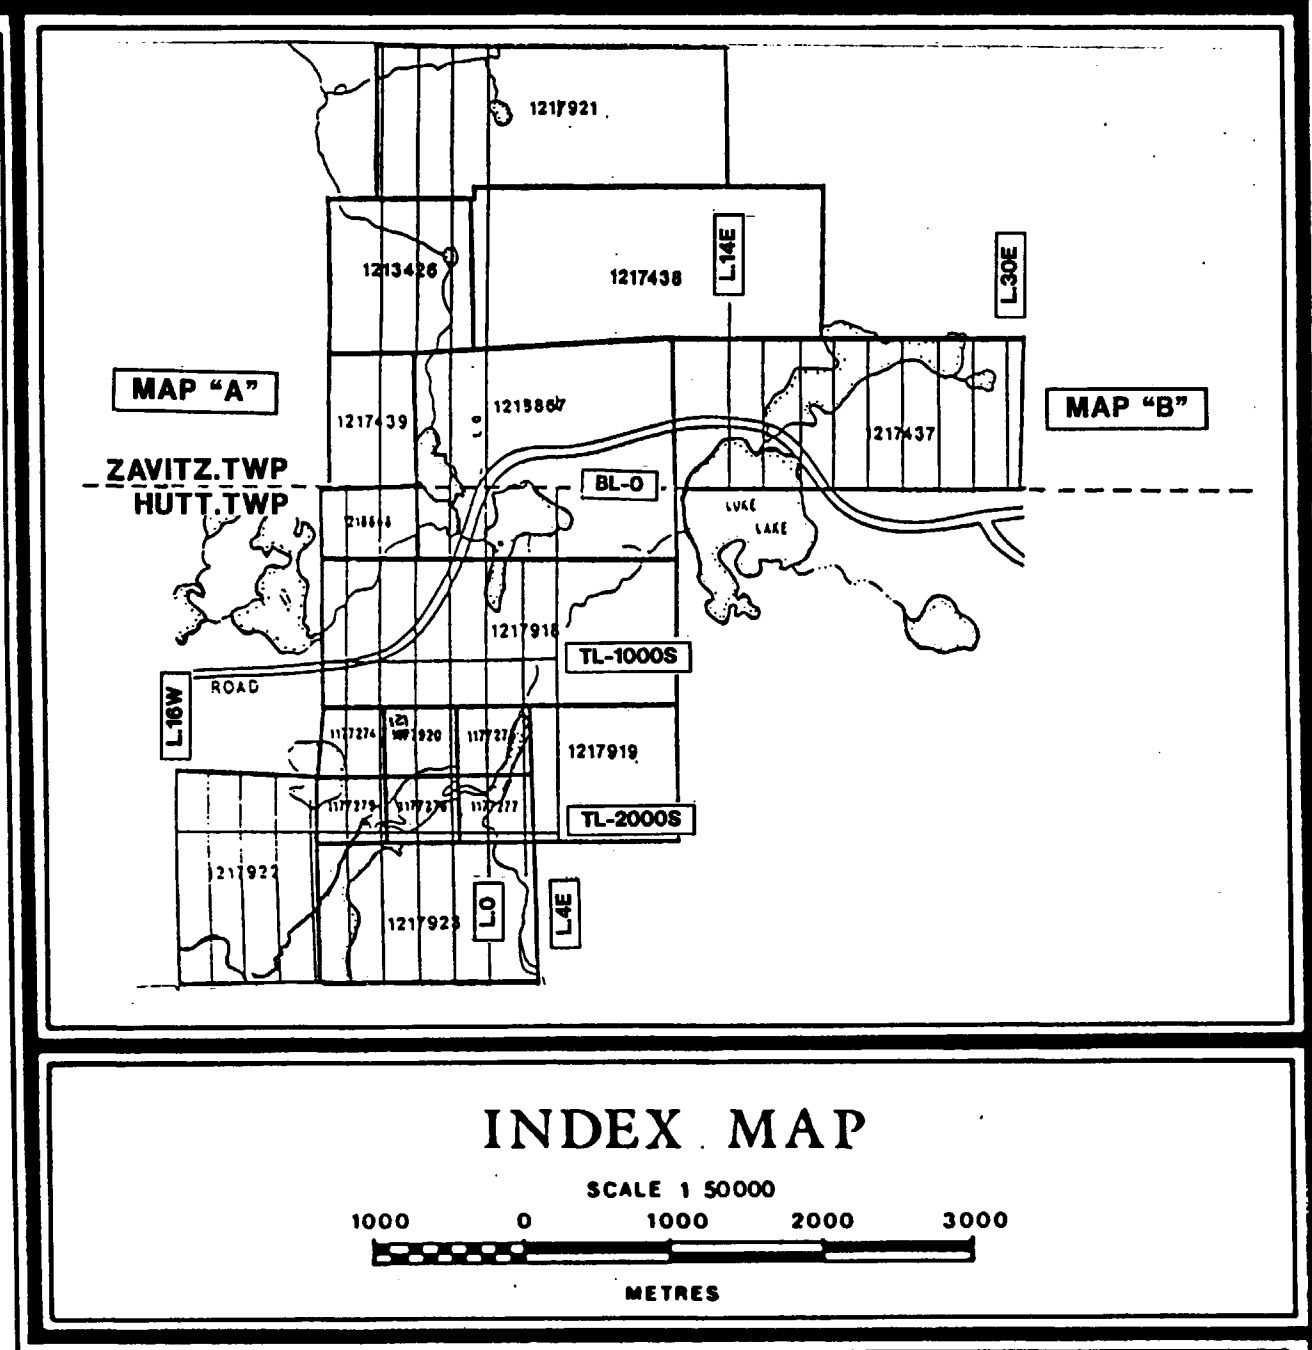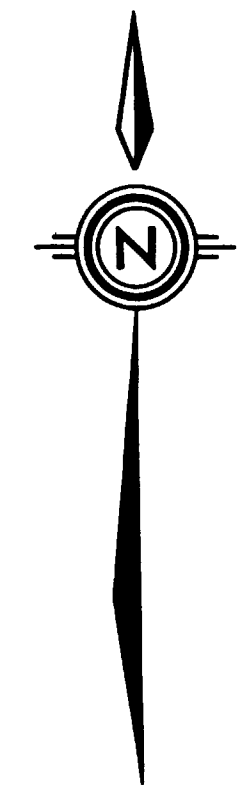

INDEX MAP

SCALE 1:50000
1000 0 1000 2000 3000
METRES

LEGEND

- A** Volcanic rocks
- B** Sedimentary rocks
- C** Iron formation

SYMBOLS

- Fault zone
- Geological contact

RECEIVED
JUL 0 2 1997
MINING LANDS BRANCH



220

MAGNETOMETER SURVEY
INTERPRETATION MAP
FOR
INMET MINING CORPORATION

PROJECT: MATAWEST PROJECT MAP "B"



Instrument:
OMNI IV

SURVEYED BY: S. BROUSSEAU DATE: MAI 1997
DRAWN BY: N. SINCLAIR SCALE: 1:5,000


TWR HUTT & ZAVITZ

SERVICES EXPLORATION SERVICES ENRG. REG'D.

2600 N.
2500 N.
2400 N.
2300 N.
2200 N.
2100 N.
2000 N.
1900 N.
1800 N.
1700 N.
1600 N.
1500 N.
1400 N.
1300 N.
1200 N.
1100 N.
1000 N.
900 N.
800 N.
700 N.
600 N.
500 N.
400 N.
300 N.
200 N.
100 N.
0
100 S.
200 S.
300 S.
400 S.
500 S.
600 S.
700 S.
800 S.
900 S.
1000 S.
1100 S.
1200 S.
1300 S.
1400 S.
1500 S.
1600 S.
1700 S.
1800 S.
1900 S.
2000 S.
2100 S.
2200 S.
2300 S.
2400 S.
2500 S.
2600 S.
2700 S.
2800 S.

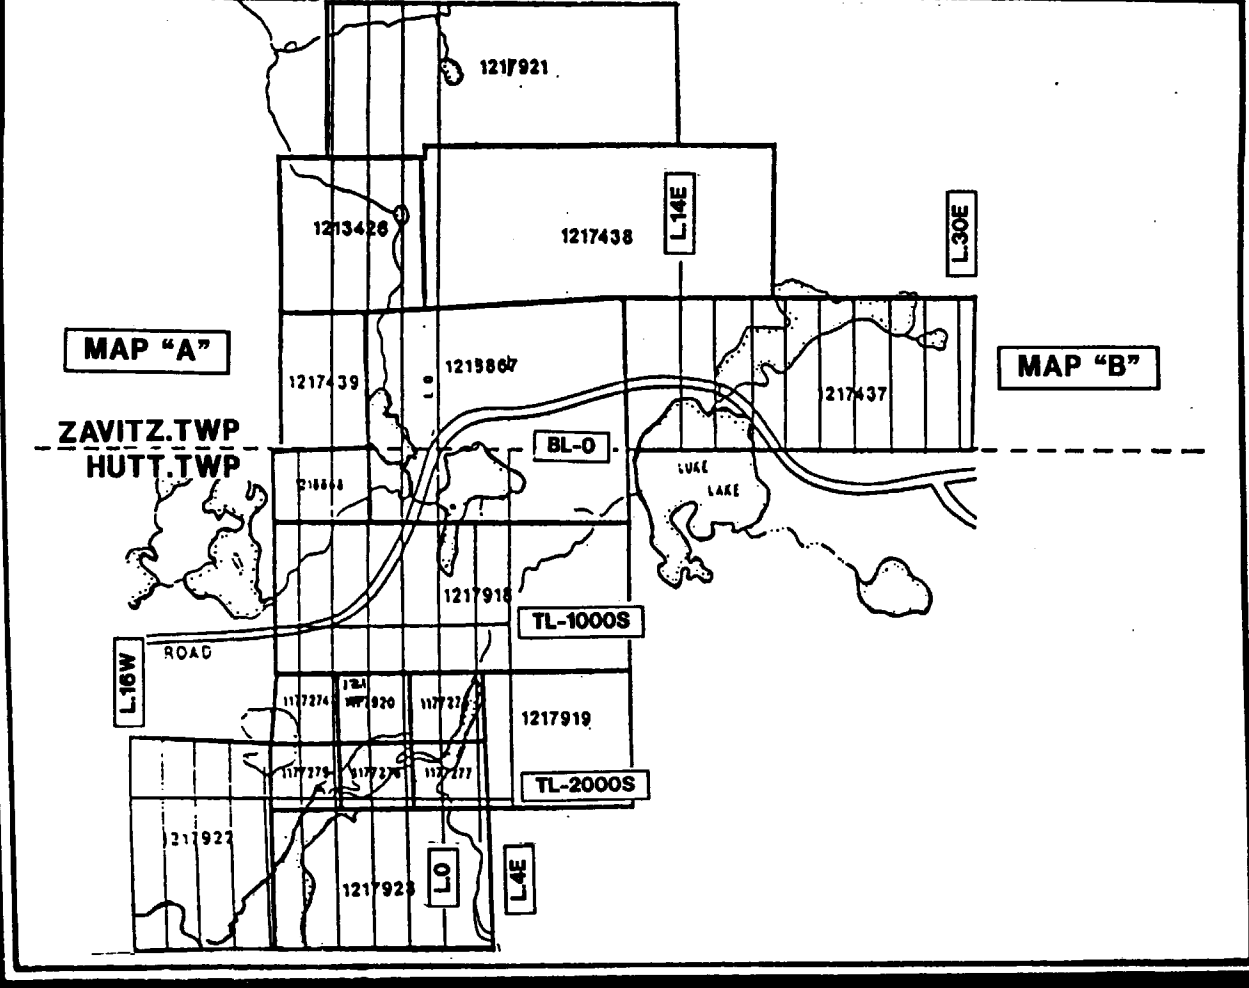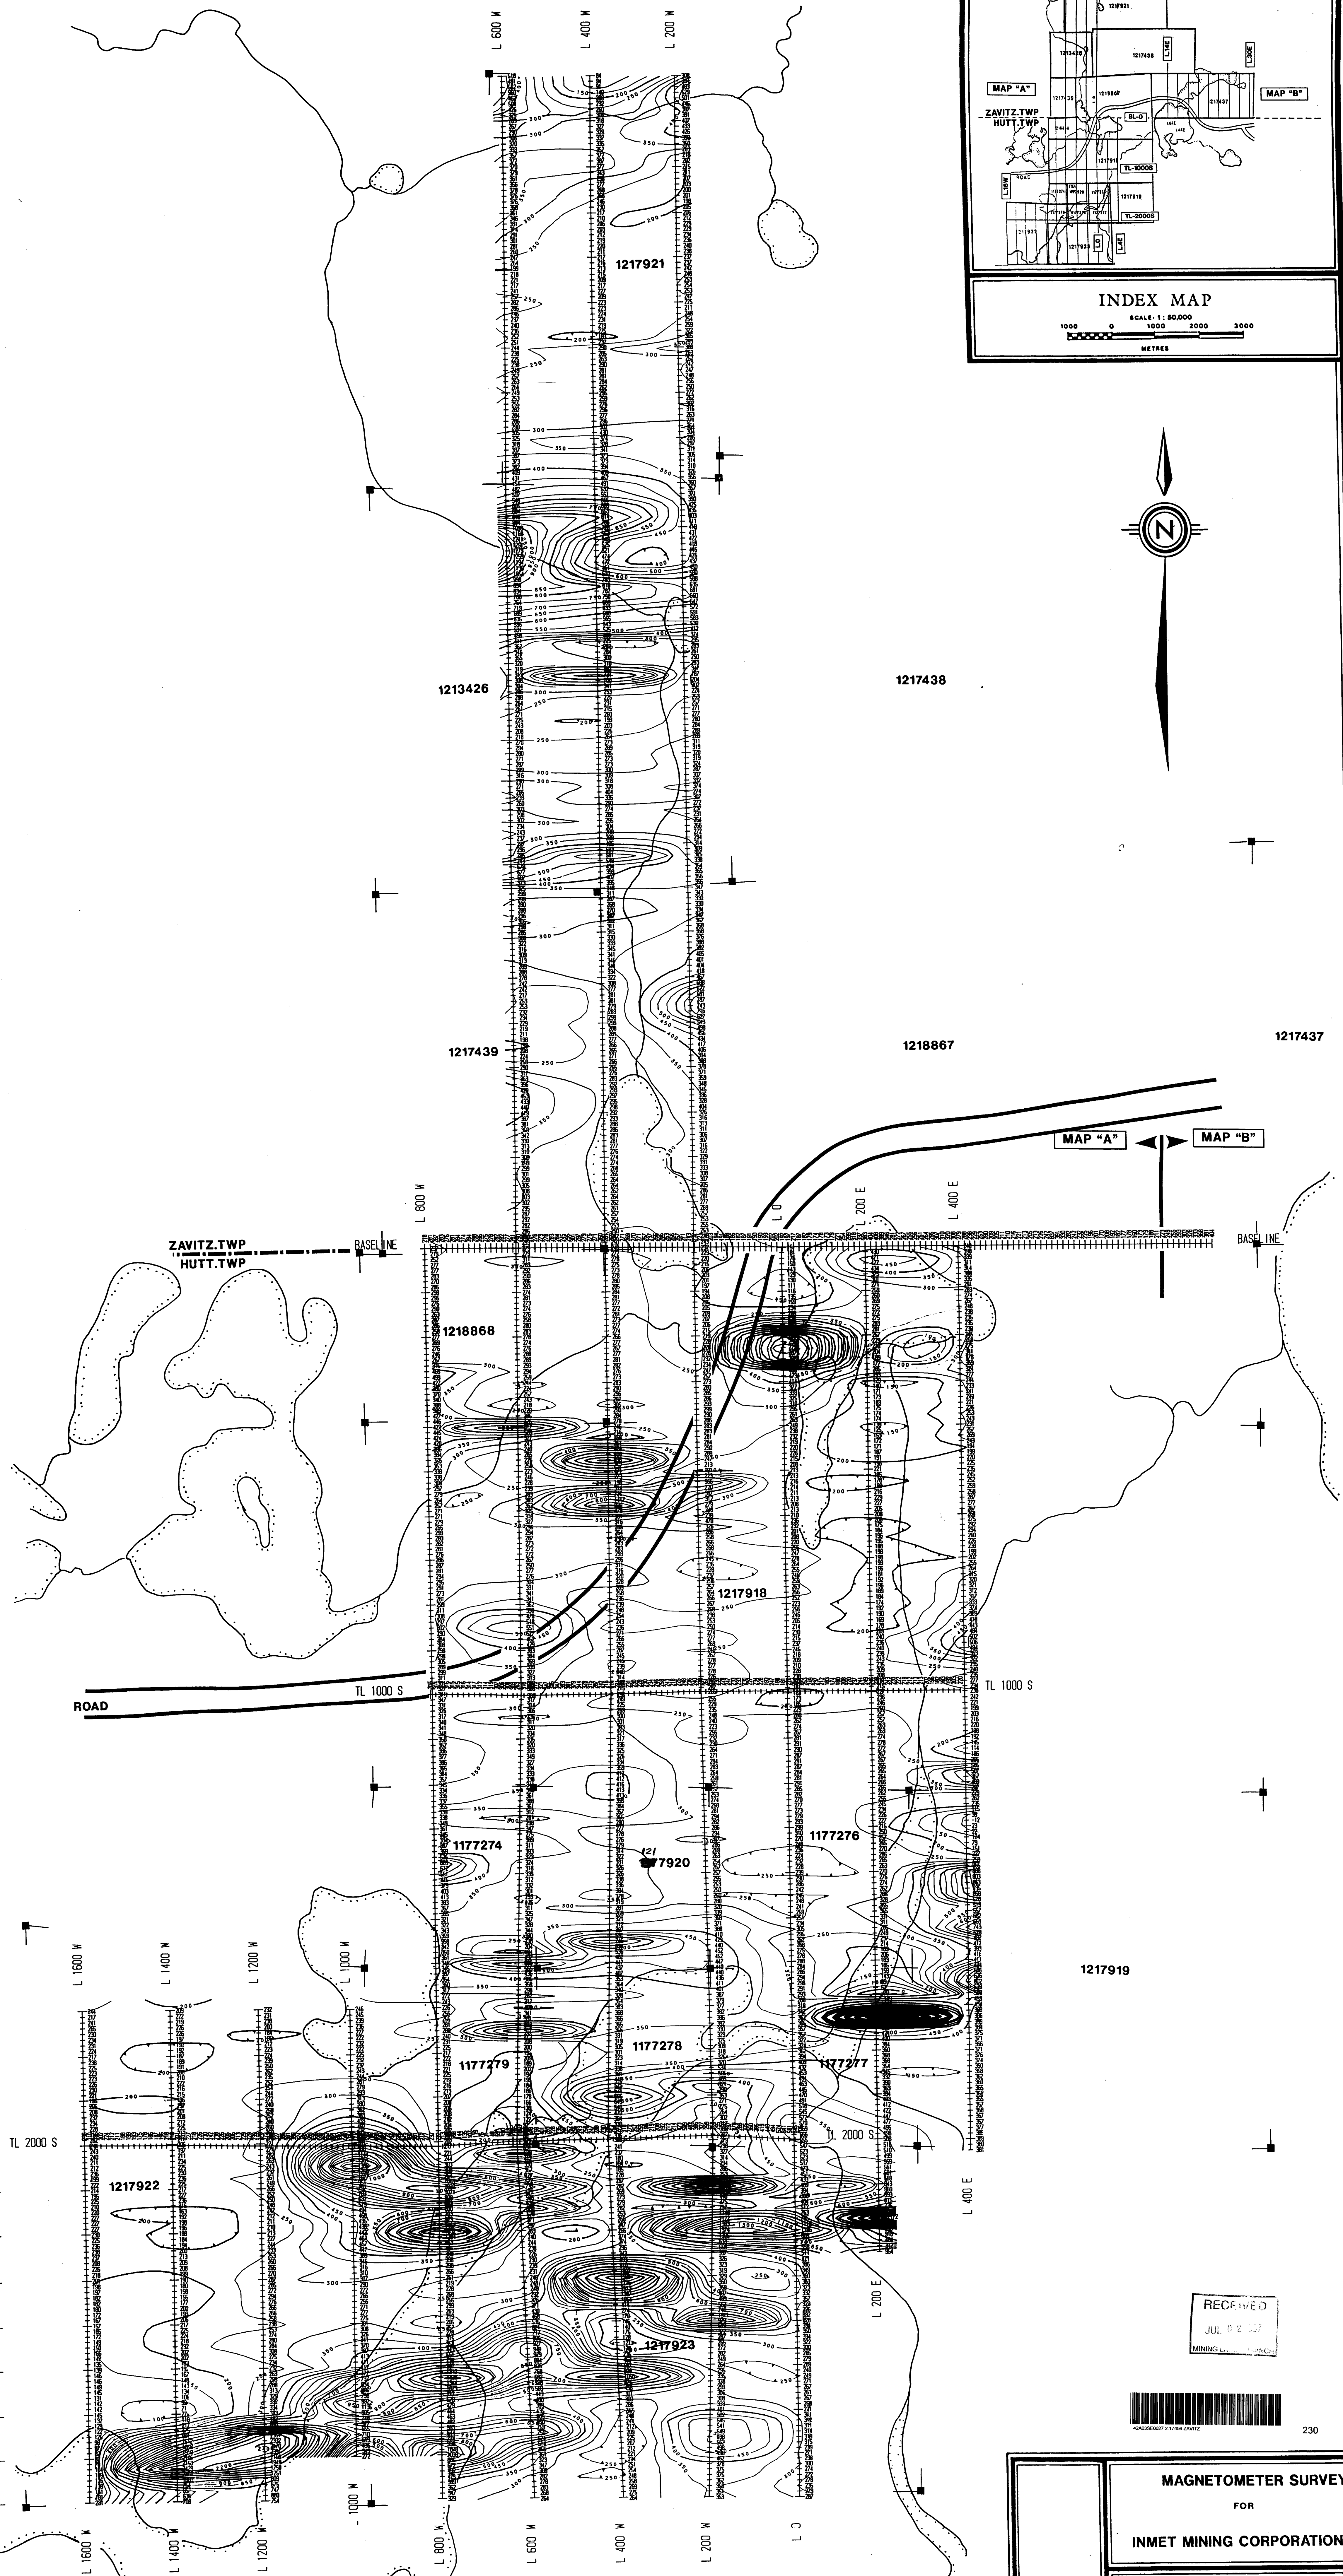

INDEX MAP
SCALE: 1:50,000
1000 0 1000 2000 3000
METRES

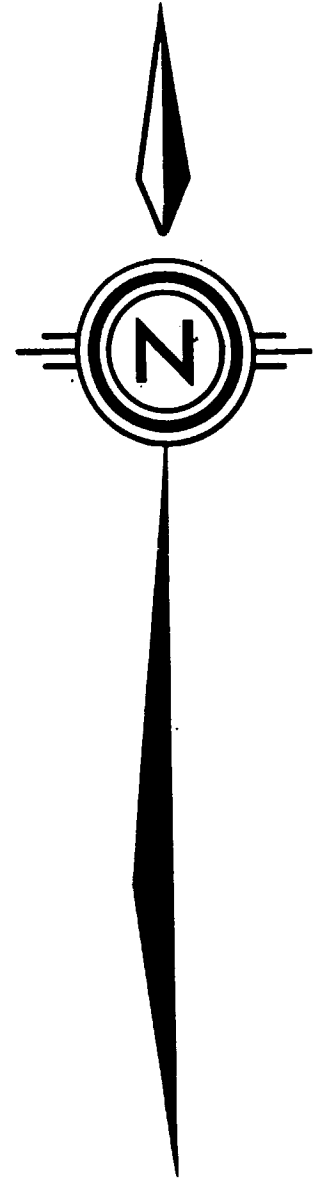

MAP "A" MAP "B"

ZAVITZ.TWP
HUTT.TWP

ROAD

BASELINE

BASELINE

MAP "A"

RECEIVED
JUL 08 2007
MINING LAW & SURVEY



230

MAGNETOMETER SURVEY	
FOR	
INMET MINING CORPORATION	
PROJECT: MATAWEST PROJECT MAP "A"	
Instrument: OMNI IV	SURVEYED BY: S. BOUTISSEAU DATE: JUL 2007
Drawn by: N. SINCLAIR	SCALE: 1:5,000
SERVICES EXPLORATION SERVICES ENRG. RESO.	

1400 N
1300 N
1200 N
1100 N
1000 N
900 N
800 N
700 N
600 N
500 N
400 N
300 N
200 N
100 N
0 BASELINE

1217438

1218867

L 1400 E

L 1600 E

L 1800 E

L 2000 E

L 2200 E

L 2400 E

L 2600 E

L 2800 E

L 3000 E

L 1400 E

L 1600 E

L 1800 E

L 2000 E

L 2200 E

L 2400 E



L 2600 E

L 2800 E

L 3000 E

LUKE LAKE

MAP "B"

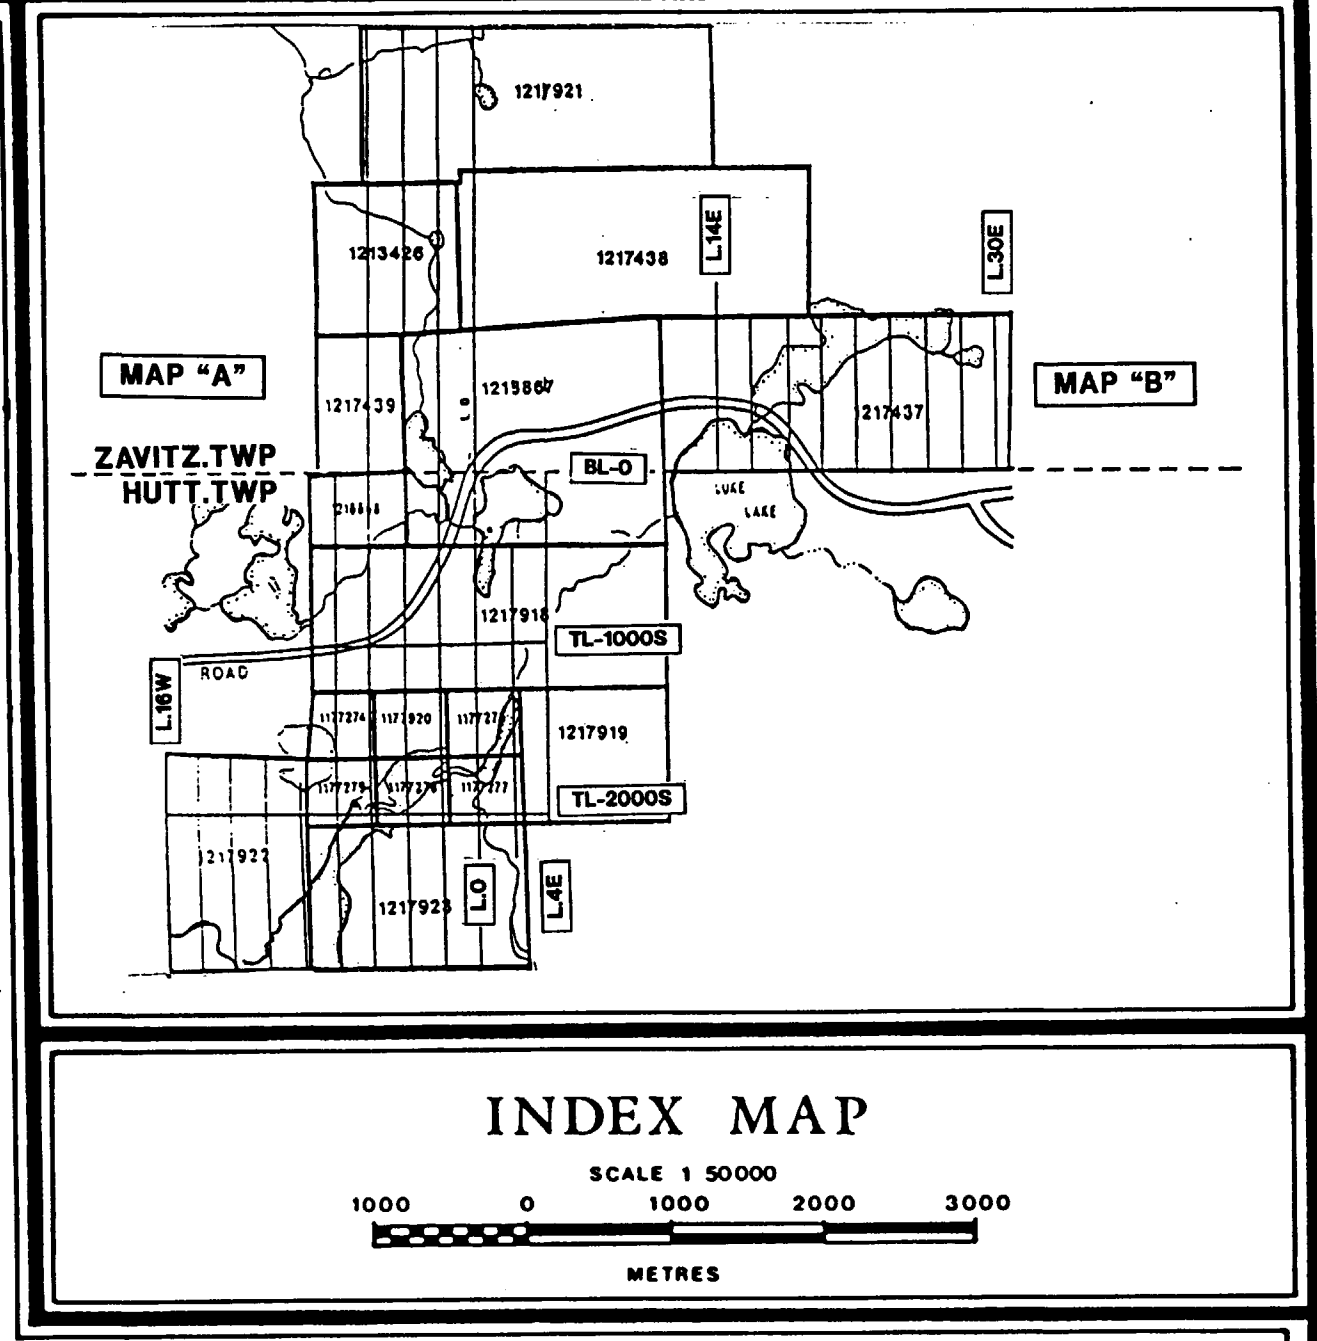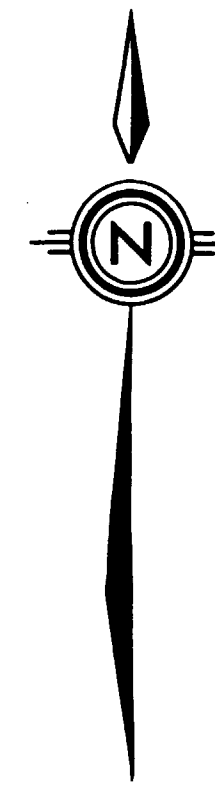

RECEIVED
JUL 0 2 1997
LANDS BNA CH



240

ZAVITZ.TWP
HUTT.TWP

MAGNETOMETER SURVEY
FOR
INMET MINING CORPORATION

PROJECT: **MATAWEST PROJECT** MAP "B"



Instrument:
OMNI IV

SURVEYED BY: S. BROUSSEAU DATE: MAL 1997
DRAWN BY: N. SINCLAIR SCALE: 1:5,000


TWP. HUTT & ZAVITZ

SERVICES EXPLORATION SERVICES ENRG.
REG'D.

2600 N.
2500 N.
2400 N.
2300 N.
2200 N.
2100 N.
2000 N.
1900 N.
1800 N.
1700 N.
1600 N.
1500 N.
1400 N.
1300 N.
1200 N.
1100 N.
1000 N.
900 N.
800 N.
700 N.
600 N.
500 N.
400 N.
300 N.
200 N.
100 N.
0
100 S.
200 S.
300 S.
400 S.
500 S.
600 S.
700 S.
800 S.
900 S.
1000 S.
1100 S.
1200 S.
1300 S.
1400 S.
1500 S.
1600 S.
1700 S.
1800 S.
1900 S.
2000 S.
2100 S.
2200 S.
2300 S.
2400 S.
2500 S.
2600 S.
2700 S.
2800 S.

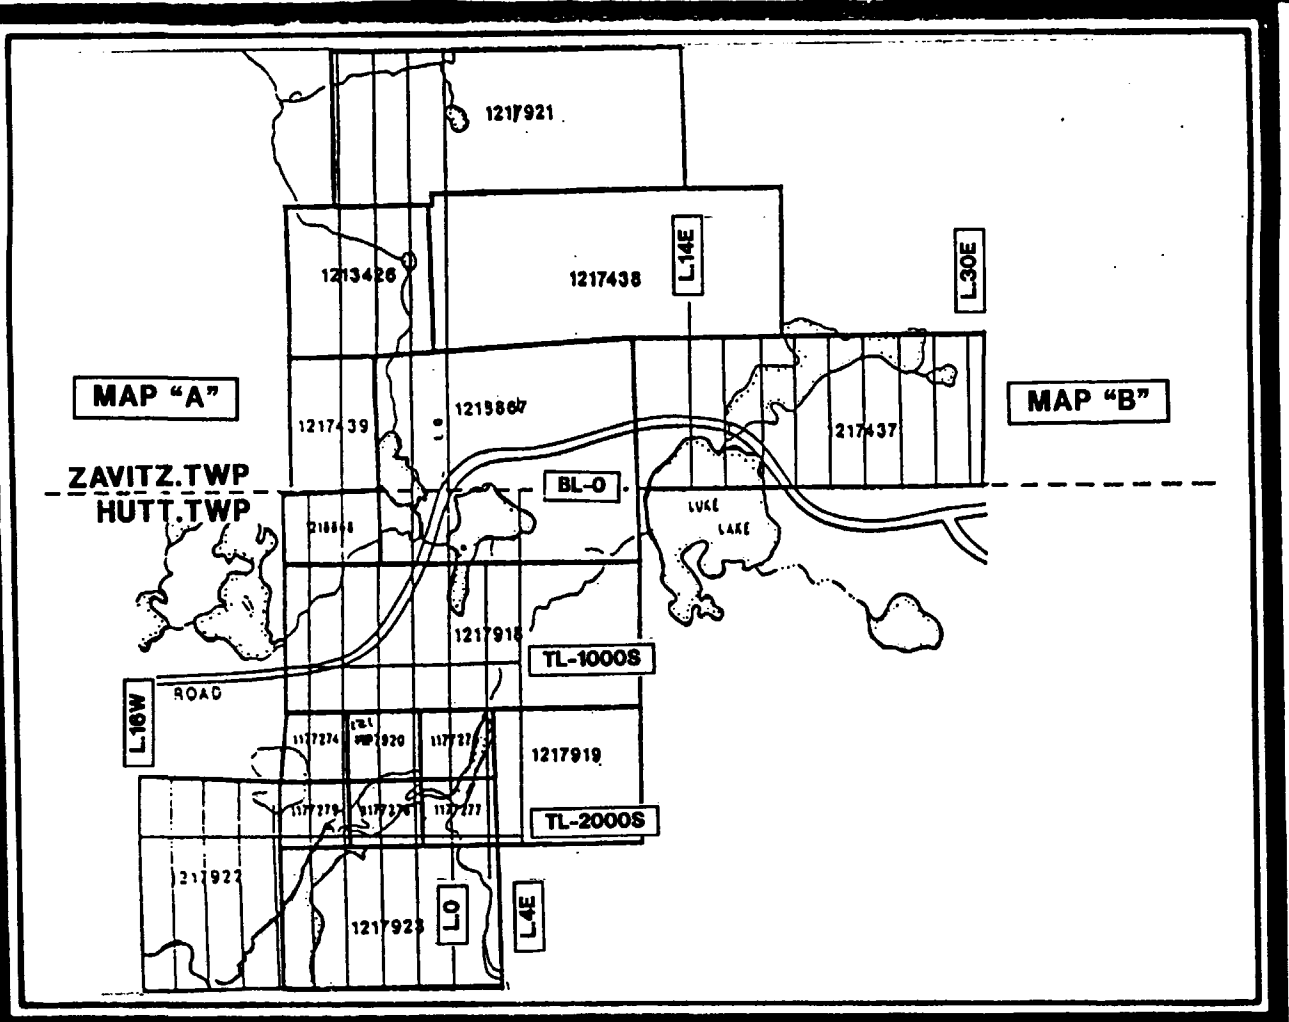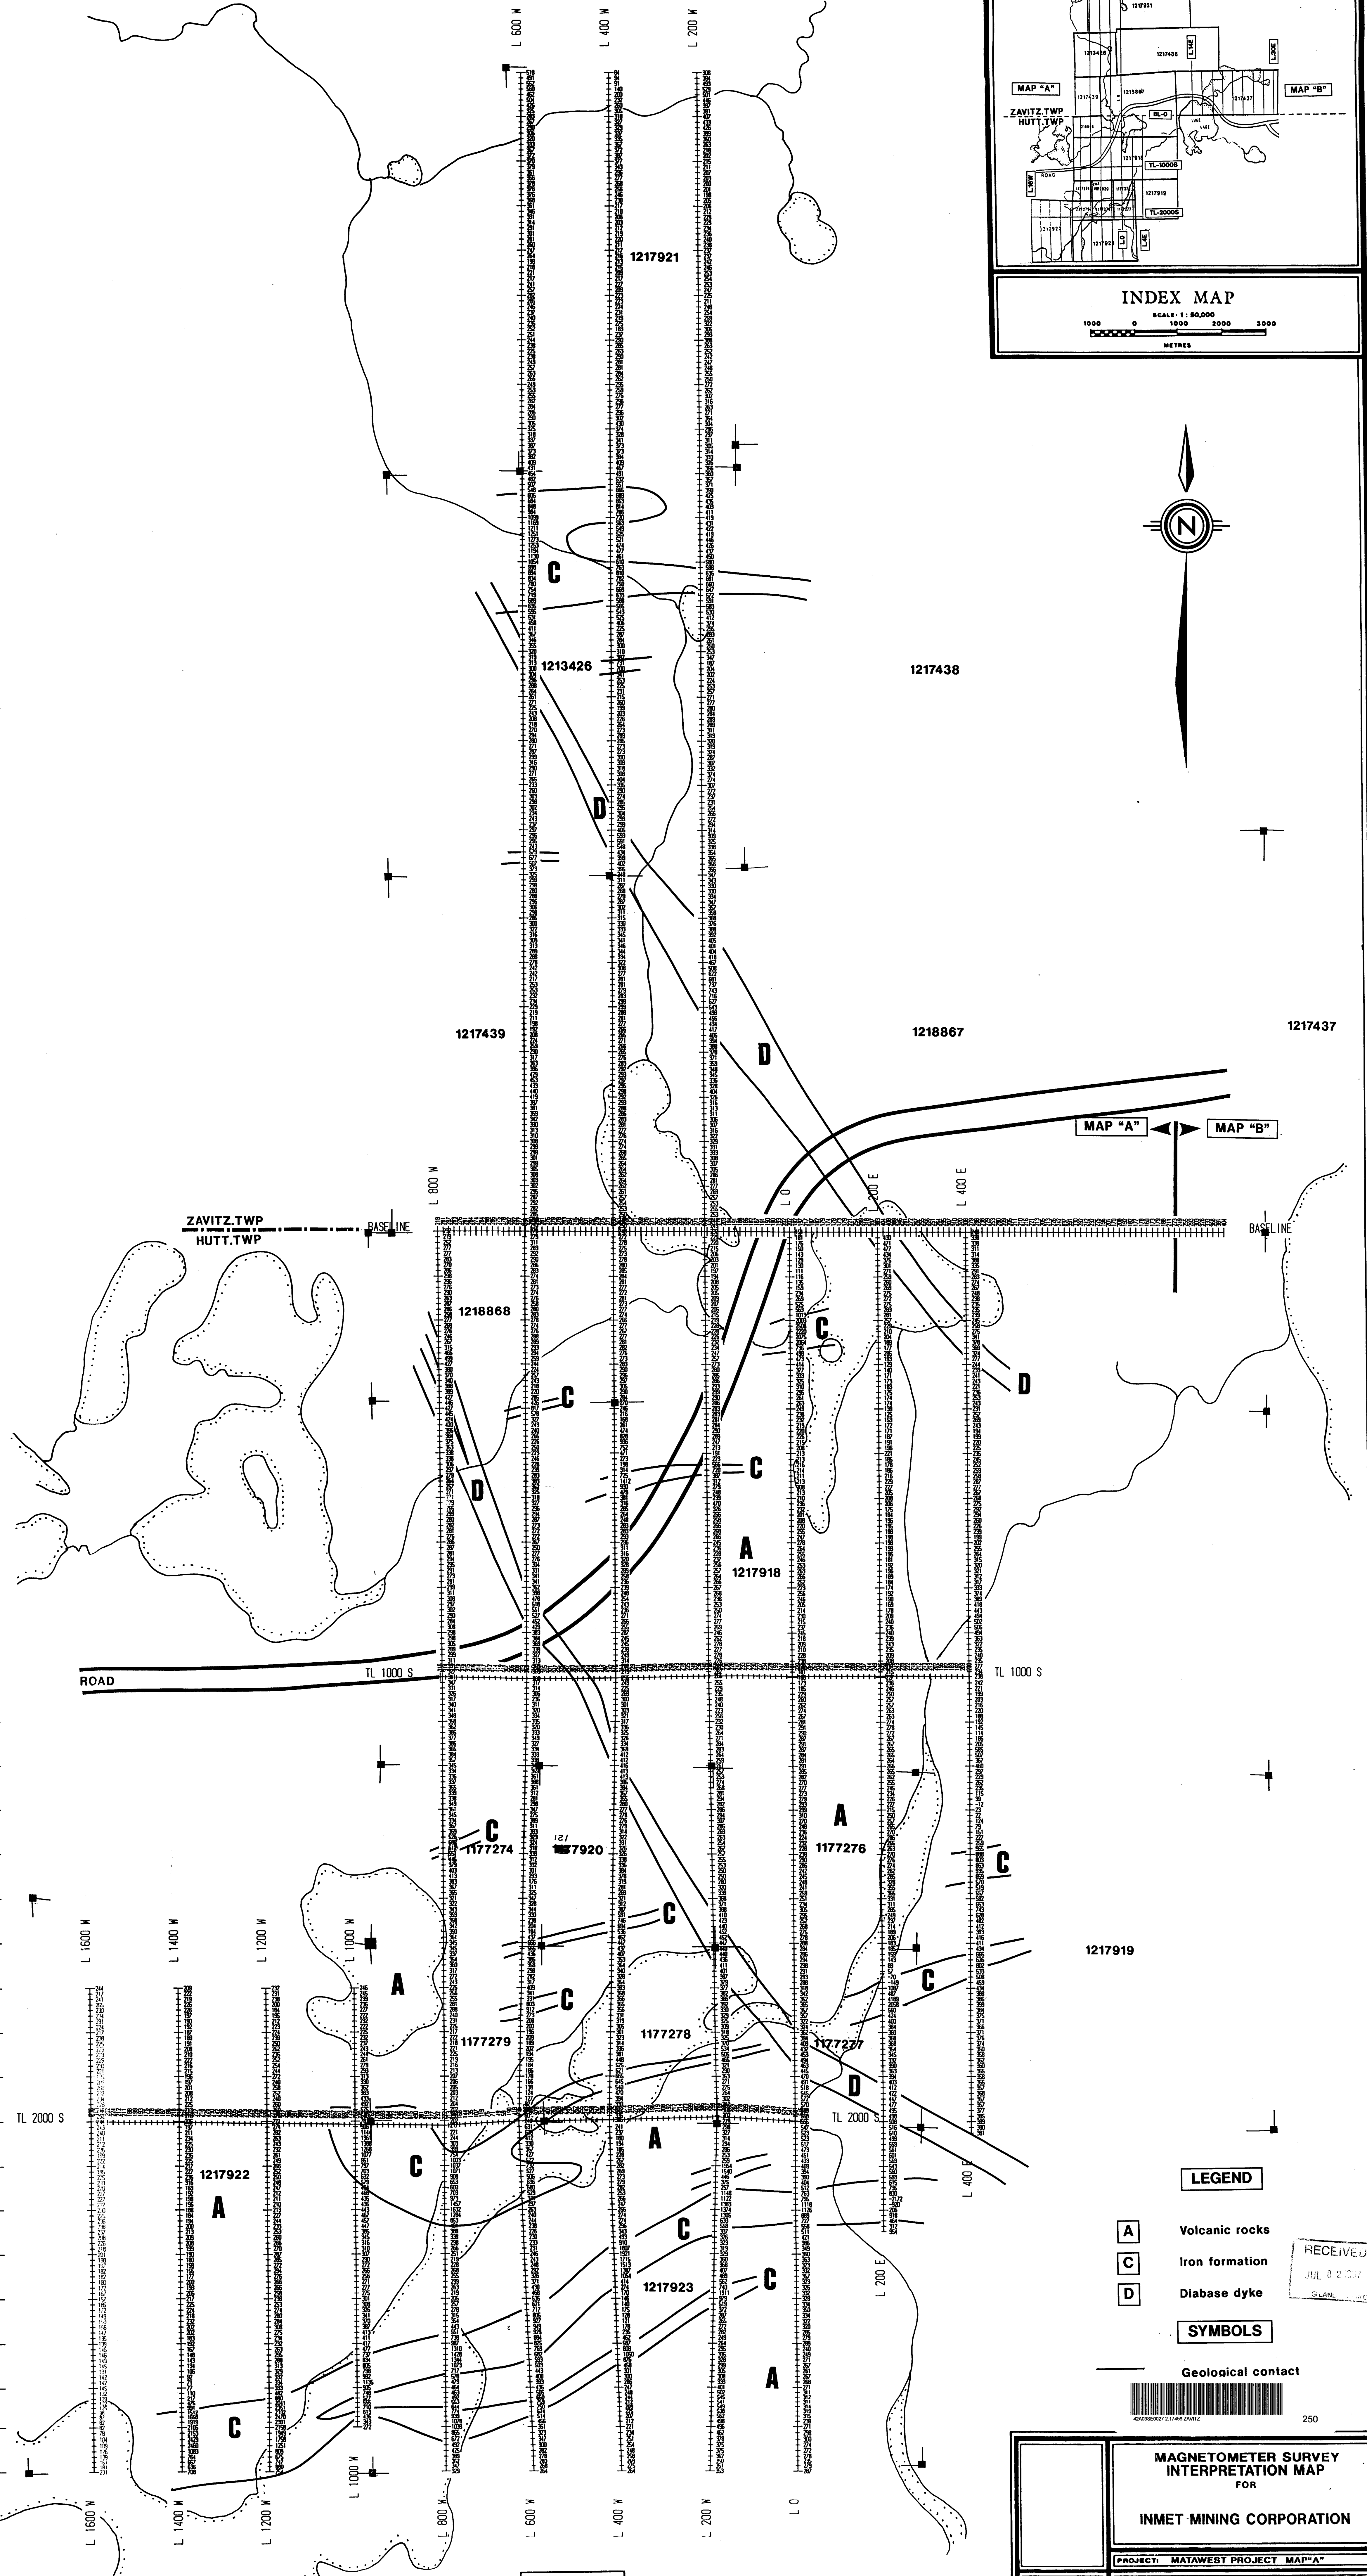

INDEX MAP
SCALE: 1:80,000
1000 0 1000 2000 3000
METRES

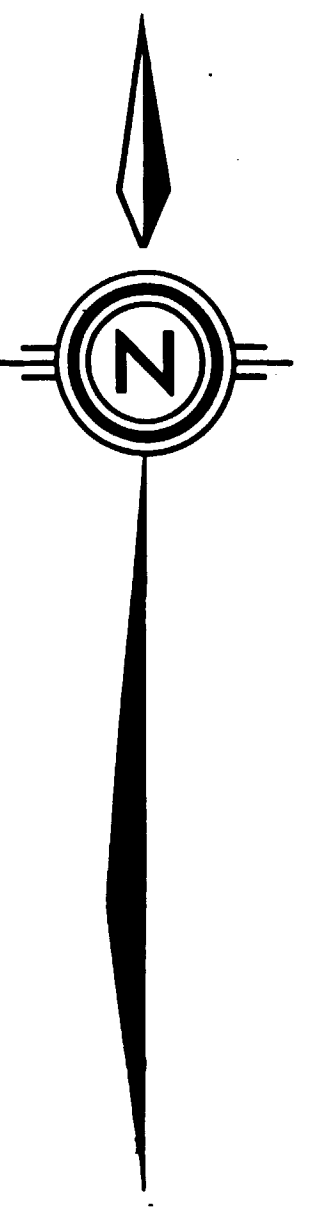

MAP "A" MAP "B"

LEGEND

- A** Volcanic rocks
- C** Iron formation
- D** Diabase dyke

SYMBOLS

Geological contact



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SLAN


MAGNETOMETER SURVEY INTERPRETATION MAP FOR INMET-MINING CORPORATION

PROJECT: MATAWEST PROJECT MAP "A"



Instrument: OMNI IV
SURVEYED BY: S. BROUSSEAU DATE: MAY 1997
DRAWN BY: N. SINCLAIR SCALE: 1:5,000

ENRREG. REGD. SERVICES EXPLORATION SERVICES

MAP "A"

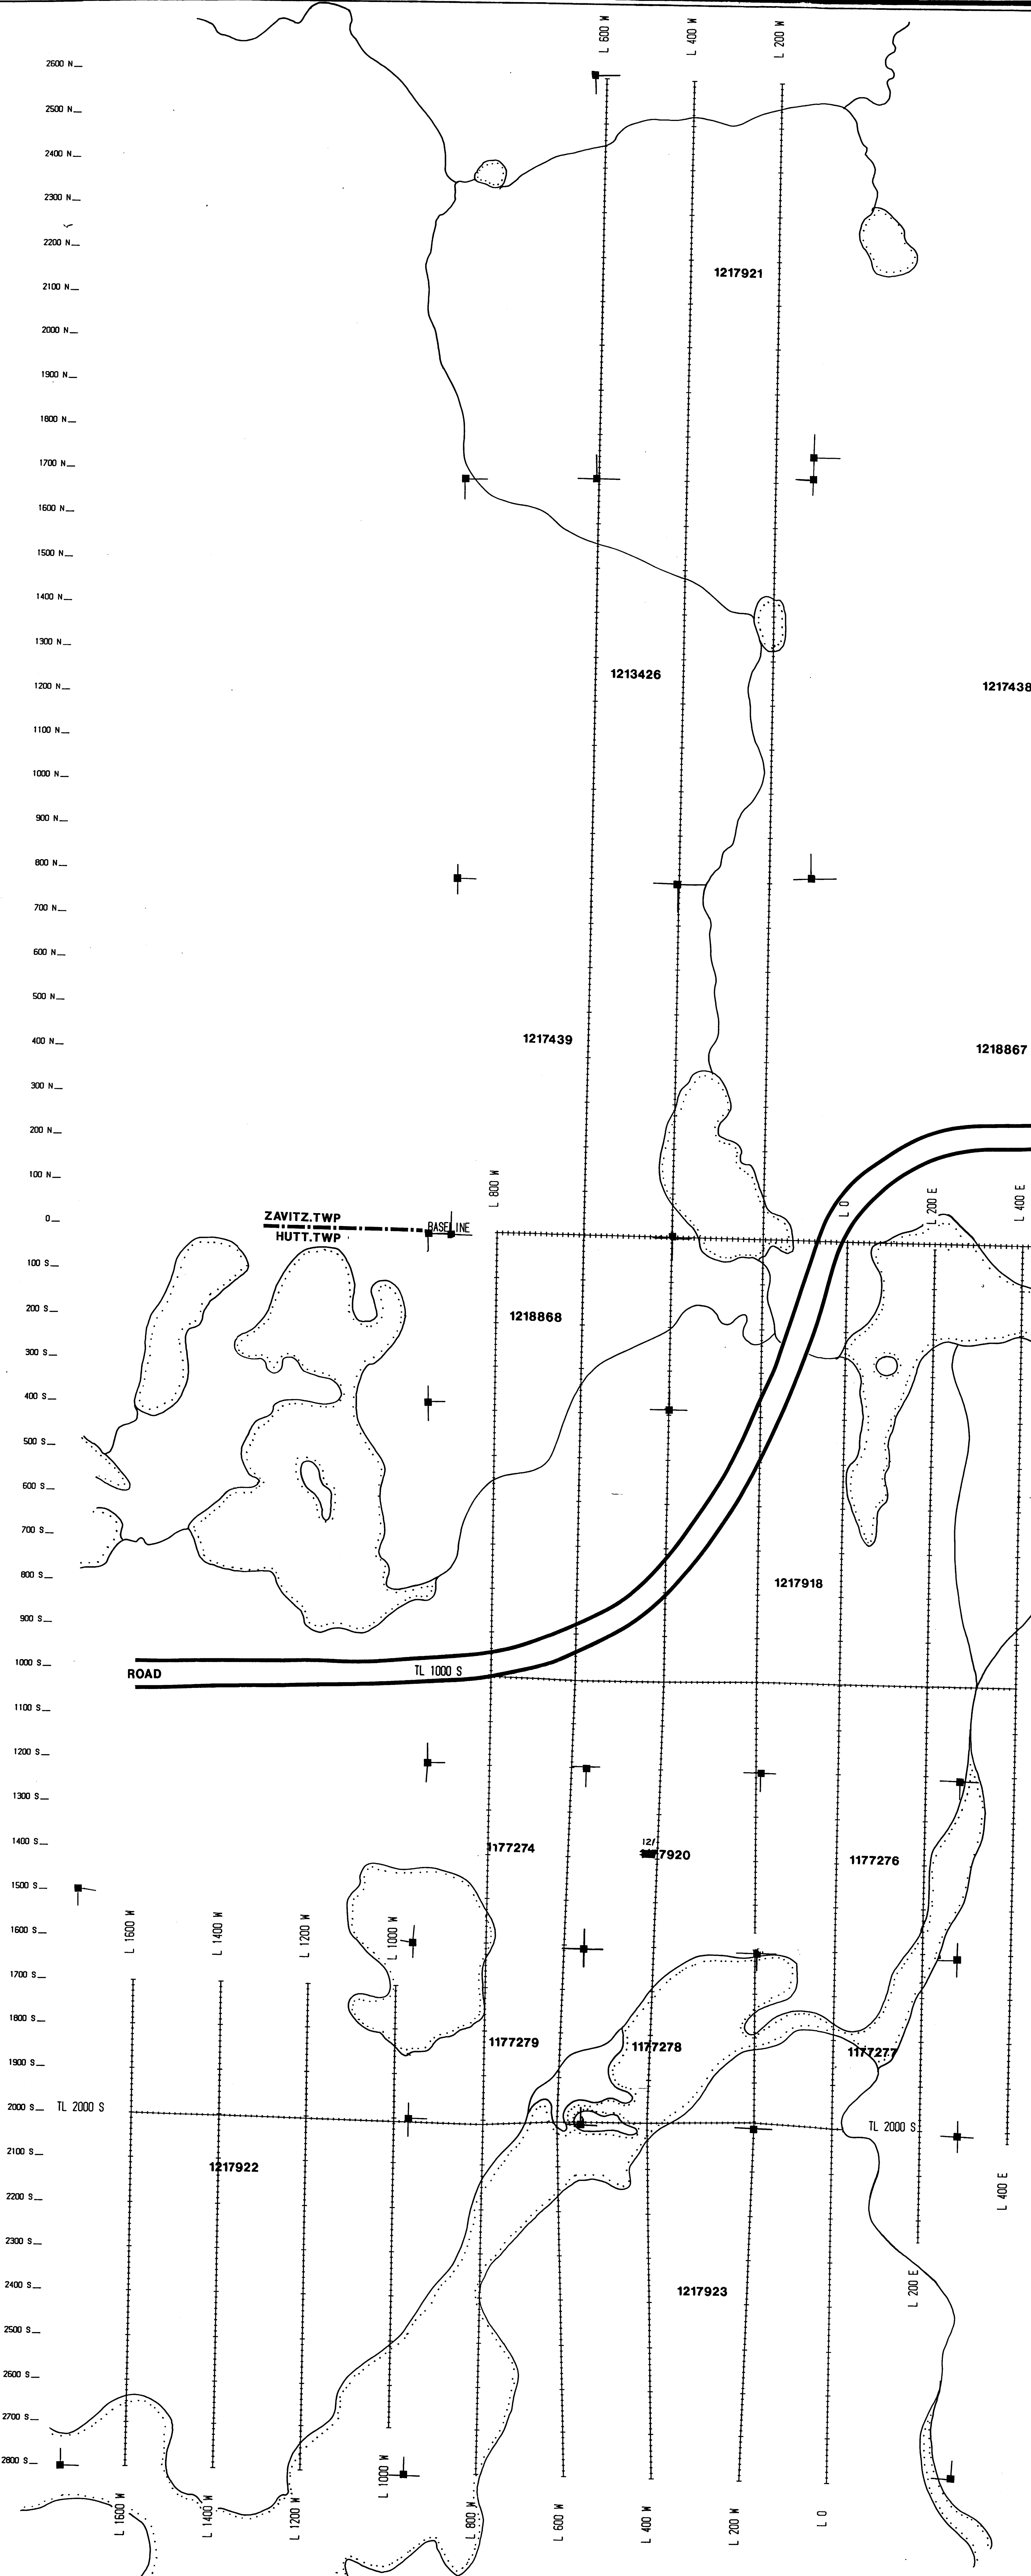

2600 N.
2500 N.
2400 N.
2300 N.
2200 N.
2100 N.
2000 N.
1900 N.
1800 N.
1700 N.
1600 N.
1500 N.
1400 N.
1300 N.
1200 N.
1100 N.
1000 N.
900 N.
800 N.
700 N.
600 N.
500 N.
400 N.
300 N.
200 N.
100 N.
0
100 S.
200 S.
300 S.
400 S.
500 S.
600 S.
700 S.
800 S.
900 S.
1000 S.
1100 S.
1200 S.
1300 S.
1400 S.
1500 S.
1600 S.
1700 S.
1800 S.
1900 S.
2000 S. TL 2000 S.
2100 S.
2200 S.
2300 S.
2400 S.
2500 S.
2600 S.
2700 S.
2800 S.

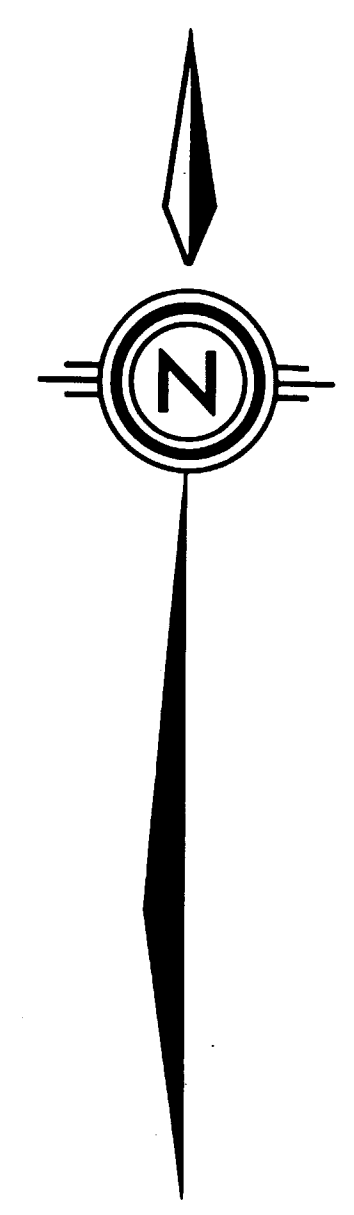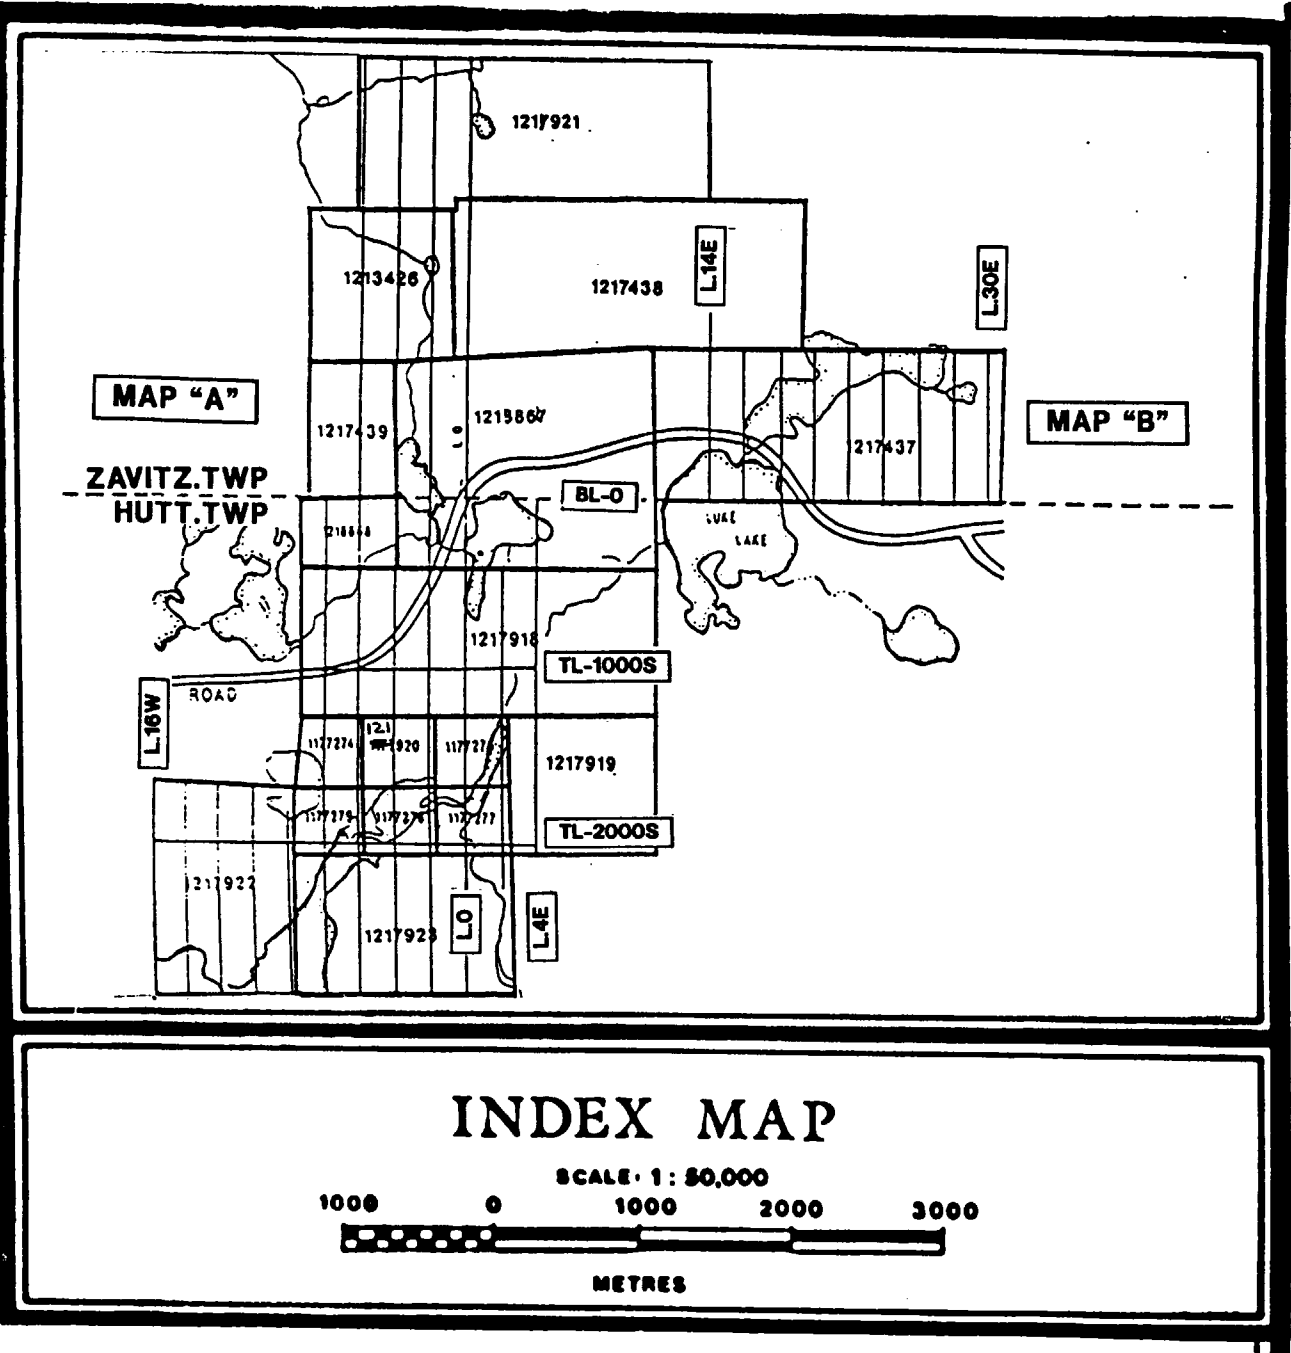

MAP "A" MAP "B"

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JUL 02 1997



MAP "A"





LINE CUTTING MAP	
FOR	
INMET MINING CORPORATION	
PROJECT: MATAWEST PROJECT MAP "A"	
Instrument: OMNI IV	SURVEYED BY: S. BROUSSEAU DATE: MAY 1997
Drawn by: N. SINCLAIR	SCALE: 1:5,000
SERVICES EXPLORATION SERVICES ENRG. REGD.	

1400 N.
1300 N.
1200 N.
1100 N.
1000 N.
900 N.
800 N.
700 N.
600 N.
500 N.
400 N.
300 N.
200 N.
100 N.
0 BASELINE

1217438

1218867

1217437

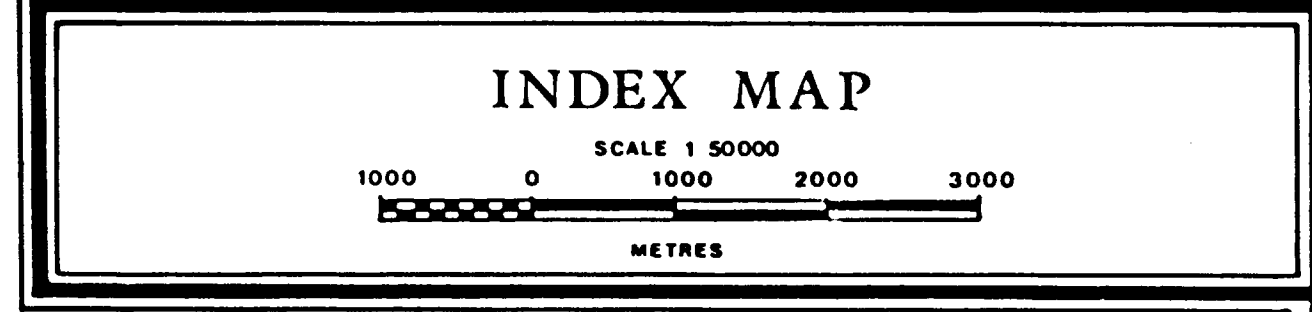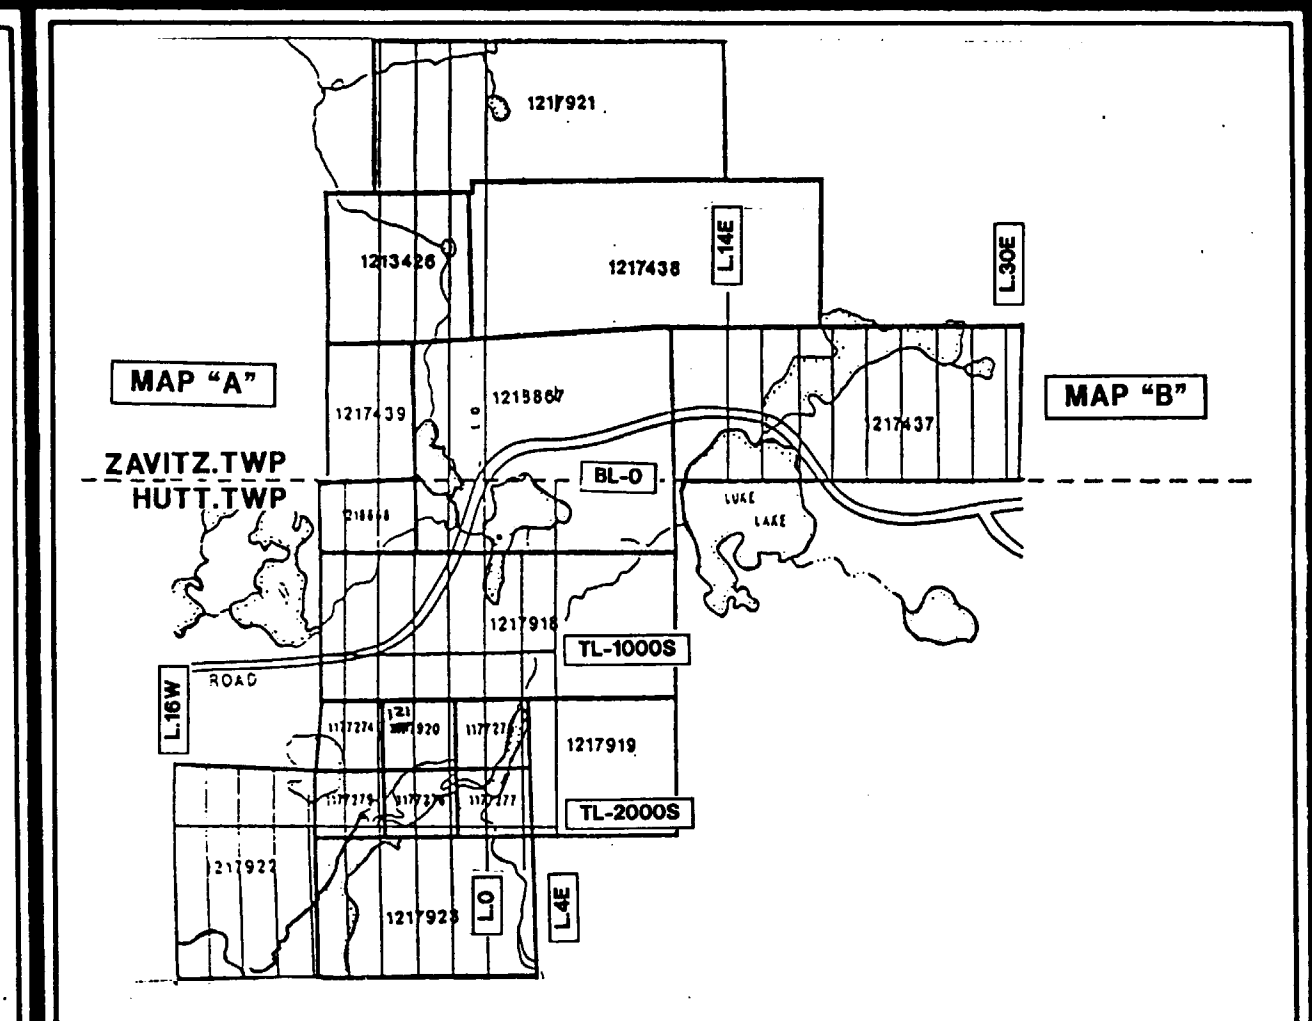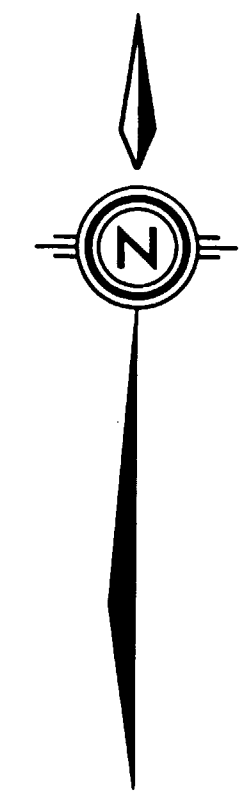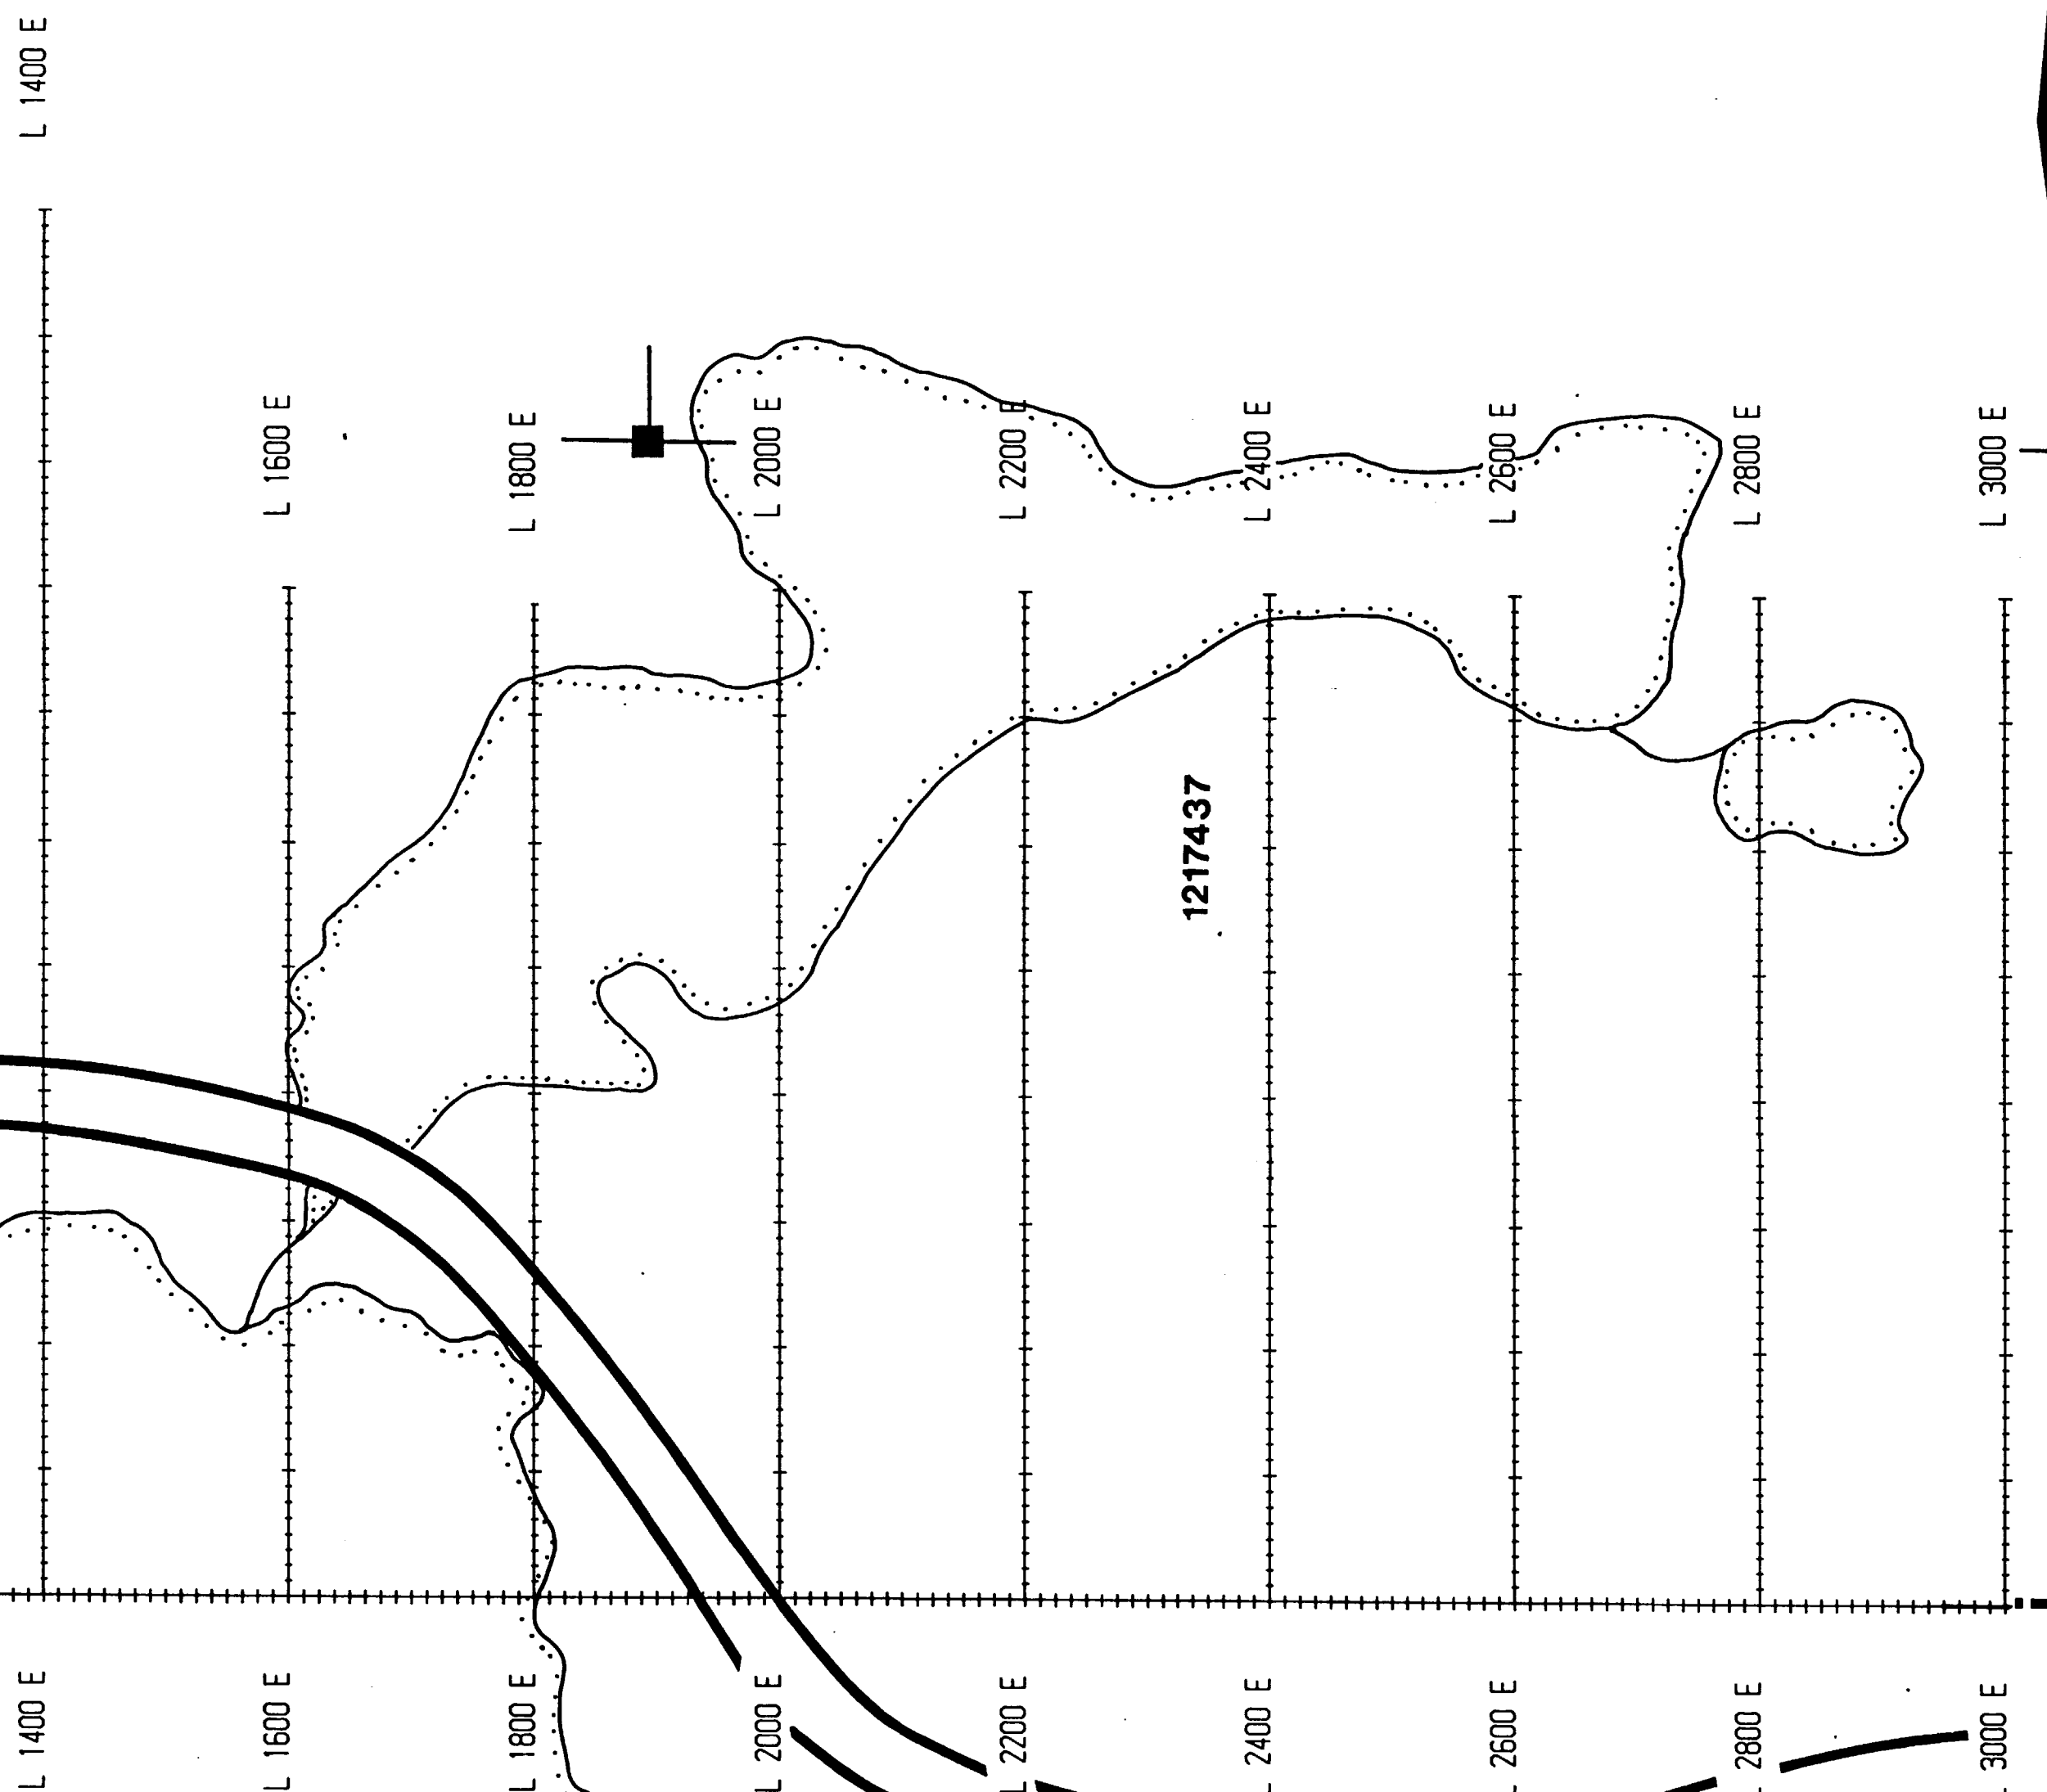

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JUL 0 2 1997
S. BROSSEAU BRANCH



270

ZAVITZ.TWP
HUTT.TWP

MAP "B"

LINE CUTTING MAP	
FOR	
INMET MINING CORPORATION	
PROJECT:	MATAWEST PROJECT MAP "B"
SURVEYED BY:	S. BROUSSEAU DATE: MAI 1997
DRAWN BY:	N. SINCLAIR SCALE: 1:5000
SERVICES EXPLORATION SERVICES ENRG. REG'D.	

Instrument:	OMNI IV
TWP:	HUTT & ZAVITZ