

2.16028




42A05NE0025 2.16028 GODFREY

010

GEOPHYSICAL REPORT  
FOR  
RICHARD AND ROBIN MATHIEU  
ON THE  
GODFREY GOLD PROSPECT  
GODFREY TOWNSHIP  
PORCUPINE MINING DIVISION  
NORTHEASTERN, ONTARIO

PREPARED BY: John C. Grant CET, FGAC  
March 1995

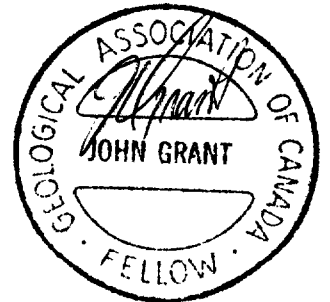



42A05NE0025 2.16028 GODFREY

010C

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## INTRODUCTION

Richard and Robin Mathieu retained the services of J. C. Grant of Exsics Exploration Limited to plot and interpret the results of a Total Field Magnetic Survey which was completed on a group of 3 claims located in a southeast corner of Godfrey Township.

The purpose of this program was to locate and outline favourable geological structure which would represent a good target for gold deposition.

The linecutting commenced on June 16, 1994 but had to be postponed until February of 1995 due to flooding. The cutting was completed on Feb 16, 1995.

The magnetic survey on the summer cut lines was done between Nov 20 and 22, 1994 and the remaining survey was completed between Feb 22-23, 1995.

The report will deal with the results of the magnetic survey.

## LOCATION AND ACCESS

The Mathieu claim group discussed in this report represent the NW1/4, NE1/4 and SW1/4 of the S1/2 of Lot 12, Concession 1 of Godfrey Township, Porcupine Mining Division, District of Cochrane in Northeastern Ontario. Figure 2 and 3.

Access to the property during the survey period was ideal. Highway 101 travels west from the City of Timmins to the Mallette main haulage road which generally travels north and west through Bristol Township to the central portion of the Bristol and Godfrey Township line. This main haulage road then generally follows the Township line west into Turnbull Township and eventually northwest to current logging operations. This main haulage road provides 2 wheel drive access to the southern section of the claim group.

## CLAIM GROUP


The claims which make up a portion of the Mathieu holdings and will be discussed in this text are as follows:


P-1189769	1 unit
P-1189770	2 unit


Refer to Figure 3 of this report copied from MNDM plan Map G-3991, Godfrey Township scale 1:20,000


## PERSONNEL

The people directly involved with collecting the magnetic data were Richard and Robin Mathieu of Timmins. The computer compilation and plotting was handled by P. Gauthier of Exsics Exploration Limited. This report and interpretation was completed by J. C. Grant.

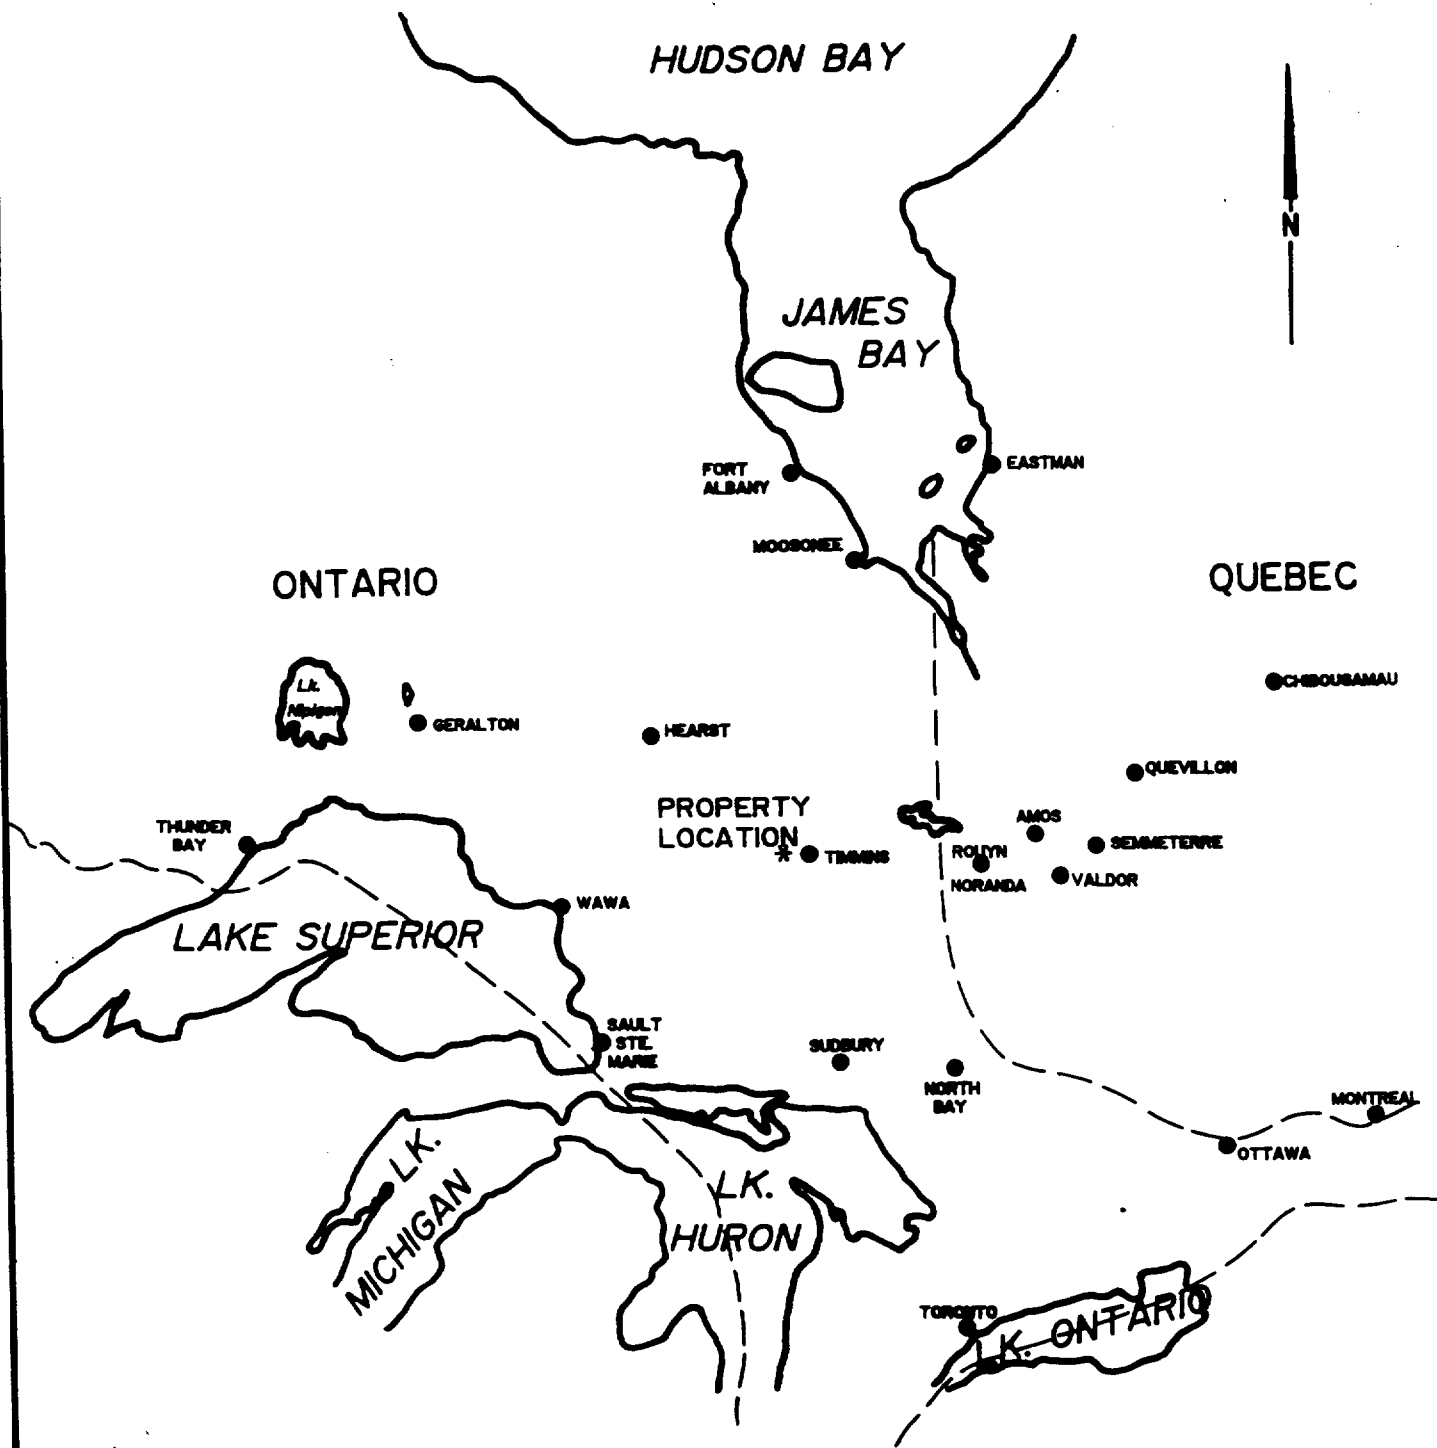

	<b>EXSICS EXPLORATION LTD.</b> P.O. Box 1000, P4M-7X1 Suite 13, Hollinger Bldg, Timmins Ont. Telephone: 705-267-4151	
	<b>CLIENT: R. &amp; R. MATHIEU</b>	
<b>PROPERTY: GODFREY TWP GOLD PROSPECT</b>		
<b>TITLE:</b> <div style="text-align: center; font-size: 1.2em;">LOCATION MAP</div> <div style="text-align: right;">Fig. 1</div>		
<b>Date:</b> March 1995	<b>Scale:</b> 1"=42.5miles	<b>NTS:</b>
<b>Drawn:</b> P.Gauthier	<b>Interp:</b> J.C. Grant	<b>Job No.</b> E-0

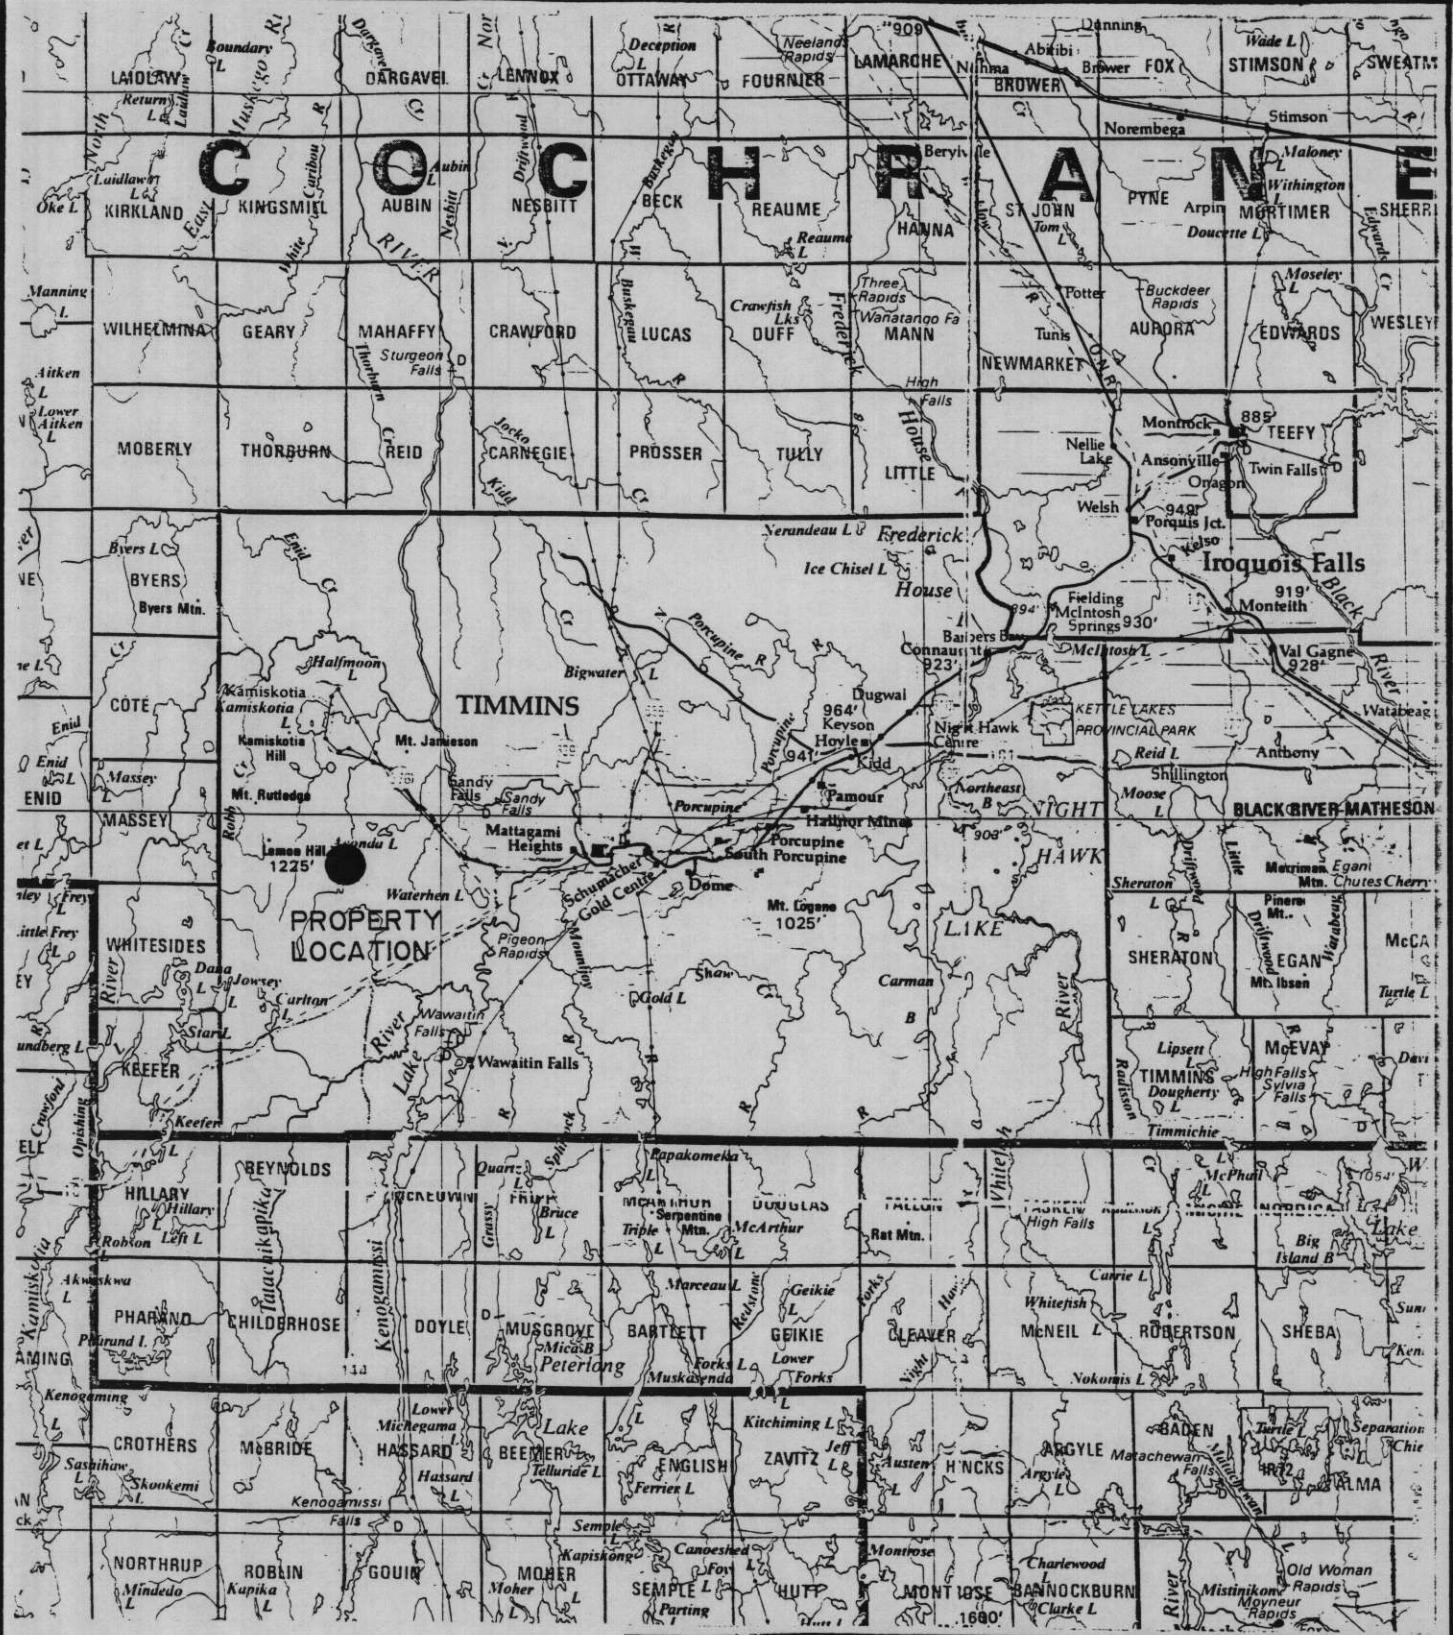



**EXSICS EXPLORATION LTD.**  
 P.O. Box 1888, P4N-7X1  
 Suite 13, Hollinger Bldg, Timmins Ont.  
 Telephone: 705-267-4511

---

**CLIENT:** R. & R. MATHIEU


**PROPERTY:** GODFREY TWP GOLD PROSPECT


**TITLE:** PROPERTY LOCATION

Fig. 2

Date: March 1995	Scale: 600,000	NTS:
Drawn:	Interp: J.C. Grant	Job No. E-0



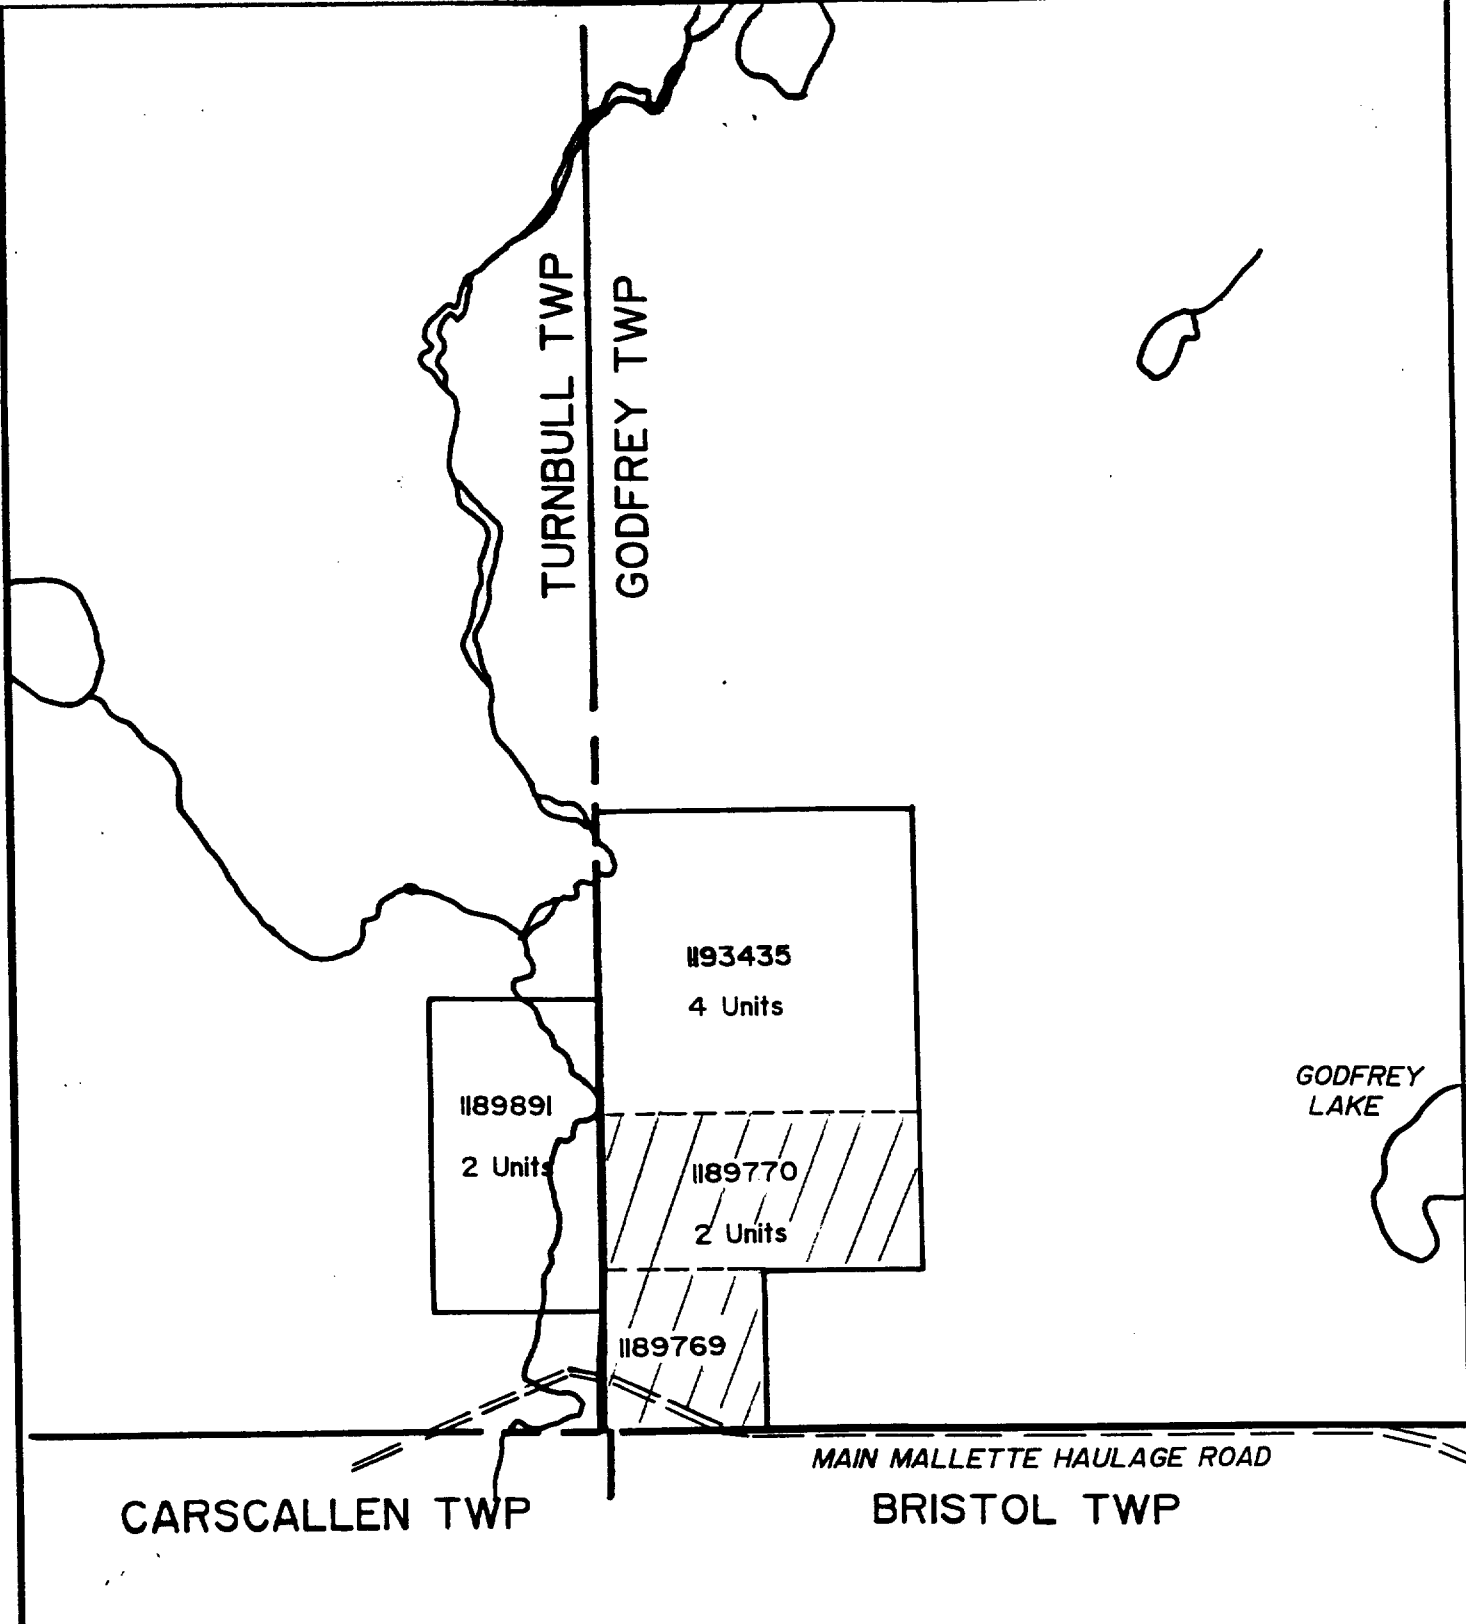

	<b>EXSICS EXPLORATION LTD.</b> P.O. Box 1000, P4N-7X1 Suite 13, Hollinger Bldg, Timmins Ont. Telephone: 705-267-4151	
	<b>CLIENT: R. &amp; R. MATHIEU</b>	
<b>PROPERTY: GODFREY TWP GOLD PROSPECT</b>		
<b>TITLE:</b> <div style="text-align: center; font-size: 1.5em;"><b>CLAIM SKETCH</b></div>		
Fig. 3		
<b>Date: March 1995</b>	<b>Scale: 1:20,000</b>	<b>NTS:</b>
<b>Drawn: P.Gauthier</b>	<b>Interp: J.C. Grant</b>	<b>Job No. E-0</b>

### LINECUTTING PROGRAM

A detailed metric grid was first completed over the claim group. This cutting was done in two phases due to flooding conditions. The cutting commenced in June of 1994 and was completed in February 1995. In all, a total of 7.2 km of grid lines were established across the group. Refer to the grid map located in the back pocket of this report for the grid orientation.

### GEOPHYSICAL PROGRAM

This program was completed using the EDA OMNI IV System. Specifications for this system can be found as Appendix A of this report. The following parameters were kept constant throughout the survey.

Linespacing	-100 meter and 30 meter
Reading Interval	-12.5 meter
Duurnal Correction	-Base Station Recorder
Base Station Recording	-30 seconds
Unit accuracy	- +/- 0.5 gammas
Reference Field	-58,220 gammas
Datum Substraction	-57,500 gammas

The collected data was then corrected and after having a base level of 57,500 gammas removed from it, was then plotted onto a base map at a scale of 1:5000. The data was then contoured at 10 gamma intervals wherever possible.

This contour map is included in the back of this report.

### SURVEY RESULTS

The magnetic survey was successful in locating and outlining 2 north-south striking features as well as an area of activity generally situated over the southwest and central section of claim P-118969. I suspect this magnetic activity relates to an intrusive. The west portion of claim P-1189770 appears to relate to felsic metavolcanics with the contact generally striking north-northeast across lines 0 to 300MN.

The north-south structure crossing lines 0+00 to 395MN to 2000ME, and continuing north off of the grid probably relates to a diabase dike which has been well documented on Map 2330, Turnbull and Godfrey Townships, scale 1 inch to 1/2 mile.

The most interesting structure on the group can be traced from L320MS to 395MN between 25ME and 125MW and continues off of the grid to the north. The magnetic signature is generally 350 to 500 gammas above the general background values. The magnetic lows flanking this structure to the west and east represent dipole effects related to the magnetic high unit.

This structure may relate to a sulphide rich fault zone which parallels the diabase dike. It may relate to a fault controlled diabase dike parallelling the known dike to the east.

The Mathieus have prospected the area and have found massive sulphide samples which have run in silver and gold.

Numberous outcrops in the vicinity of this structure have been mapped as intermediate to mafic intrusives which have been cross cut by east-west mafic metavolcanics.


#### CONCLUSIONS AND RECOMMENDATIONS

The magnetic high unit situated between 25ME and 125MW crosscutting lines 320MS to 395MN should be followed up further either by prospecting, trenching or a detailed HLEM survey. The HLEM survey would trace the sulphides contained within the unit and test their continuity as well as depth and conductivity.

Past prospecting by the property holders has proven the sulphides within the unit have returned anomalous gold and silver assays. This structure, if ground conditions allow, should be mechanically stripped and trenched to expose fresh samples for follow up assaying and possibly diamond drilling.

Respectfully Submitted,

John C. Grant, CET, FGAC

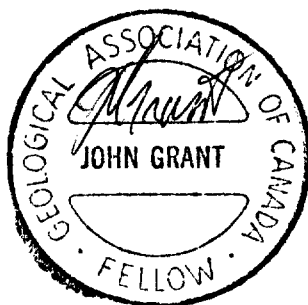





CERTIFICATE

I, John C. Grant, hereby certify that:

- 1) I am a graduate geophysicist (1975) of the three year program in Geological Technology at Cambrian College of Applied Arts and Technology, Sudbury, Campus. I have worked subsequently as an Exploration Geophysicist for Teck Exploration Limited (5 years), North Bay office, and as Exploration Manager and Geophysicist for Exsics Exploration Limited from 1980 to present.
- 2) I am a Member of the Certified Engineering Technologist Association since 1984.
- 3) I am a member of the Geological Association of Canada.
- 4) I have been actively engaged in my profession for the last twenty (20) years, including all aspects of exploration studies, surveys and interpretations.
- 5) I have no specific or special interest in the described property. I have been retained as a Consulting Geophysicist for property appraisal.

John Charles Grant, CET, FGAC

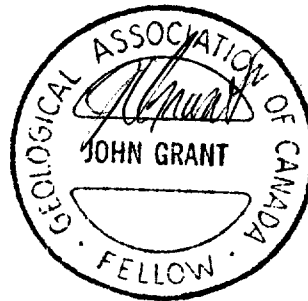

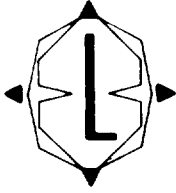

**EXSICS EXPLORATION LIMITED**  
CONTRACTING & CONSULTING GEOPHYSICS

Tel. (705) 267-4151  
Fax (705) 264-5790

P.O. Box 1880  
Timmins, Ontario P4N 7X1

INVOICE #: 289  
PROJECT #: E-0

ON ACCOUNT WITH: Richard and Robin Mathieu  
Timmins, Ontario

G.S.T. REGISTRATION # 113433791

RE: equipment rental, plotting & computer compilation,  
interpretation and reports

AT A RATE OF:

1.5 days compilation @ \$150.00/day	\$ 225.00
1 day report and interpretation	\$ 700.00
8 days equipment rental 3 mag units @ \$35/day/unit	\$ 840.00
	<u>\$1,765.00</u>
7% GST	\$ 123.55
	<u>\$1,888.55</u>
Typing & reproductions flat rate	\$ 100.00
	<u>\$ 100.00</u>
TOTAL OF THIS INVOICE:	<u><u>\$1,988.55</u></u>

DATE: March 13, 1995

SIGNED

**PAID IN FULL**

**PAYMENT DUE UPON RECEIPT OF INVOICE.**  
**TERMS: NET 30, 2% INTEREST PER MONTH ON OVERDUE ACCOUNTS.**

APPENDIX A



## Specifications

Dynamic Range	18,000 to 110,000 gammas. Roll-over display feature suppresses first significant digit upon exceeding 100,000 gammas.
Tuning Method	Tuning value is calculated accurately utilizing a specially developed tuning algorithm
Automatic Fine Tuning	$\pm 15\%$ relative to ambient field strength of last stored value
Display Resolution	0.1 gamma
Processing Sensitivity	$\pm 0.02$ gamma
Statistical Error Resolution	0.01 gamma
Absolute Accuracy	$\pm 1$ gamma at 50,000 gammas at 23°C $\pm 2$ gamma over total temperature range
Standard Memory Capacity	
Total Field or Gradient	1,200 data blocks or sets of readings
Tie-Line Points	100 data blocks or sets of readings
Base Station	5,000 data blocks or sets of readings
Display	Custom-designed, ruggedized liquid crystal display with an operating temperature range from $-40^{\circ}\text{C}$ to $+55^{\circ}\text{C}$ . The display contains six numeric digits, decimal point, battery status monitor, signal decay rate and signal amplitude monitor and function descriptors.
RS 232 Serial I/O Interface	2400 baud, 8 data bits, 2 stop bits, no parity
Gradient Tolerance	6,000 gammas per meter (field proven)
Test Mode	A. Diagnostic testing (data and programmable memory) B. Self Test (hardware)
Sensor	Optimized miniature design. Magnetic cleanliness is consistent with the specified absolute accuracy.
Gradient Sensors	0.5 meter sensor separation (standard), normalized to gammas/meter. Optional 1.0 meter sensor separation available. Horizontal sensors optional.
Sensor Cable	Remains flexible in temperature range specified, includes strain-relief connector
Cycling Time (Base Station Mode)	Programmable from 5 seconds up to 60 minutes in 1 second increments
Operating Environmental Range	$-40^{\circ}\text{C}$ to $+55^{\circ}\text{C}$ ; 0–100% relative humidity; weatherproof
Power Supply	Non-magnetic rechargeable sealed lead-acid battery cartridge or belt; rechargeable NiCad or Disposable battery cartridge or belt; or 12V DC power source option for base station operation.
Battery Cartridge/Belt Life	2,000 to 5,000 readings, for sealed lead acid power supply, depending upon ambient temperature and rate of readings
Weights and Dimensions	
Instrument Console Only	2.8 kg, 238 x 150 x 250mm
NiCad or Alkaline Battery Cartridge	1.2 kg, 235 x 105 x 90mm
NiCad or Alkaline Battery Belt	1.2 kg, 540 x 100 x 40mm
Lead-Acid Battery Cartridge	1.8 kg, 235 x 105 x 90mm
Lead-Acid Battery Belt	1.8 kg, 540 x 100 x 40mm
Sensor	1.2 kg, 56mm diameter x 200mm
Gradient Sensor (0.5 m separation - standard)	2.1 kg, 56mm diameter x 790mm
Gradient Sensor (1.0 m separation - optional)	2.2 kg, 56mm diameter x 1300mm
Standard System Complement	Instrument console; sensor; 3-meter cable, aluminum sectional sensor staff, power supply, harness assembly, operations manual.
Base Station Option	Standard system plus 30 meter cable
Gradiometer Option	Standard system plus 0.5 meter sensor

EDA Instruments Inc.  
4 Thorncliffe Park Drive  
Toronto, Ontario  
Canada M4H 1H1  
Telex: 06 23222 EDA TOR  
Cable: Instruments Toronto  
(416) 425 7800


In U.S.A.  
EDA Instruments Inc.  
5151 Ward Road  
Wheat Ridge, Colorado  
U.S.A. 80053  
(303) 422 9112

Printed in Canada

# OMNI IV "Tie-Line" Magnetometer





- Four Magnetometers in One
- Self Correcting for Diurnal Variations
- Reduced Instrumentation Requirements
- 25% Weight Reduction
- User Friendly Keypad Operation
- Universal Computer Interface
- Comprehensive Software Packages

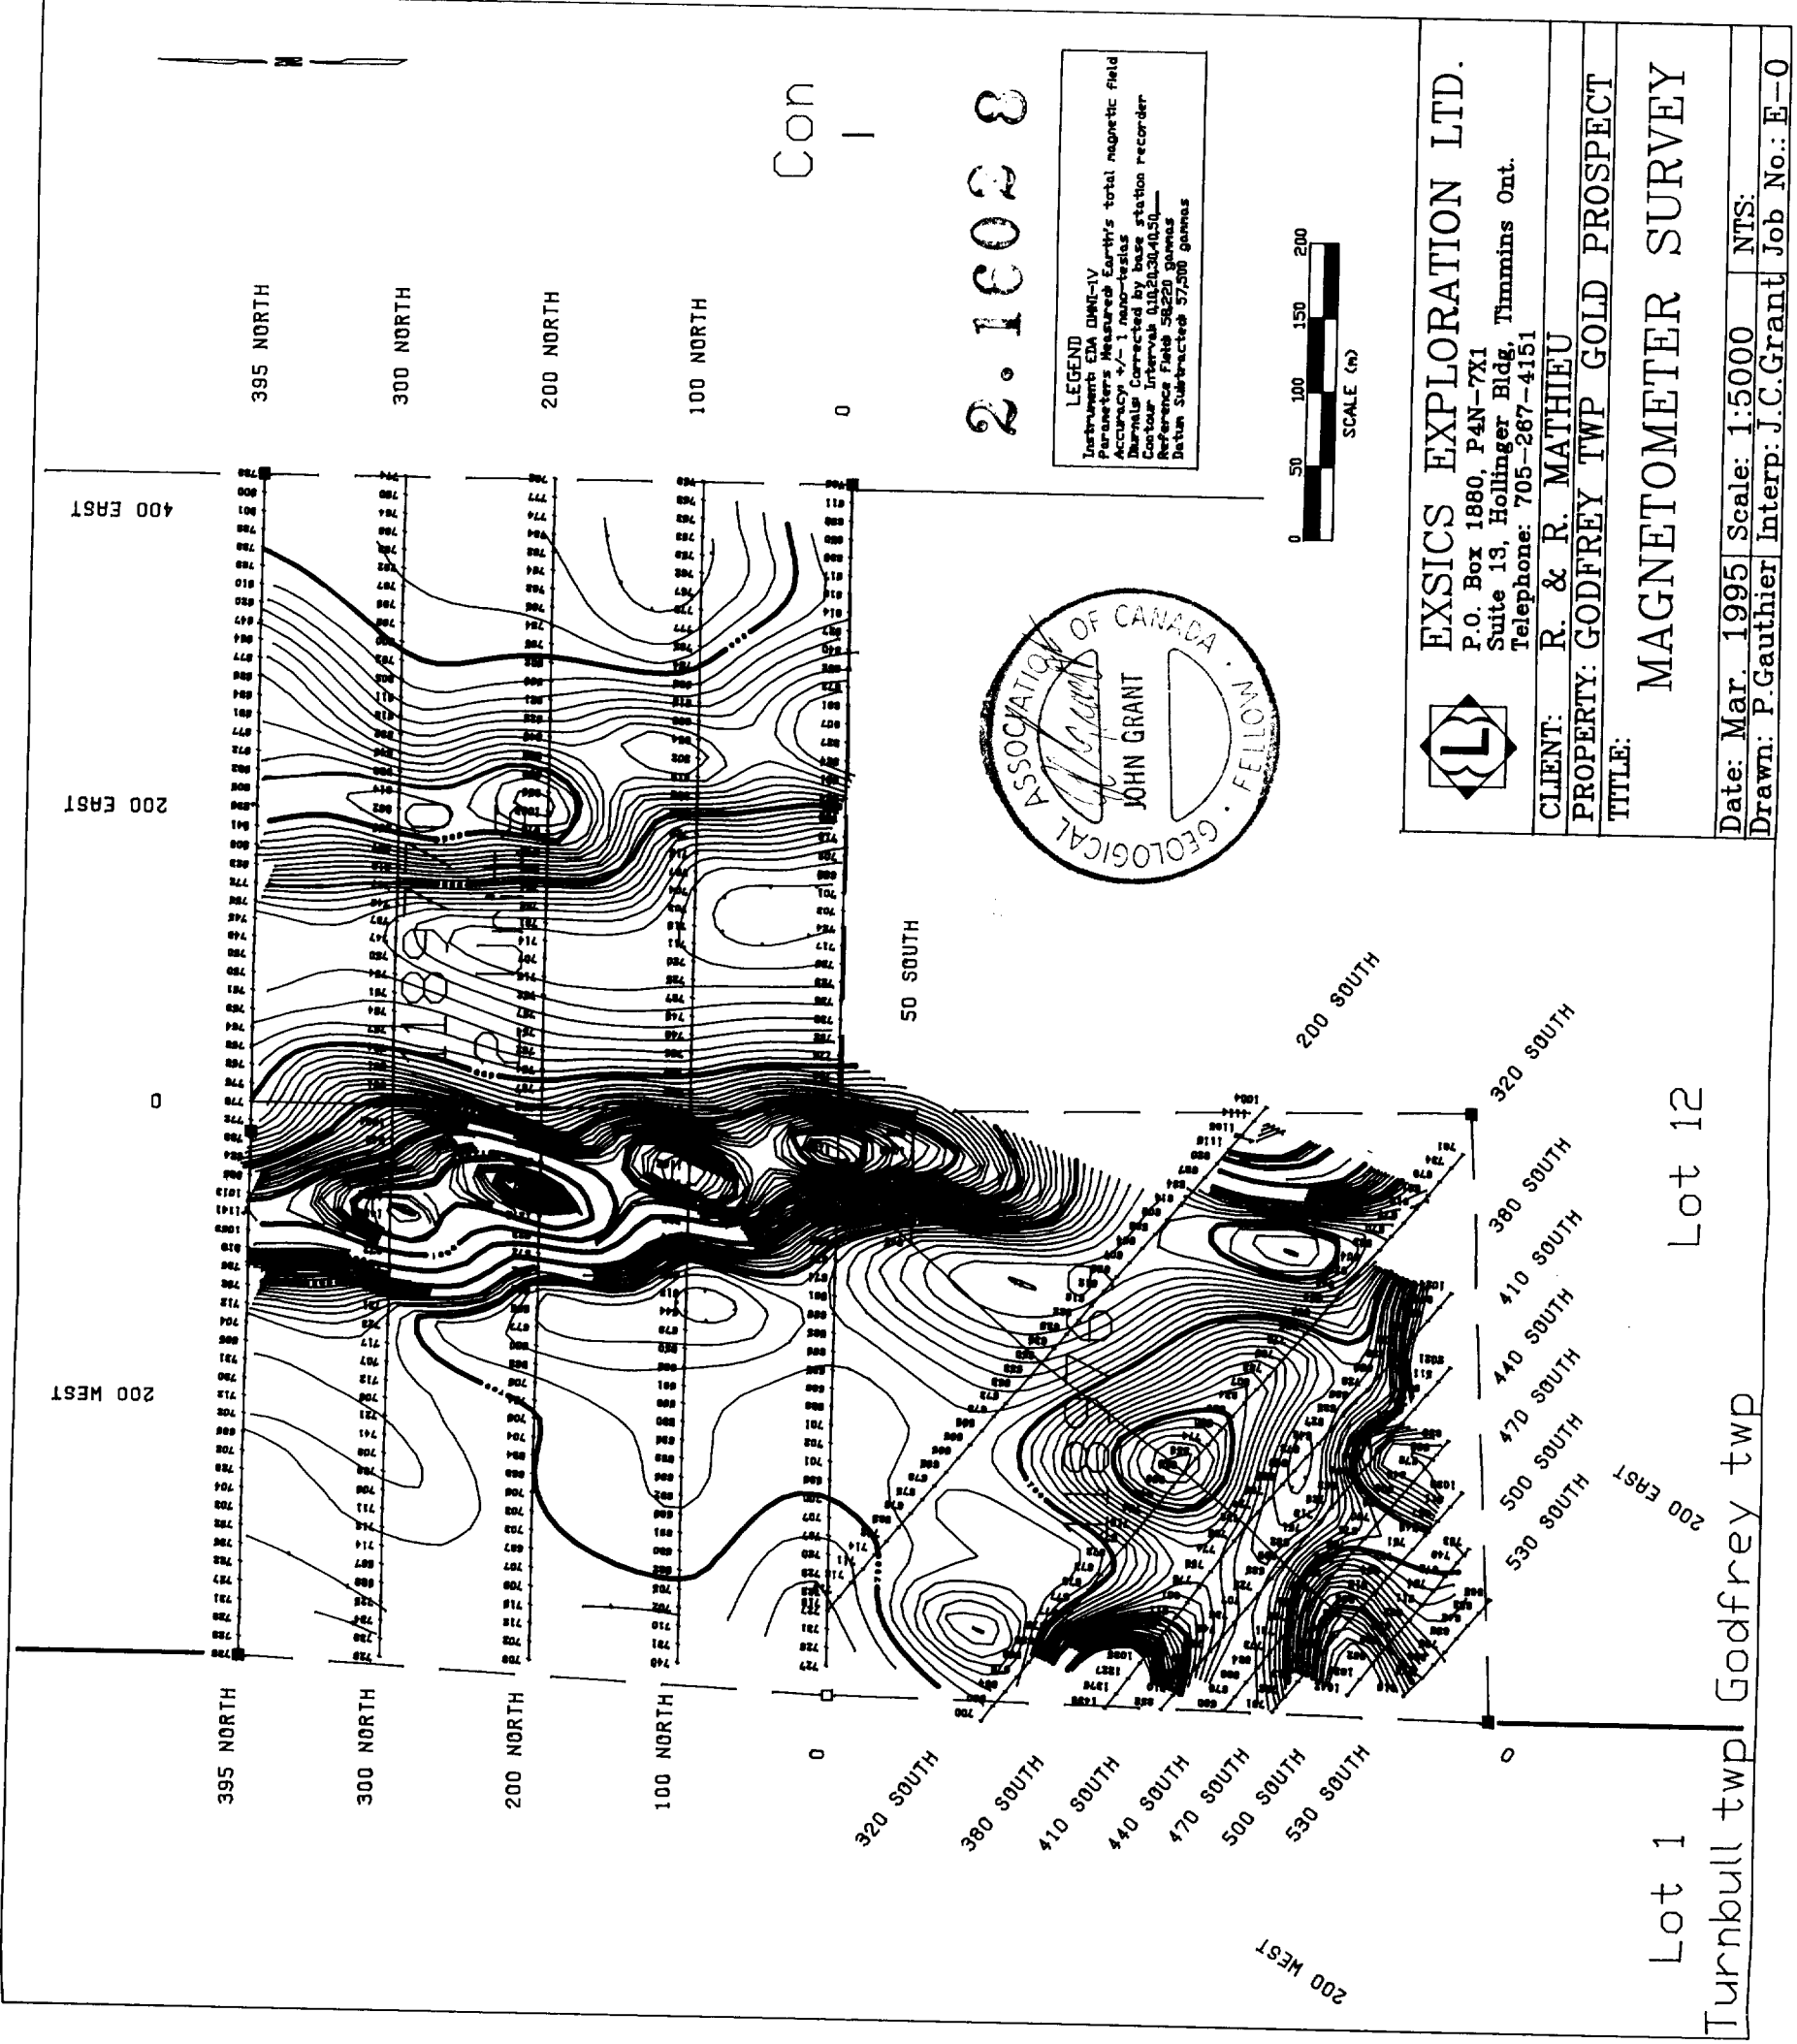

2.16028

LEGEND  
 Instrument: GSA DM61-IV  
 Parameters: Earth's total magnetic field  
 Accuracy: +/- 1 gamma  
 Duration: Corrected by base station recorder  
 Contour Interval: 0.10, 0.20, 0.50  
 Reference Field: 58,220 gamma  
 Datum: Subtracting 57,500 gamma

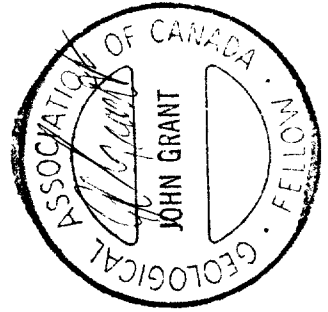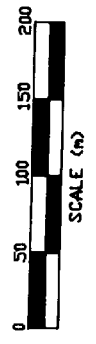

**EXSICS EXPLORATION LTD.**  
 P.O. Box 1880, PAN-7X1  
 Suite 13, Hollinger Bldg, Timmins Ont.  
 Telephone: 705-267-4151

**CLIENT: R. & R. MATHIEU**  
**PROPERTY: GODFREY TWP GOLD PROSPECT**  
**TITLE: MAGNETOMETER SURVEY**

Date: Mar. 1995 Scale: 1:5000 NTS:  
 Drawn: P.Gauthier Interp: J.C.Grant Job No.: E-0

Lot 1  
 Lot 12  
 Turnbull twp Godfrey twp  
 200 EAST

# Report of Work Conducted After Recording Claim

Mining Act

Transaction Number  
**W 9560.00139**

Personal information collected on this form is obtained under the authority of the Mining Act. This information will be used for correspondence. Questions about this collection should be directed to the Provincial Manager, Mining Lands, Ministry of Northern Development and Mines, Fourth Floor, 159 Cedar Street, Sudbury, Ontario, P3E 6A5, telephone (705) 670-7264.

**2.16028**


- Instructions:**
- Please type or print and submit in duplicate
  - Refer to the Mining Act and Regulations for Recorder.
  - A separate copy of this form must be completed
  - Technical reports and maps must accompany
  - A sketch, showing the claims the work is at



900

Recorded Holder(s) <b>RICHARD MATHIEU 5070 ROSEBUD MATHIEU 5070.</b>	Client No.
Address <b>47 PINE ST. NORTH PARA. TIMMINS, ONT.</b>	Telephone No. <b>764-7793.</b>
Mining Division <b>PORCUPINE</b>	M or G Plan No. <b>G-399</b>
Township/Area <b>GODFREY TWP.</b>	
Work Group <b>From: JUNE 16 /94.</b>	To: <b>FEB 25 /95</b>

Work Group	Type
Geotechnical Survey	<b>LINECUTTING AND TOTAL FIELD MAGNETIC</b> <span style="float: right;">TOTAL DAYS 16 BY HOLDERS</span>
Physical Work, including Drilling	
Rehabilitation	
Other Authorized Work	<b>Plotting, INTERPRETATION &amp; REPORTS.</b>
Days	
Assignment from	
Service	

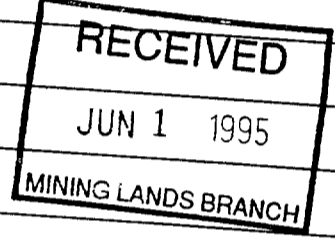

Assessment Work Claimed on the Attached Statement of Costs \$ **6798.00.**

The Minister may reject for assessment work credit all or part of the assessment work submitted if the recorded holder cannot verify expenditures claimed in the statement of costs within 30 days of a request for verification.

**Author and Survey Company Who Performed the Work (Give Name and Address of Author of Report)**

Name	Address
<b>ARRA MATHIEU</b>	<b>PINE ST. N. TIMMINS, ONT.</b>
<b>R.S. MATHIEU.</b>	<b>MAPLE ST. N. TIMMINS, ONT.</b>

**Schedule (if necessary)**

**Statement of Beneficial Interest \* See Note No. 1 on reverse side**

At the time the work was performed, the claims covered in this work recorded in the current holder's name or held under a beneficial interest

Date	Recorded Holder or Agent (Signature)
<b>March 15/95</b>	<i>[Signature]</i>

**Statement of Work Report**

I have a personal knowledge of the facts set forth in this Work report, having performed the work or witnessed same during and/or after the work and annexed report is true.

Signature of Person Certifying: **DAVID C. GRANT**

Date: **1/5/95**

Address: **Box 1880 TIMMINS, ONT P4N 7X1**

Certified By (Signature): *[Signature]*

**Deemed Approval Date**

**5. JUNE 19, 1995**

Date Notice for Amendments Sent

Mining Recorder: **Gary White**

Date Approved: **NOT DATED**

RECEIVED stamp: **MAR 21 2:15 PM PORCUPINE MINING**







Statement of Costs for Assessment Credit

Transaction No./N° de transaction  
**W9560.00139**

État des coûts aux fins du crédit d'évaluation

Mining Act/Loi sur les mines

Personal information collected on this form is obtained under the authority of the Mining Act. This information will be used to maintain a record and ongoing status of the mining claim(s). Questions about this collection should be directed to the Provincial Manager, Minings Lands, Ministry of Northern Development and Mines, 4th Floor, 159 Cedar Street, Sudbury, Ontario L6E 6A5, telephone (705) 670-7264.

Les renseignements personnels contenus dans la présente formule sont recueillis en vertu de la Loi sur les mines et serviront à tenir à jour un registre des concessions minières. Adresser toute question sur la collecte de ces renseignements au chef provincial des terrains miniers, ministère du Développement du Nord et des Mines, 159, rue Cedar, 4<sup>e</sup> étage, Sudbury (Ontario) P3E 6A5, téléphone (705) 670-7264.

Direct Costs/Coûts directs

Type	Description	Amount Montant	Totals Total global
Other charges Autres charges	Labour 16 days x 2 Main-d'oeuvre Field Supervision Supervision sur le terrain	1500/16/2 4800.00	
Contractor's and Consultant's fees Frais de l'entrepreneur et de l'expert-consultant	CONSTR. REPORT PROVING & COMPIC TYPING, INCL GST	700 225 71.75	1096.75
Supplies Used Fournitures utilisées	Type		
Equipment Rental Location de matériel	Type BOMBIYANIS@ 35/day/incl GST	898.80	898.80
<b>Total Direct Costs Total des coûts directs</b>			<b>6795.00</b>

2. Indirect Costs/Coûts indirects

\*\* Note: When claiming Rehabilitation work indirect costs are not allowable as assessment work.  
Pour le remboursement des travaux de réhabilitation, les coûts indirects ne sont pas admissibles en tant que travaux d'évaluation.

Type	Description	Amount Montant	Totals Total global
Transportation Transport	Type		
Food and Lodging Nourriture et hébergement			
Mobilization and Demobilization Mobilisation et démoblisation			
<b>Sub Total of Indirect Costs Total partiel des coûts indirects</b>			
<b>Amount Allowable (not greater than 20% of Direct Costs) Montant admissible (n'excédant pas 20 % des coûts directs)</b>			
<b>Total Value of Assessment Credit (Total of Direct and Allowable indirect costs)</b>			<b>Valeur totale du crédit d'évaluation (Total des coûts directs et indirects admissibles)</b>

The recorded holder will be required to verify expenditures claimed in this statement of costs within 30 days of a request for verification. If verification is not made, the Minister may reject for assessment work all or part of the assessment work submitted.

Note : Le titulaire enregistré sera tenu de vérifier les dépenses demandées dans le présent état des coûts dans les 30 jours suivant une demande à cet effet. Si la vérification n'est pas effectuée, le ministre peut rejeter tout ou une partie des travaux d'évaluation présentés.

Working Discounts

Work filed within two years of completion is claimed at 100% of the above Total Value of Assessment Credit.

Work filed three, four or five years after completion is claimed at 50% of the above Total Value of Assessment Credit. See calculations below:

Value of Assessment Credit	Total Assessment Claimed
	x 0.50 =

Remises pour dépôt

- Les travaux déposés dans les deux ans suivant leur achèvement sont remboursés à 100 % de la valeur totale susmentionnée du crédit d'évaluation.
- Les travaux déposés trois, quatre ou cinq ans après leur achèvement sont remboursés à 50 % de la valeur totale du crédit d'évaluation susmentionné. Voir les calculs ci-dessous.

Valeur totale du crédit d'évaluation	Évaluation totale demandée
	x 0,50 =

Attestation Verifying Statement of Costs

I hereby certify: The amounts shown are as accurate as possible and these costs were incurred while conducting assessment work on the lands shown on the accompanying Report of Work form.

As Agent I am authorized

to make this certification

Attestation de l'état des coûts

J'atteste par la présente : que les montants indiqués sont le plus exact possible et que ces dépenses ont été engagées pour effectuer les travaux d'évaluation sur les terrains indiqués dans la formule de rapport de travail ci-joint.

Et qu'à titre de titulaire enregistré, représentant, poste occupé dans la compagnie je suis autorisé

à faire cette attestation.

Signature [Signature] Date Mar 15/95

Ministry of  
Northern Development  
and Mines

Ministère du  
Développement du Nord  
et des Mines

Geoscience Approvals Office  
933 Ramsey Lake Rd., 6th Flr  
Sudbury, Ontario  
P3E 6B5

Telephone: (705) 670-5841  
Fax: (705) 670-5863

August 4, 1995

Our File: 2.16028  
Transaction #:W9560.00139

Mining Recorder  
Ministry of Northern Development & Mines  
60 Wilson Avenue  
1st Floor  
Timmins, Ontario  
P4N 2S7


Dear Mr. White:

**RE: Approval of Notice of Reduction issued for assessment work reported on mining claims 1189769 & 1189770 in Godfrey Township.**

The assessment work credits as outlined in the notice of reduction dated June 08, 1995 **have been approved as of July 24, 1995.** The credits have been approved under Section 14 (Geophysics) of the Mining Act Regulations.

If you require additional assistance in this matter please contact Steven Beneteau at (705) 670-5858.

Yours sincerely,

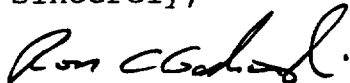

Ron C. Gashinski  
Senior Manager, Mining Lands Section  
Mining and Land Management Branch  
Mines and Minerals Division

*SBB* SBB/yr  
Encl.

cc:Assessment Files Office  
Sudury, Ontario

Resident Geologist  
Timmins, Ontario

VALUE OF ASSESSMENT WORK PERFORMED ON MINING CLAIMS

July 25, 1995

FILE NUMBER 2.16028

TRANSACTION NO. W9560.00139

CLAIM NUMBER	VALUE OF ASSESSMENT WORK DONE ON THIS CLAIM
1189769	\$1,710.00
1189770	\$3,418.00
	-----
TOTAL	\$5,128.00

MAP SYMBOLOGY

Aerial Cablesway	Pipeline (above ground)
Boundary (various)	Railroad
Disturbance (various)	Single Track
Disturbance (various)	Double Track
Disturbance (various)	Road
Disturbance (various)	Highway County
Disturbance (various)	Highway
Disturbance (various)	Access Road of Unimproved
Disturbance (various)	Trail, Back Road (various)
Disturbance (various)	Rapids
Disturbance (various)	Reservoir
Disturbance (various)	River, Stream, Canal
Disturbance (various)	Approximate
Disturbance (various)	Horizontal
Disturbance (various)	Vertical
Disturbance (various)	Rock
Disturbance (various)	Spot Elevation (various)
Disturbance (various)	Tower
Disturbance (various)	Transmission Line
Disturbance (various)	Pole
Disturbance (various)	Tunnel
Disturbance (various)	Fence, Hedge, Wall
Disturbance (various)	Failure Outline
Disturbance (various)	Flooded Land
Disturbance (various)	Marsh or Swamp
Disturbance (various)	Moat
Disturbance (various)	Mine Head Frame
Disturbance (various)	Outcrop


AREAS WITHDRAWN FROM DISPOSITION

- M.R.O. - MINING RIGHTS ONLY
  - S.R.O. - SURFACE RIGHTS ONLY
  - M+S - MINING AND SURFACE RIGHTS
- Description Order No. Date Disposition File
- (1) S.R.O. UNDER APPLICATION FOR AGRICULTURAL PURPOSES
  - (2) CERTIFIED AGRICULTURAL LAND ACT SUBJECT TO SEC 411 OF THE MINING ACT
  - (3) BONA FIDE APPLICATION
- Parting proceedings, land not open*  
*(1) full only, 1/25/20*

**MINING AND SURFACE RIGHTS REQUIRED FOR PROSPECTING, STAMPS OUT, SALE OR LEASE UNDER SECTION 25 OF THE MINING ACT 1963**  
EFFECTIVE FEB. 1, 1963, AT 7:00 AM, E.A.T.  
ORDER NO. G-1498 HER DATED JAN. 18/63.  
(10/2/63)

THE INFORMATION THAT APPEARS ON THIS MAP IS UNLAWFUL TO BE USED FOR ANY PURPOSE OTHER THAN THAT FOR WHICH IT WAS PREPARED AND FOR WHICH THE MINISTER OF MINES IS RESPONSIBLE.

JAMIESON TWP.

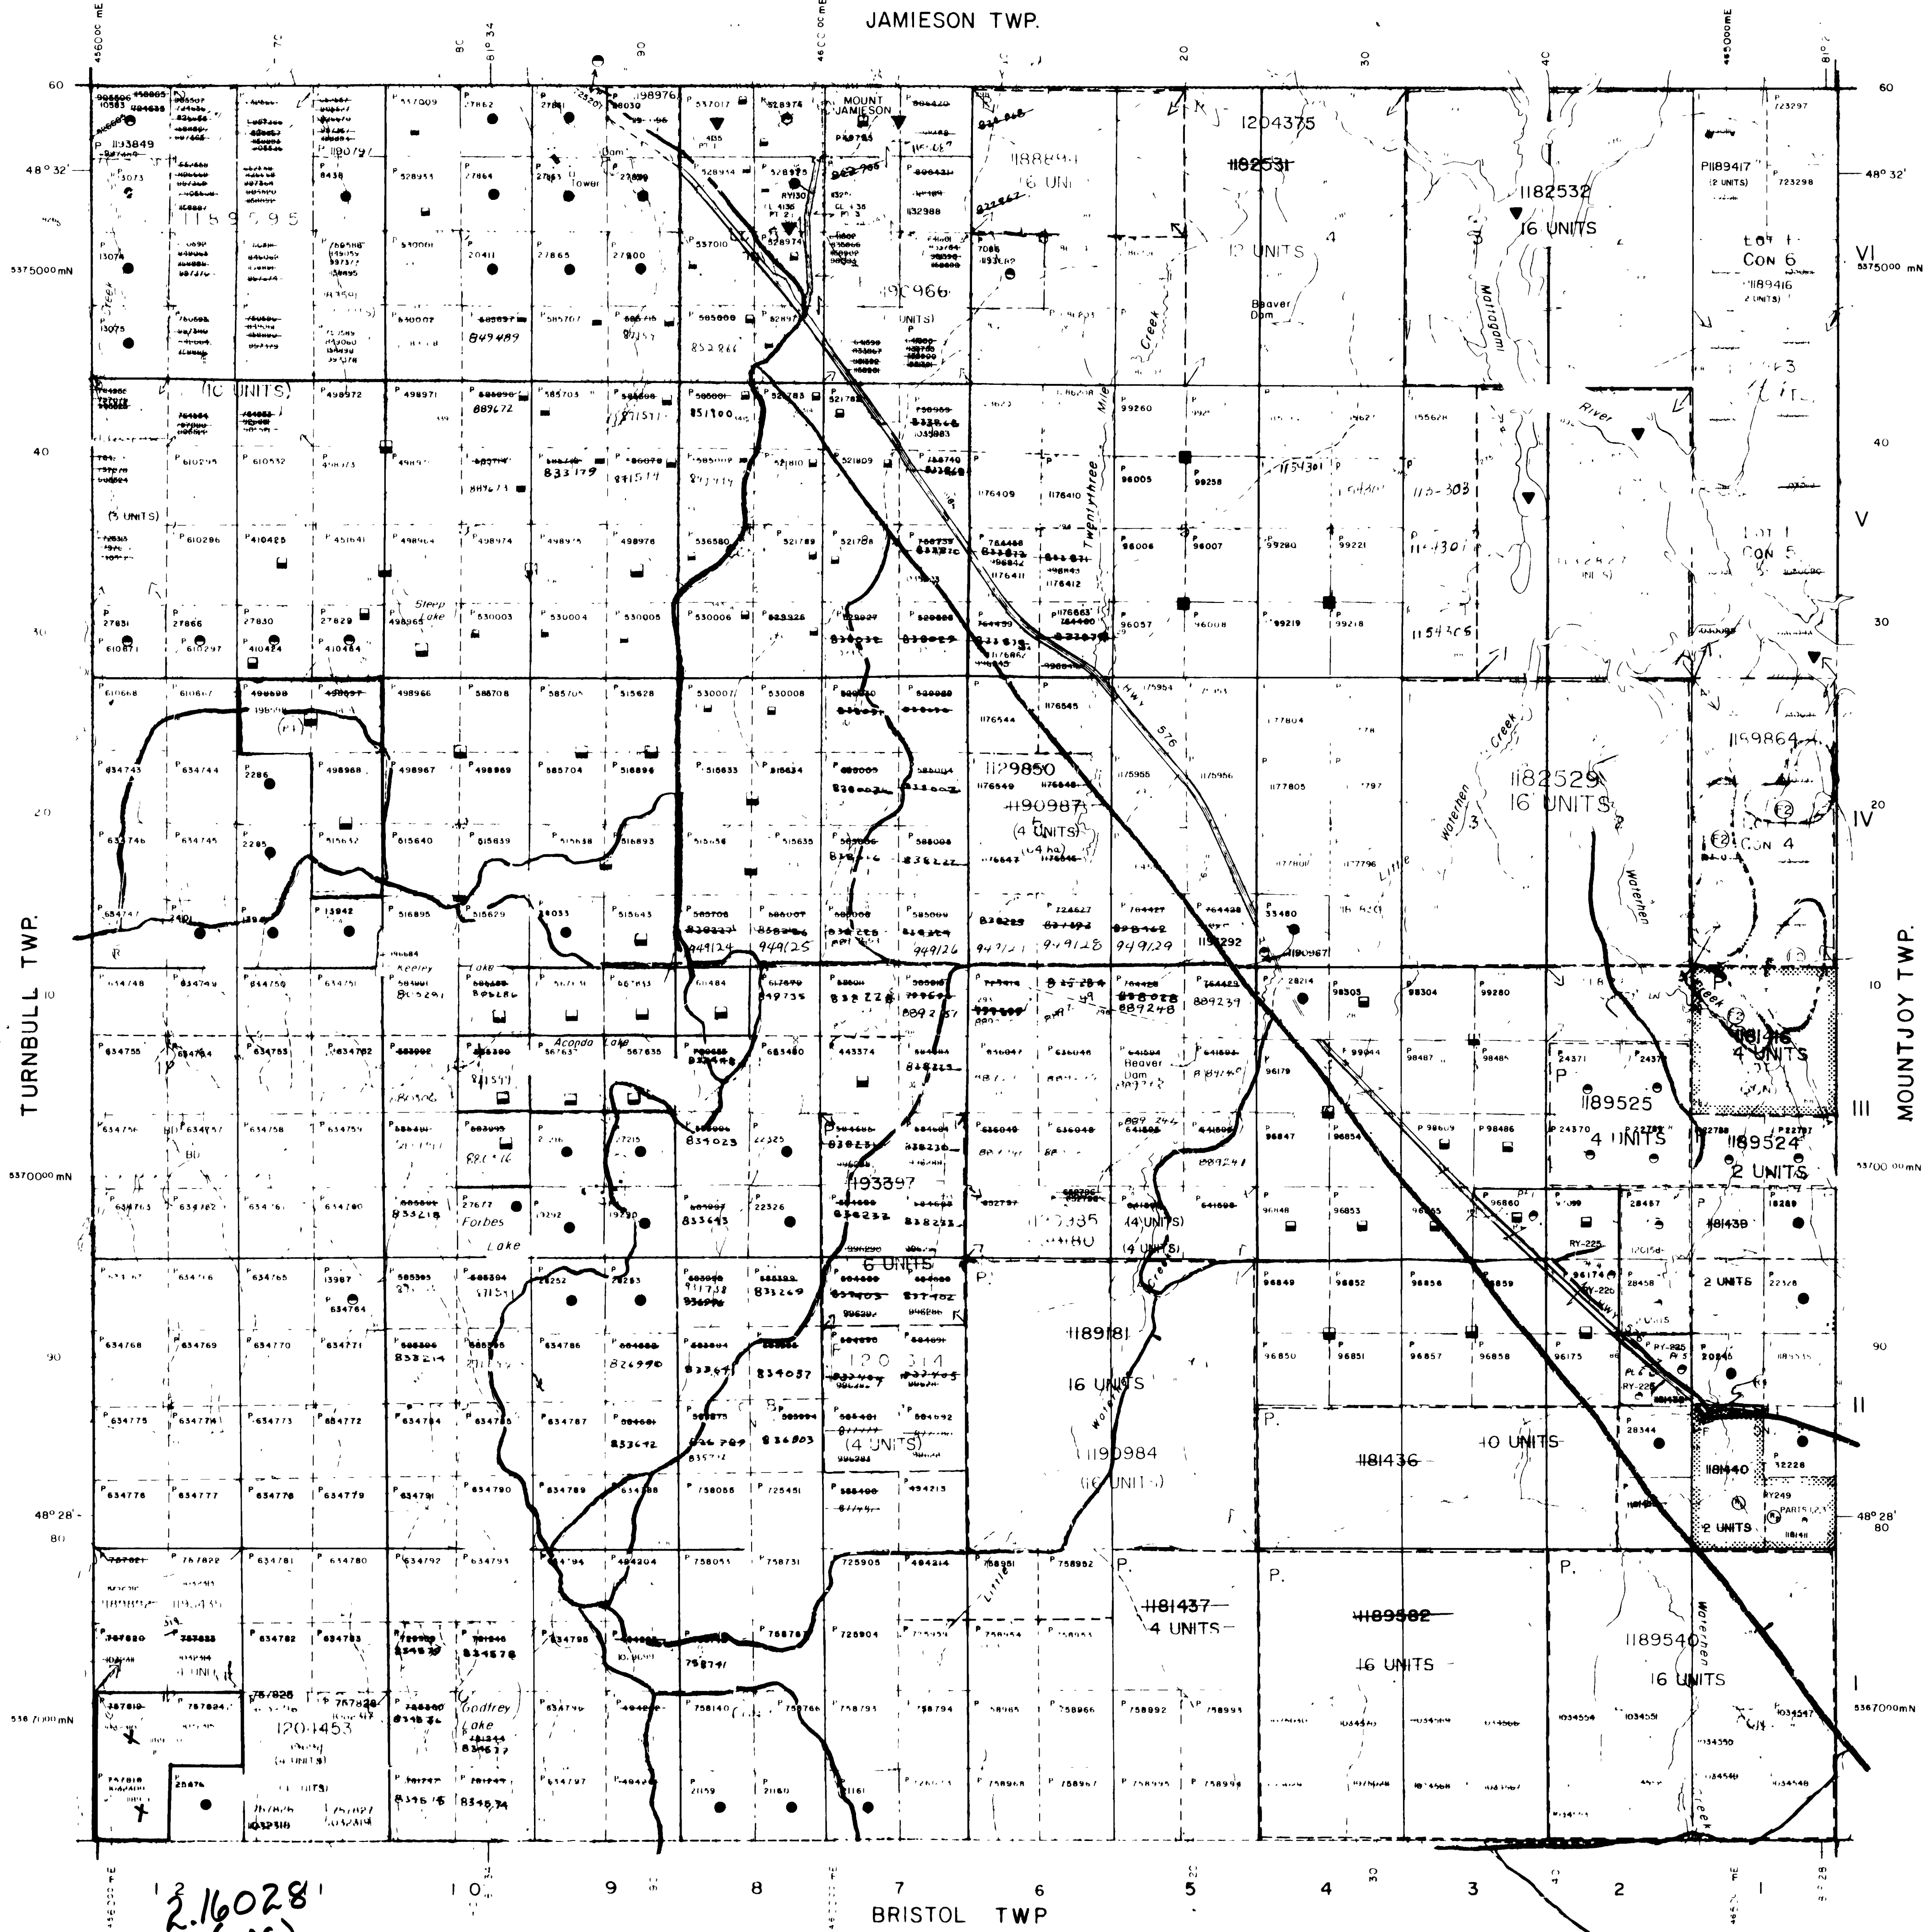


LEGEND

HIGHWAY AND ROUTE No.	
OTHER HIGHWAY	
RAILS	
UNIMPROVED CANALS ETC.	
UNIMPROVED LINES	
PARCEL BOUNDARY	
MINING CLAIMS ETC.	
RAILWAY AND RIGHT OF WAY	
UTILITY LINES	
NON PERENNIAL STREAM	
FLOODING OR FLOODING RIGHTS	
SUBDIVISION OR COMPOSITE PLAN	
RESERVATIONS	
ORIGINAL SHORELINE	
MARSH OR MUSKIG	
MINES	
TRAVERSE MONUMENT	

DISPOSITION OF CROWN LANDS

TYPE OF DOCUMENT	SYMBOL
PATENT SURFACE & MINING RIGHTS	
SURFACE RIGHTS ONLY	
MINING RIGHTS ONLY	
LEASE SURFACE & MINING RIGHTS	
SURFACE RIGHTS ONLY	
MINING RIGHTS ONLY	
LICENCE OF OCCUPATION	
ORDER IN COUNCIL	
RESERVATION	
CANCELLED	
SAND & GRAVEL	

NOTE: MINING RIGHTS IN PARCELS PATENTED PRIOR TO MAY 6 1913 VESTED IN ORIGINAL PATENTEE BY THE PUBLIC LANDS ACT R.S.O. 1970 CHAP. 380 SEC. 83 SUBSEC. 1

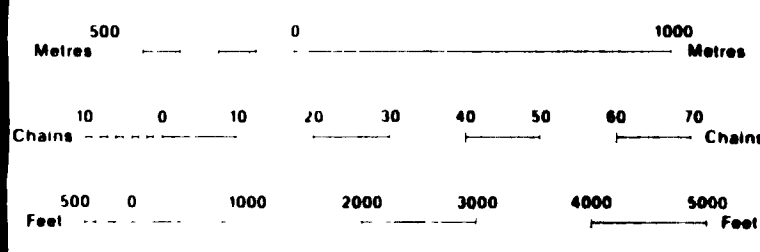


SCALE 1:20 000  
GRID ZONE 17

NOTES

- FLOODING RIGHTS IN EITHER SIDE OF THE MATTAGAMI RIVER TO THE PC.
- THIS TWP IS SUBJECT TO FOREST ACTIVITIES IN 1963/64. FURTHER INFORMATION ON FILE.
- THIS TWP IS SUBJECT TO FOREST ACTIVITY IN 1963/64. FURTHER INFORMATION ON FILE.

TOWNSHIP 2.1602 8  
**GODFREY**  
M.N.D. ADMINISTRATIVE DISTRICT  
TIMMINS  
MINING DIVISION  
PORCUPINE  
LAND TITLES / REGISTRY DIVISION  
COCHRANE

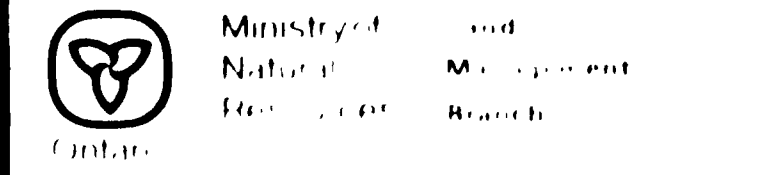

G-3991

