



42A05NE0094 2 16819 BRISTOL

010



GEOPHYSICAL REPORT
FOR
PROSPECTOR'S ALLIANCE INC.
ON THE
ALLERSTON OPTION
BRISTOL EAST PROPERTY
BRISTOL TOWNSHIP
PORCUPINE MINING DIVISION
NORTHEASTERN, ONTARIO

2.16819

Doc. # 2-34612

PREPARED BY: J.C. GRANT, CET, FGAC
AUGUST, 1996

DUPLICATE
[Signature]

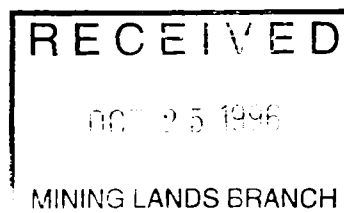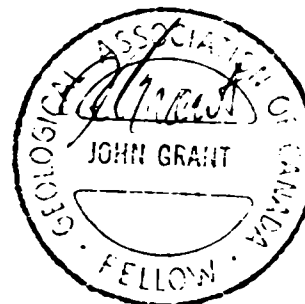



42A05NE0094 2 16819 BRISTOL

010C

TABLE OF CONTENTS

	PAGE
INTRODUCTION.....	1
PROPERTY LOCATION AND ACCESS.....	1
CLAIM GROUP.....	1
PERSONNEL.....	2
GROUND PROGRAM.....	2
SURVEY RESULTS.....	3
CONCLUSIONS AND RECOMMENDATIONS.....	3
CERTIFICATE	
APPENDIX: A. SCINTREX, MP-2 PROTOM MAGNETOMETER	
LIST OF FIGURES: FIGURE 1: LOCATION MAP	
FIGURE 2: PROPERTY LOCATION MAP	
FIGURE 3: CLAIM MAP	
POCKET MAPS: CONTOURED TOTAL FIELD MAGNETIC SURVEY	
SCALE 1:5000	

INTRODUCTION

The services of Exsics Exploration Limited were retained by Prospector's Alliance Inc. to complete a linecutting and geophysical program on a block of their claims located in the central west section of Bristol Township of the Porcupine Mining Division. Figure 1 and 2. The purpose of this program was to locate and outline geological formations which would be considered favourable areas for gold deposition.

The ground program began in the middle of July, 1996 and will continue until the end of the year.

This report will deal with the results of a total field magnetic survey which was completed on a portion of the main claim block. The linecutting and ground surveys will continue on the Prospector's Alliance holdings in this and surrounding townships.


PROPERTY LOCATION AND ACCESS

The claim group which will be discussed in this report is located in the west central section of Bristol Township, Porcupine Mining Division, District of Cochrane in northeastern Ontario. Figure 1 and 2. More specifically it is located north of Highway 101 just before the junction of Highway 144 and just to the south of McDonnell lake. Thunder Creek cuts across the western section of the claim group in roughly a north-south direction. Figure 3.

The access to the claim group during the survey period was ideal. Highway 101 west travels just to the south of the claim group and provides drivable access to within 1200 meters of the southeast corner of the block. an alternate route would be by truck along the Mallett main haulage road which travels northwest off of 101 and eventually follows the township line between Godfrey and Bristol. A good gravel road travels south off of this haulage road and provides access to the center of the north boundary of the claim group. The entire property can be reached by vehicle in about 30 minutes from Timmins.

CLAIM GROUP

The claim numbers which make up this portion of the Prospector's Alliance Inc.'s holdings in Bristol are shown on figure 3 of this report, Claim Sketch. The sketch was copied from MNDM Plan Map G-3998, Bristol Township, scale 1:20,000.

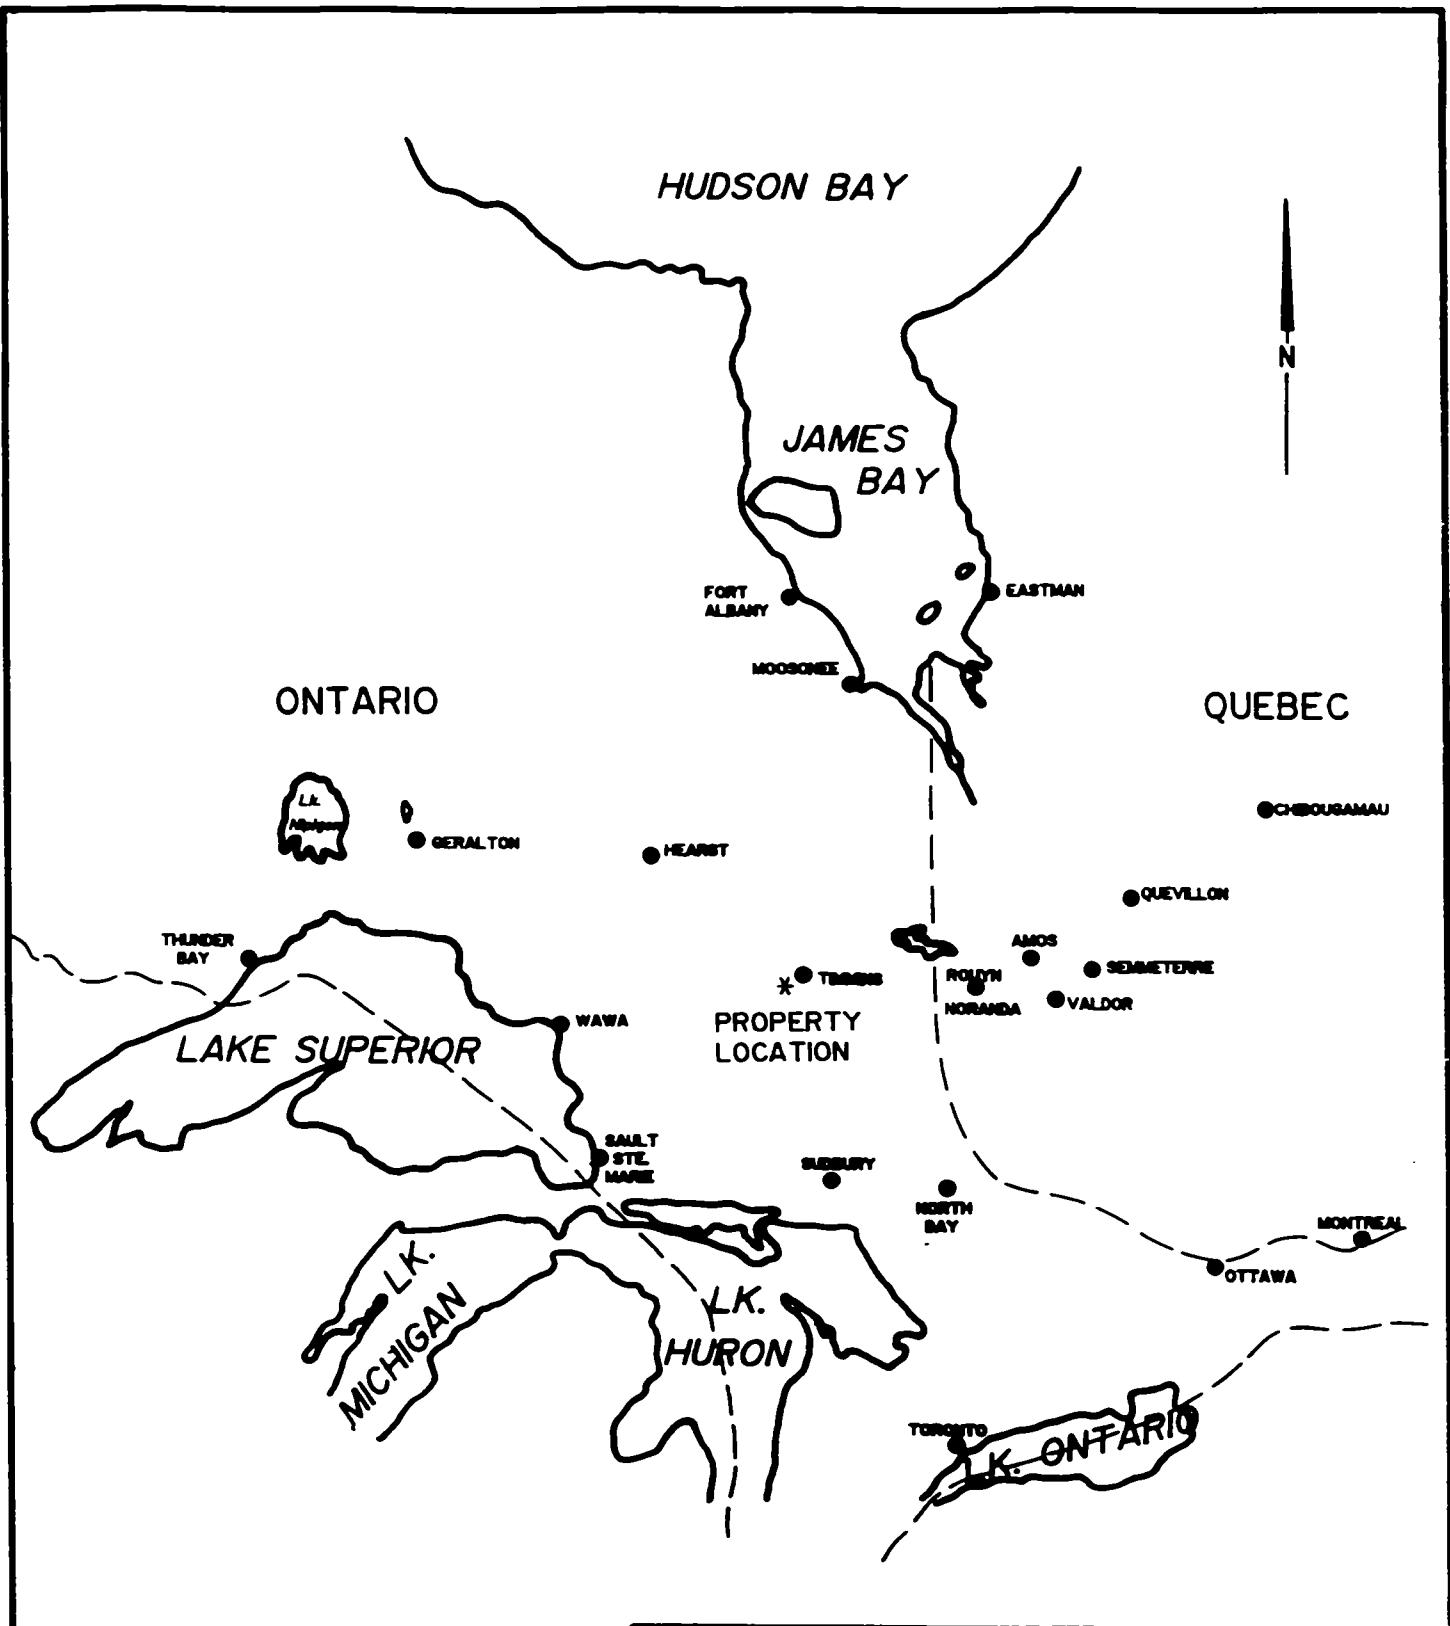

EXSICS EXPLORATION LTD.

P.O. Box 1000, P4B-7X1
 Suite 10, Millinger Bldg, Timmins Ont.
 Telephone: 705-267-4151

CLIENT: PROSPECTORS ALLIANCE INC.

PROPERTY: GRID EAST BRISTOL TWP.

TITLE:

LOCATION MAP

Fig. 1

Date: Aug. 1996


Scale: 1"=25miles

MNDM Plan#:

Drawn: P. Gauthier

Interp: J.C. Grant

Job No.: E-190

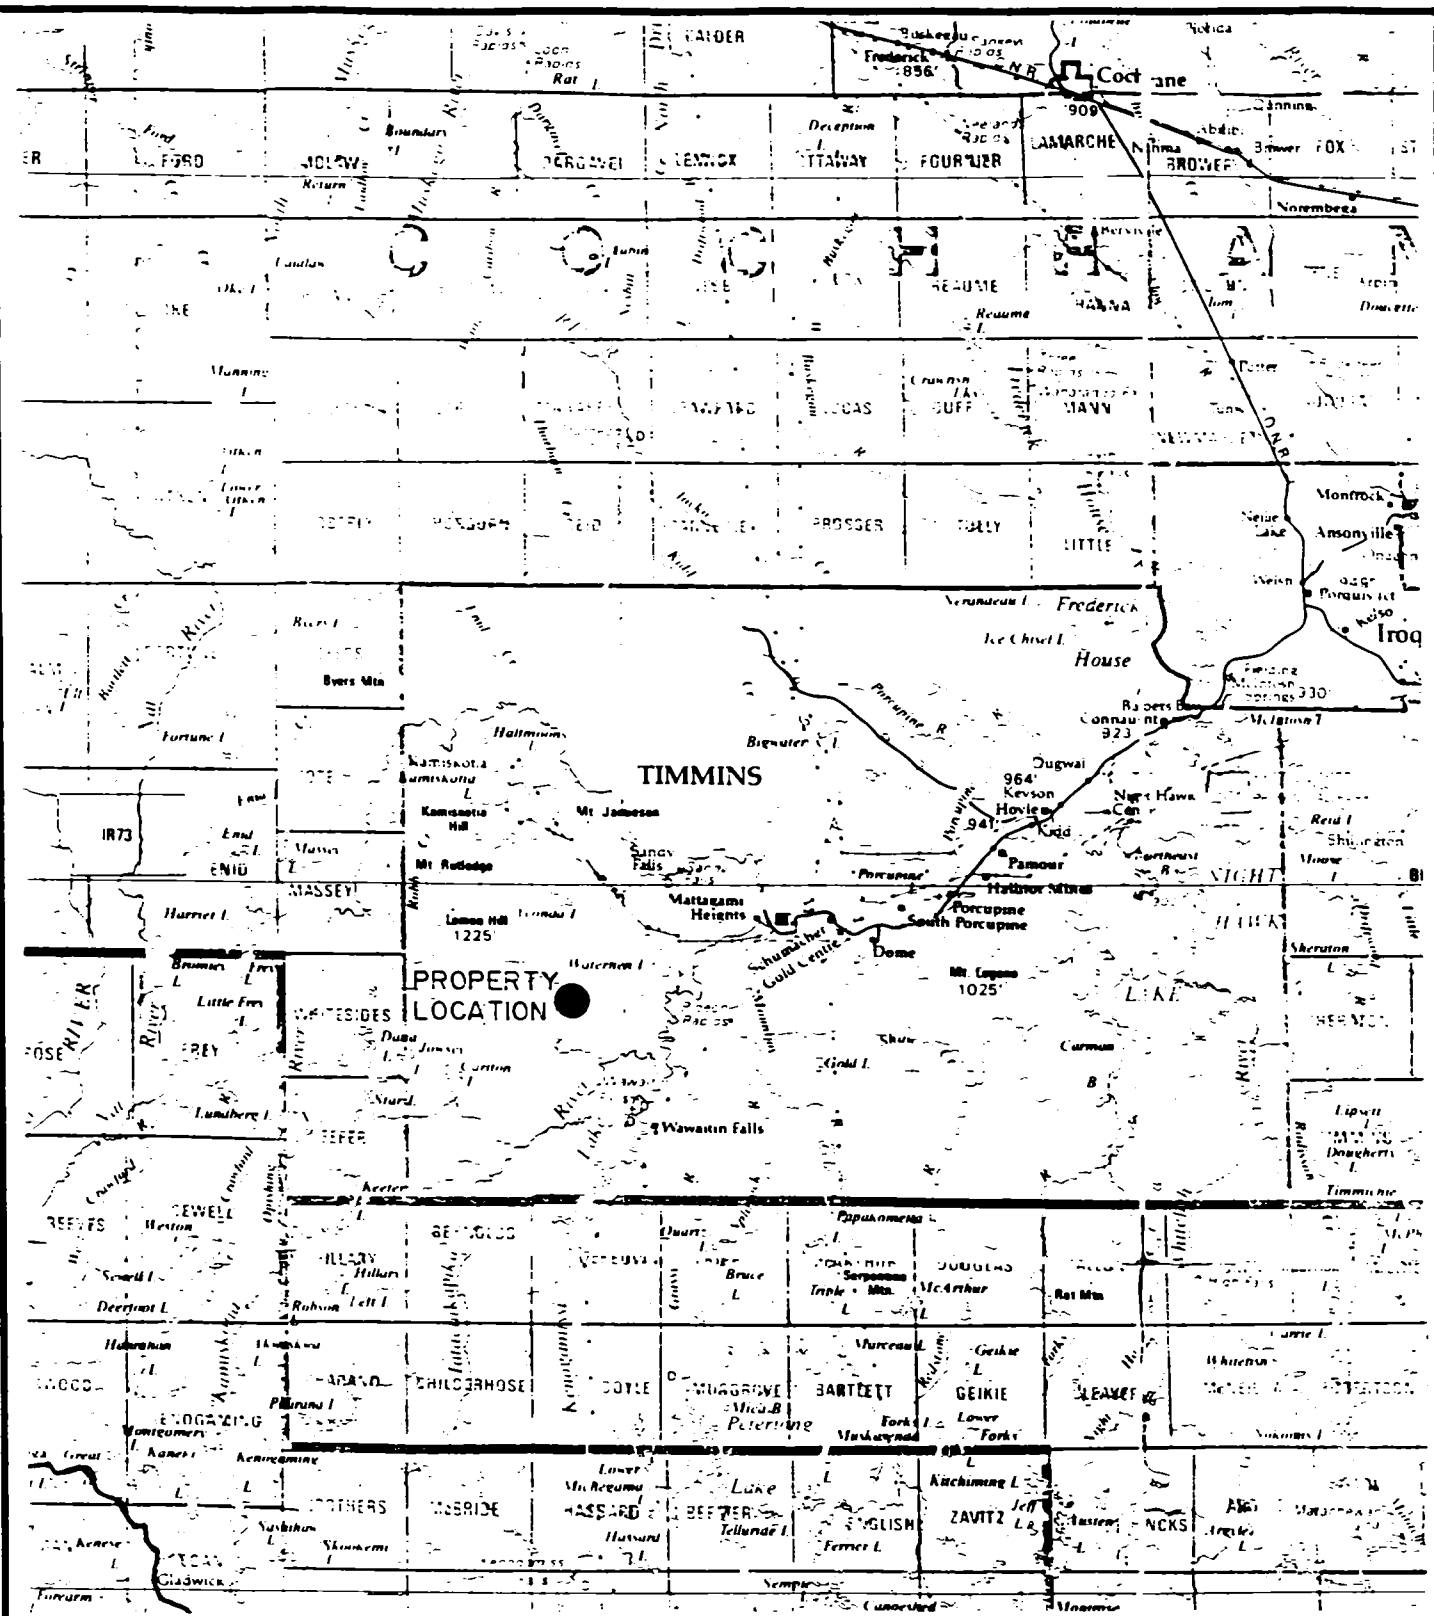

EXSICS EXPLORATION LTD.

P.O. Box 1000, P4B-7X1
 Suite 22, Hollinger Bldg, Timmins Ont.
 Telephone: 705-399-4151

CLIENT: PROSPECTORS ALLIANCE INC.

PROPERTY: GRID EAST BRISTOL TWP.

TITLE:

PROPERTY LOCATION

Fig. 2

Date: Aug. 1996


Scale: 1:600,000

MNDM Plan#: 22-6

Drawn:

Interp: J.C. Grant

Job No.: E-190

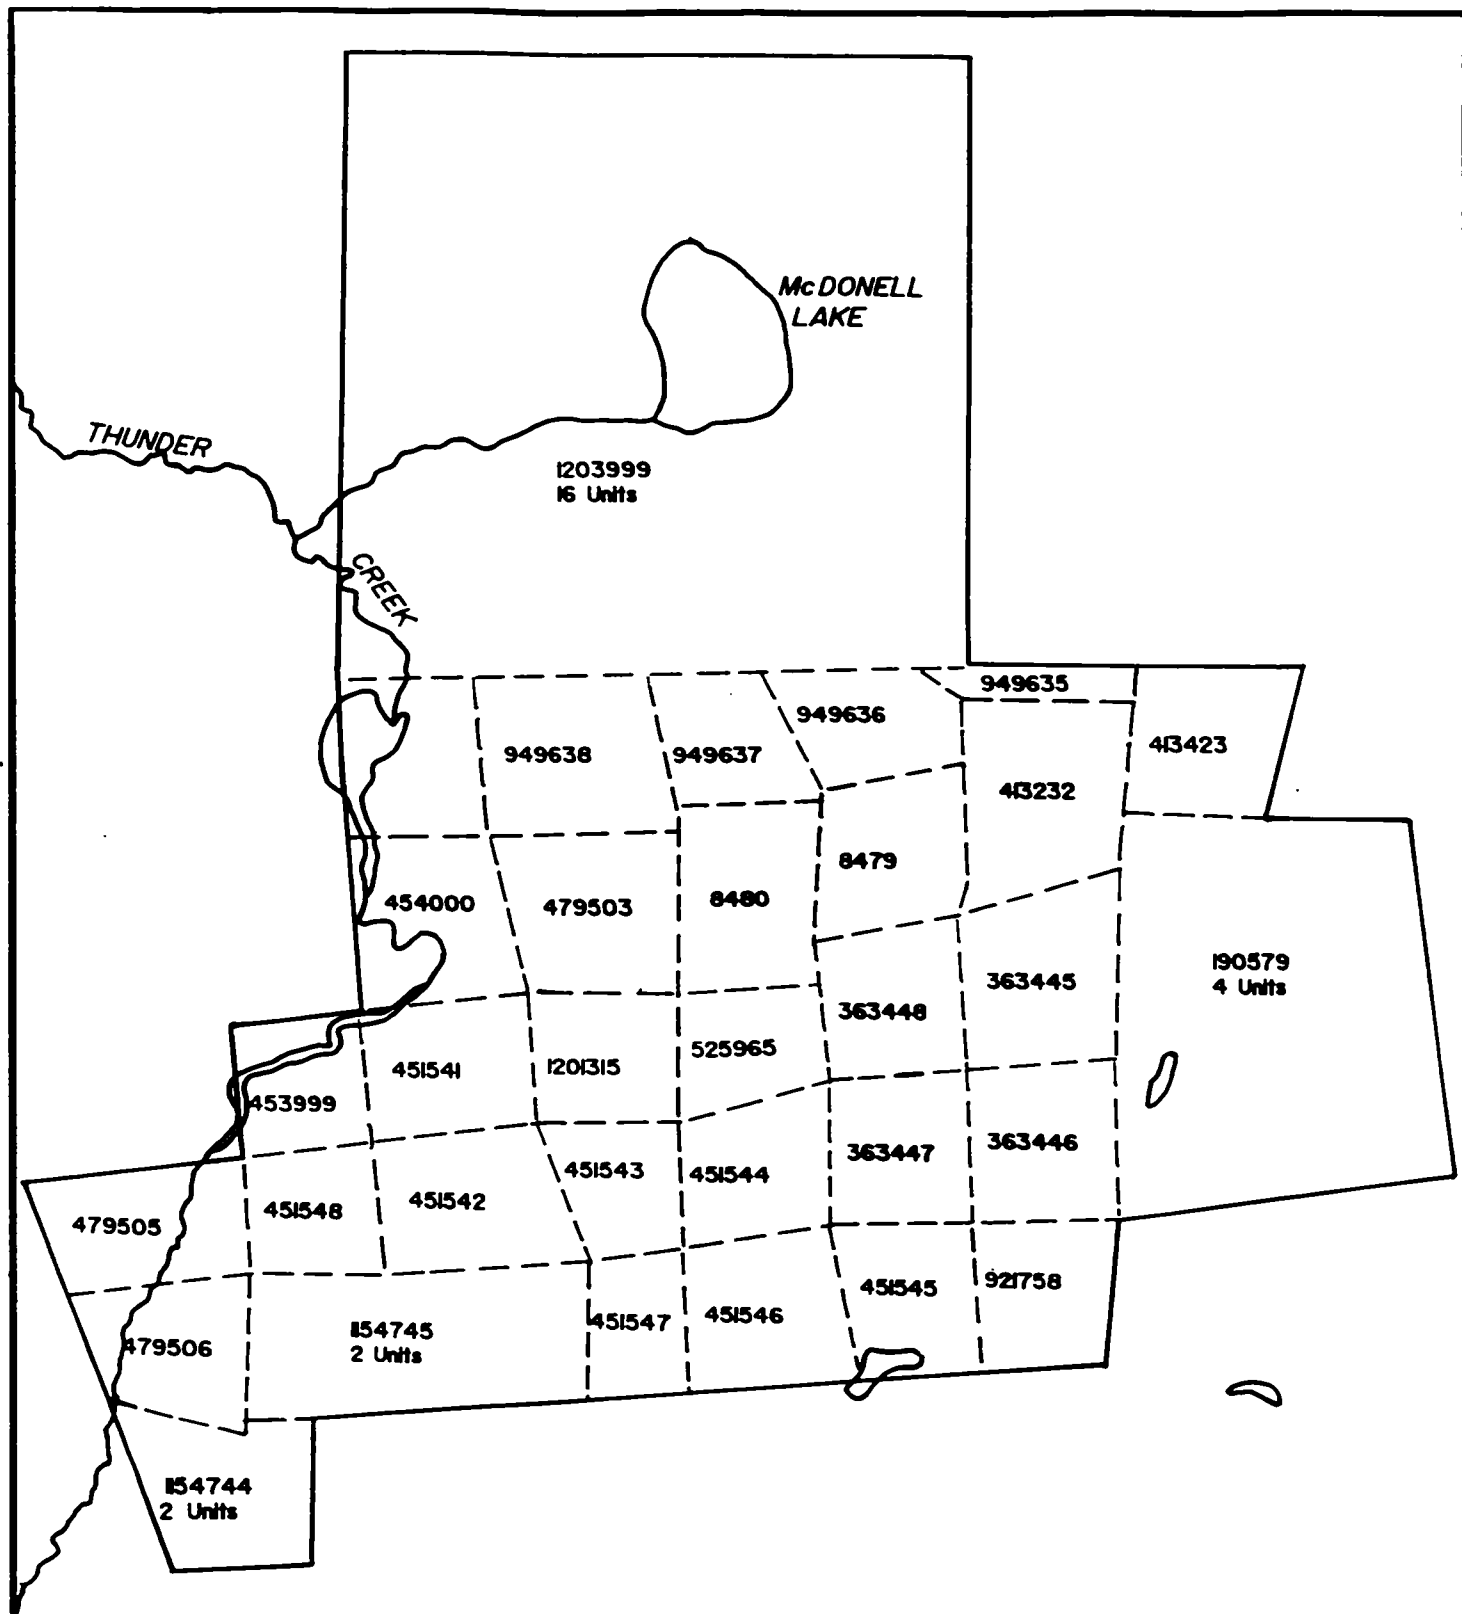

EXSICS EXPLORATION LTD.

P.O. Box 1000, P.M. 721
 Suite 13, Millinger Bldg, Timmins Ont.
 Telephone: 705-267-4551

CLIENT: PROSPECTORS ALLIANCE INC.

PROPERTY: GRID EAST BRISTOL TWP.

TITLE:

CLAIM SKETCH

Fig. 3

Date: Aug. 1996

Scale: 1:20,000

MNDM Plan#: G-3998

Drawn: P. Gauthier

Interp: J.C. Grant

Job No. E-190

PERSONNEL

The field crew directly responsible for the collection of all data were as follows.

Richard Mathieu..... Timmins, Ontario
 John C. Grant..... Timmins, Ontario

The program was completed under the direct supervision of J.C.Grant and all of the plotting and compilation was completed by P. Gauthier of Exsics.

GROUND PROGRAM

The ground program consisted of establishing a detailed metric grid across the claim group which would control the geophysical program. The linecutting consisted of 100 meter spaced lines which were chained with 20 meter pickets. The cross lines were turned off of an east-west control line, called the baseline. In all, a total of 60 kilometers of grid lines were to be established on the claims.

Once the cutting was completed, the grid was then read with a total field magnetic survey. This was completed using the Scintrex, MP-2 proton magnetometer. Specifications for the unit can be found as Appendix A of this report. The following parameters were kept constant throughout the survey period.

Line spacing.....	100 meters
Station spacing.....	20 meters
Reading interval.....	20 meters
Reference field.....	58,000 gammas
Datum Subtract.....	57,000 gammas
Diurnal correction.....	Tie line looping
Parameters measured.....	Earth's total magnetic field
Unit accuract.....	+/- 0.5 gammas.

The collected and corrected data was then plotted directly onto a base map at a scale of 1:5000, and then contoured at gamma intervals where possible. A copy of this contoured map is included in the back pocket of this report. At the time of this writing, a portion of the claim block was not completely cut. The cutting has resumed and it will be covered by the magnetic survey as soon as possible.

SURVEY RESULTS

At the time of this writing, approximately 10 kilometers of cutting was completed of which 7.0 kilometers has been covered by the magnetic survey. This initial survey was to test the property for magnetic characteristics which would highlight areas of geological structures which would be considered favourable horizons for follow-up work.

The test survey indicated that several areas of magnetic high units are striking across the grid. These areas are represented by narrow, moderate magnetic highs. Two of these highs are centered on claims 1154745 and 451547. A third unit is situated on claims 451541 and 1201315. A broad magnetic low was observed generally situated in the center of claim 451543.


Also noted in the test work was a weak cross structure generally paralleling line 900ME from the northend to about the baseline. This cross unit is represented by a series of small magnetic highs which may be indicative of a deeply buried diabase dike crossing the grid.

CONCLUSIONS AND RECOMMENDATIONS

The test survey concludes that the property should lend itself well to magnetic coverage. This should help in identifying areas for further follow-up by outlining the buried geological structures of the claim group. The remainder of the grid should be covered by the magnetic survey as well as a VLF-EM survey. The results of this preliminary geophysics should then be followed-up with a detailed geological and geochemical survey to test any and all magnetically active areas.

Respectfully submitted

J.C. Grant, CET, FGAC
August, 1996

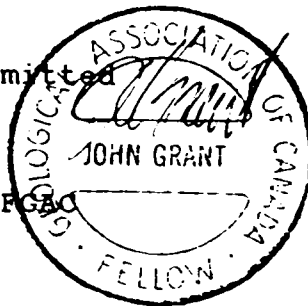

CERTIFICATE

I, John C. Grant, hereby certify that:

1) I am a graduate geophysicist (1975) of the three year program in Geological Technology at Cambrian College of Applied Arts and Technology, Sudbury, Campus. I have worked subsequently as an Exploration Geophysicist for Teck Exploration Limited (5 years), North Bay office, and as Exploration Manager and Geophysicist for Exsics Exploration Limited from 1980 to present.


2) I am a Member of the Certified Engineering Technologist Association since 1984.

3) I am a member of the Geological Association of Canada.

4) I have been actively engaged in my profession for the last twenty (20) years, including all aspects of exploration studies, surveys and interpretations.

5) I have no specific or special interest in the described property. I have been retained as a Consulting Geophysicist by the claim holders.

John Charles Grant, CET, FSAC

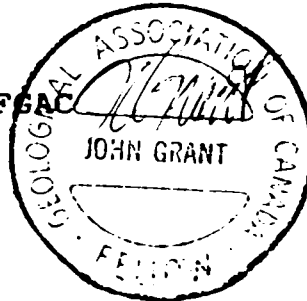

APPENDIX A



SCINTREX

earth science division

Proton Precession Magnetometer for Portable or Base Station Use

MP-2

- Features**
- ▶ 1 gamma sensitivity and accuracy over range of 20,000 to 100,000 gammas.
 - ▶ Operates in very high gradients, to 5000 gammas per metre.
 - ▶ Ultra small size and weight.
 - ▶ Up to 25,000 readings from only 8 D cells.
 - ▶ Battery pack isolated from electronics for corrosion protection.
 - ▶ Battery pack easily extended for winter use.
 - ▶ Light-emitting diode digital display, with complete test feature.
 - ▶ Unique no-glare polarized reflector permits easy reading in bright sunlight.
 - ▶ Indicator light warning of excessive gradient, ambient noise or electronic failure.
 - ▶ Digital readout of battery voltage.
 - ▶ Rugged all metal housing for rough field use at all temperatures.
 - ▶ Automatic recycling or external trigger features permit ready conversion to base station use.
 - ▶ Short reading time.
 - ▶ Broad operating temperature range.

The MP-2 is a portable one gamma proton precession magnetometer for field survey or base station use. The optimized design of sensor and circuitry using the latest CMOS components has resulted in a very light weight, low power consumption, rugged and reliable magnetometer.

Light emitting diodes coupled with an ingenious optically polarized reflector combine solid state reliability with easy reading even in bright sunlight.

A standard automatic recycling feature allows ready use of the MP-2, with suitable (optional) interfacing, as a base station recorder in analogue or digital form. Alternatively, a remote trigger can be used.

The noise-cancelling dual-coil sensor and electronics have been so designed as to effectively eliminate reading problems due to virtually all magnetic gradients which may be encountered in field survey conditions.



**TECHNICAL
DESCRIPTION OF
MP-2
MAGNETOMETER**



SCINTREX

RESOLUTION	1 Gamma.
TOTAL FIELD ACCURACY	± 1 Gamma over full operating range.
RANGE	20,000 to 100,000 gammas in 25 overlapping steps.
INTERNAL MEASURING PROGRAMME	Single reading — 3.7 seconds. Recyc feature permits automatic repetitive readings 3.7 seconds intervals.
EXTERNAL TRIGGER	External trigger input permits use of sampling intervals longer than 3.7 seconds.
DISPLAY	5 digit LED (Light Emitting Diode) readout displaying total magnetic field in gammas or normalized battery voltage.
RECORDER OUTPUT (Optional)	Multiplied precession frequency and gate time outputs for interfacing with incremental tape recorders (eg. Increlogger) for digital recording. As an additional option a digital to analogue convertor is available for use with analogue recorders.
GRADIENT TOLERANCE	Up to 5000 gammas/metre.
POWER SOURCE	8 alkaline "D" cells provide up to 25,000 readings at 25° C under reasonable signal/noise conditions (less at lower temperatures). Premium carbon-zinc cells provide about 40% of this number.
SENSOR	Omnidirectional, shielded, noise-cancelling dual coil, optimized for high gradient tolerance.
HARNESS	Complete for operation with staff or back pack sensor.
OPERATING TEMPERATURE RANGE	-35°C to +60°C.
SIZE	Console, with batteries: 80 x 160 x 250mm. Sensor: 80 x 150mm. Staff: 30 x 1550mm. (extended) 30 x 600 mm. (collapsed)
WEIGHTS	Console, with batteries: 1.8kg. Sensor: 1.3kg. Staff: 0.6kg.

SCINTREX LIMITED
222 Snidercroft Road,
Concord, Ontario, Canada L4K 1B5
TEL: (416) 649-2200 TELEFAX: (416) 964-570

Report of Work Conducted After Recording Claim


Mining Act

Transaction Number
W9660.00506

All information collected on this form is obtained under the authority of the Mining Act. This information will be used for correspondence. Questions about this form should be directed to the Provincial Manager, Mining Lands, Ministry of Northern Development and Mines, Fourth Floor, 159 Cedar Street, Toronto, Ontario, P3E 6A5, telephone (705) 670-7264.

2-10819

- Instructions:
- Please type or print and submit in duplicate.
 - Refer to the Mining Act and Regulations for requirements.
 - A separate copy of this form must be completed for each claim.
 - Technical reports and maps must accompany this form.
 - A sketch, showing the claims the work is assigned to, must be submitted.

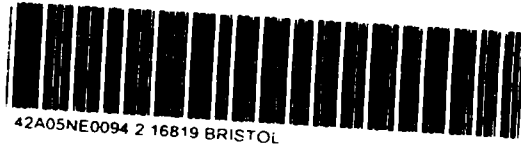

900

Holder(s) P. E. ALLERSTON / PROSPECTOR'S ALLIANCE INC.		Client No. 101930 / 301944
Address 21 RICHMOND STREET WEST, TORONTO, ONT.		Telephone No. 416-366-2098
Division PORCUPINE	Township/Area BRISTOL	M or G Plan No. G-3998
From: July 15/96		To: Aug 10/96

Work performed (Check One Work Group Only)

Work Group	Type
Technical Survey	LINE CUTTING, MAG, GEOPHYSICS, REPORTS, RECORDING
Geological Work, including Drilling	
Rehabilitation	
Other Authorized Work	
Other	
Assessment from	

Assessment Work Claimed on the Attached Statement of Costs \$ **3,627.00**

The Minister may reject for assessment work credit all or part of the assessment work submitted if the recorded holder cannot verify expenditures claimed in the statement of costs within 30 days of a request for verification.

Name and Survey Company Who Performed the Work (Give Name and Address of Author of Report)

Name	Address
GRANT/EXSICUS INC.	Box 1880, Timmins, Ontario

RECEIVED
AUG 25 1996
MINING LANDS BRANCH

(Schedule if necessary)

Declaration of Beneficial Interest * See Note No. 1 on reverse side

At the time the work was performed, the claims covered in this work were recorded in the current holder's name or held under a beneficial interest of the recorded holder.	Date Aug 12/96	Recorded Holder or Agent (Signature) <i>[Signature]</i>
--	--------------------------	--

Declaration of Work Report

I have a personal knowledge of the facts set forth in this Work report, having performed the work or witnessed same during and/or after the work was performed, and the report is true.

Name of Person Certifying C. Grant Box 1880 Timmins Ont	
Date 4/15/96	Certified By (Signature) <i>[Signature]</i>

Use Only

1021	Date Recorded	Mining Recorder NOT DATED <i>[Signature]</i>	RECEIVED (c) AUG 12 1996 TB 420 PORCUPINE MINING BRANCH
	Department Approval Date Nov 10/96	Date Approved	
	Date Notice for Amendments Sent		



Statement of Costs for Assessment Credit

État des coûts aux fins du crédit d'évaluation

Mining Act/Loi sur les mines

Transaction No./N° de transaction

W9660.00506

Personal information collected on this form is obtained under the authority of the Mining Act. This information will be used to maintain a record and ongoing status of the mining claim(s). Questions about this collection should be directed to the Provincial Manager, Minings Lands, Ministry of Northern Development and Mines, 4th Floor, 159 Cedar Street, Sudbury, Ontario P3E 6A5, telephone (705) 670-7264.

Les renseignements personnels contenus dans la présente formule sont recueillis en vertu de la Loi sur les mines et serviront à tenir à jour un registre des concessions minières. Adresser toute question sur la collecte de ces renseignements au chef provincial des terrains miniers, ministère du Développement du Nord et des Mines, 159, rue Cedar, 4^e étage, Sudbury (Ontario) P3E 6A5, téléphone (705) 670-7264.

1. Direct Costs/Coûts directs

Type	Description	Amount Montant	Totals Total global
Wages Salaires	Labour Main-d'oeuvre		
	Field Supervision Supervision sur le terrain		
Contractor's and Consultant's Fees Droits de l'entrepreneur et de l'expert-conseil	Type 8.0 km x 765 LINE CUTTING	7130.00	
	6.2 km x 100 GEOPHYSICS	620.00	
	PLANS & REPORTS	650.00	3390.00
Supplies Used Fournitures utilisées	Type		
	GST ON		
	TOTAL		237.30
Equipment Rental Location de matériel	Type		
Total Direct Costs Total des coûts directs			3627.30


2. Indirect Costs/Coûts indirects

** Note: When claiming Rehabilitation work Indirect costs are not allowable as assessment work. Pour le remboursement des travaux de réhabilitation, les coûts indirects ne sont pas admissibles en tant que travaux d'évaluation.

Type	Description	Amount Montant	Totals Total global
Transportation Transport	Type		
		2.16813	
Food and Lodging Nourriture et hébergement			
Mobilization and Demobilization Mobilisation et démoblisation			
Sub Total of Indirect Costs Total partiel des coûts indirects			
Amount Allowable (not greater than 20% of Direct Costs) Montant admissible (n'excédant pas 20 % des coûts directs)			
Total Value of Assessment Credit (Total of Direct and Allowable Indirect costs) Valeur totale du crédit d'évaluation (Total des coûts directs et indirects admissibles)			

Note: The recorded holder will be required to verify expenditures claimed in this statement of costs within 30 days of a request for verification. If verification is not made, the Minister may reject for assessment work all or part of the assessment work submitted.

Note: Le titulaire enregistré sera tenu de vérifier les dépenses demandées dans le présent état des coûts dans les 30 jours suivant une demande à cet effet. Si la vérification n'est pas effectuée, le ministre peut rejeter tout ou une partie des travaux d'évaluation présentés.

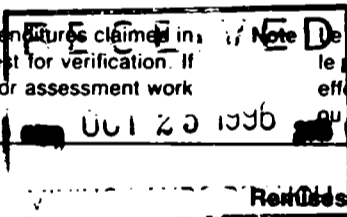

Filing Discounts

- Work filed within two years of completion is claimed at 100% of the above Total Value of Assessment Credit.
- Work filed three, four or five years after completion is claimed at 50% of the above Total Value of Assessment Credit. See calculations below:

Total Value of Assessment Credit	Total Assessment Claimed
	x 0.50 =

Remises pour dépôt

- Les travaux déposés dans les deux ans suivant leur achèvement sont remboursés à 100 % de la valeur totale susmentionnée du crédit d'évaluation.
- Les travaux déposés trois, quatre ou cinq ans après leur achèvement sont remboursés à 50 % de la valeur totale du crédit d'évaluation susmentionné. Voir les calculs ci-dessous.

Valeur totale du crédit d'évaluation	Evaluation totale demandée
	x 0,50

Certification Verifying Statement of Costs

I hereby certify that the amounts shown are as accurate as possible and these costs were incurred while conducting assessment work on the lands shown in the accompanying Report of Work form.

I, [Signature] am authorized (Recorded Holder, Agent, Position in Company)

make this certification

Attestation de l'état des coûts

J'atteste par la présente que les montants indiqués sont le plus exact possible et que les dépenses ont été engagées pour effectuer les travaux d'évaluation sur les terrains indiqués dans la formule de rapport de travail ci-joint.

Et qu'à titre de [Signature] je suis autorisé (titulaire enregistré, représentant, poste occupé dans la compagnie)

à faire cette attestation.

Signature [Signature] Date Aug 12/96

Ministry of
Northern Development
and Mines

Ministère du
Développement du Nord
et des Mines



November 1, 1996

Gary White
Mining Recorder
60 Wilson Avenue, 1st Floor
Timmins, ON
P4N 2S7

Geoscience Assessment Office
933 Ramsey Lake Road
6th Floor
Sudbury, Ontario
P3E 6B5

Telephone: (705) 670-5853
Fax: (705) 670-5863

Dear Sir or Madam:

Submission Number: 2.16819

Subject: Transaction Number(s): W9660.00506

After reviewing the Work Report(s) we have prepared this letter and the attached summary, which lists the results of our review. Requirements of the Assessment Work Regulation may not have been fully met. Please examine the summary to determine the next course of action concerning the identified Work Report(s).

NOTE: The 90 day deemed approval provision, subsection 6(7) of the Assessment Work Regulation, is no longer in effect for this submission.

PLEASE NOTE ANY REQUESTED REVISIONS MUST BE SUBMITTED IN DUPLICATE.

If the anniversary dates for the mining claims affected by this correspondence have not passed, a number of options are available. Please contact the Mining Recorder to discuss these options.

If you have any questions regarding this correspondence, please contact Steve Beneteau at (705)670-5855.

Yours sincerely,

A handwritten signature in black ink, appearing to read "Ron C. Gashinski".

ORIGINAL SIGNED BY
Ron C. Gashinski
Senior Manager, Mining Lands Section
Mines and Minerals Division

Work Report Assessment Results

Submission Number: 2.16819

Date Correspondence Sent: November 01, 1996

Assessor: Steve Beneteau

Transaction Number	First Claim Number	Township(s) / Area(s)	Status	Approval Date
W9660.00506	1154745	BRISTOL	Approval	October 31, 1996

Section:

14 Geophysical MAG

Correspondence to:

Mining Recorder
Timmins, ON

Resident Geologist
Timmins, ON

Assessment Files Library
Sudbury, ON

Recorded Holder(s) and/or Agent(s):

John C. Grant
TIMMINS, ONTARIO, CANADA

RALPH E. ALLERSTON
TIMMINS, ONTARIO

PROSPECTORS ALLIANCE LIMITED
TORONTO, ONTARIO

MAP SYMBOLOLOGY

Aerial Cableway	Pipeline (above ground)
Boundary	Railroad
Interpretation	Single Track
Interpretation	Double Track
District, Township	Abandoned
Interpretation	Turbine
Approximate	Road
Lot, Concession	Highway, County
Approximate	Tennessee
Point Boundary	Access (road of negligible maintenance or important driveway)
Bridge	Trail, Bush Road (single way)
Road, Railway	Trail, Bush Road (double way)
Building	Rapids
Chimney	Double line river with multiple rapids
Cliff, Pit, Pile	Double line river with multiple rapids
Contours	Reservoir
Interpretation	Approximate
Approximate	River, Stream, Canal
Control Points	Approximate
Horizontal	Vertical
Vertical	Vertical
Culvert	Vertical
Falls	Vertical
Double line river	Spot Elevation (lake elevation)
Fence, Hedge, Wall	Tower
Feature Outline (Construction features, etc.)	Transmission Line
Flooded Land	Pole
Lock	Pylon
Marsh or Swamp	Tunnel
Mast	Utility Poles
Mine Head Frame	Wharf, Dock, Pier
Outcrop	Wooded Area

AREAS WITHDRAWN FROM DISPOSITION

M.R.O. - MINING RIGHTS ONLY
 S.R.O. - SURFACE RIGHTS ONLY
 M.+S. - MINING AND SURFACE RIGHTS

Disposition	Order No.	Date	Disposition	File
	S.R.O.	164584		

MINING AND SURFACE RIGHTS WITHDRAWN FROM PROSPECTING, STAMPS, SALE OR LEASE, SECTION 34 OF THE MINING ACT (R.S.O. 1990) ORDER NO. W-86/86 WR DATED 06-OCT-86.

MINING AND SURFACE RIGHTS RE-OPENED TO PROSPECTING, STAMPS, SALE OR LEASE UNDER SECTION 35 OF THE MINING ACT R.S.O. 1990, ORDER NO. P-22/92 NR DATED 92-AUG-01 (CLAIM NOS. P-4304 TO P-43548 INCL. P-45399, P-45400, P-479503 TO P-479506 INCL. AND P-48035 TO P-48037 INCL.)

MINING AND SURFACE RIGHTS WITHDRAWN FROM PROSPECTING, STAMPS, SALE OR LEASE, SECTION 34 OF THE MINING ACT (R.S.O. 1990) ORDER NO. W-60/86 WR DATED 06-MAY-86.


THIS TWP. SUBJECT TO FOREST ACTIVITY IN 1992/93. FURTHER INFORMATION AVAILABLE ON FILE.

MINING AND SURFACE RIGHTS RE-OPENED TO PROSPECTING, STAMPS, SALE OR LEASE UNDER SECTION 35 OF THE MINING ACT R.S.O. 1990, ORDER NO. P-19/96 NR DATED 92-SEP-10 AT 100 A.M. EAST (CLAIM NOS. P-28286 TO P-28287 INCL. AND P-28289 TO P-28292 INCL.)


MINING AND SURFACE RIGHTS RE-OPENED TO PROSPECTING, STAMPS, SALE OR LEASE UNDER SECTION 35 OF THE MINING ACT R.S.O. 1990, ORDER NO. P-19/92 NR DATED 92-SEP-10 AT 100 A.M. EAST (CLAIM NOS. P-4558 TO P-4553 INCL.)

THE INFORMATION THAT APPEARS ON THIS MAP HAS BEEN COMPILED FROM VARIOUS SOURCES AND ACCURACY IS NOT GUARANTEED. THOSE WISHING TO STAKE MINING CLAIMS SHOULD CONSULT WITH THE MINING RECORDER, MINISTRY OF NORTHERN DEVELOPMENT AND MINES, FOR ADDITIONAL INFORMATION ON THE STATUS OF THE LANDS SHOWN HEREON.

KEY PLAN For O.B.M. Map

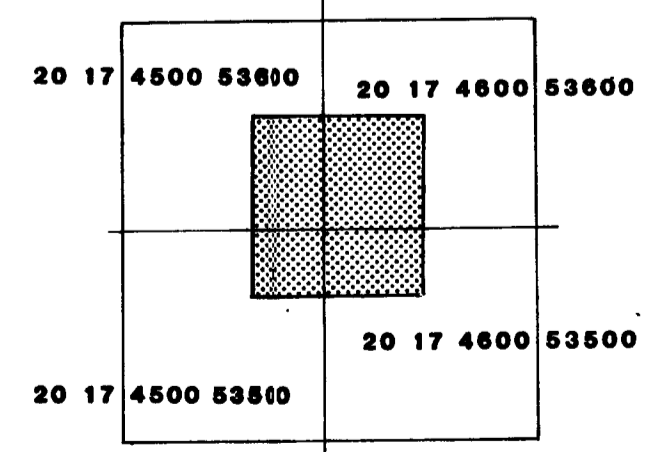

not to scale

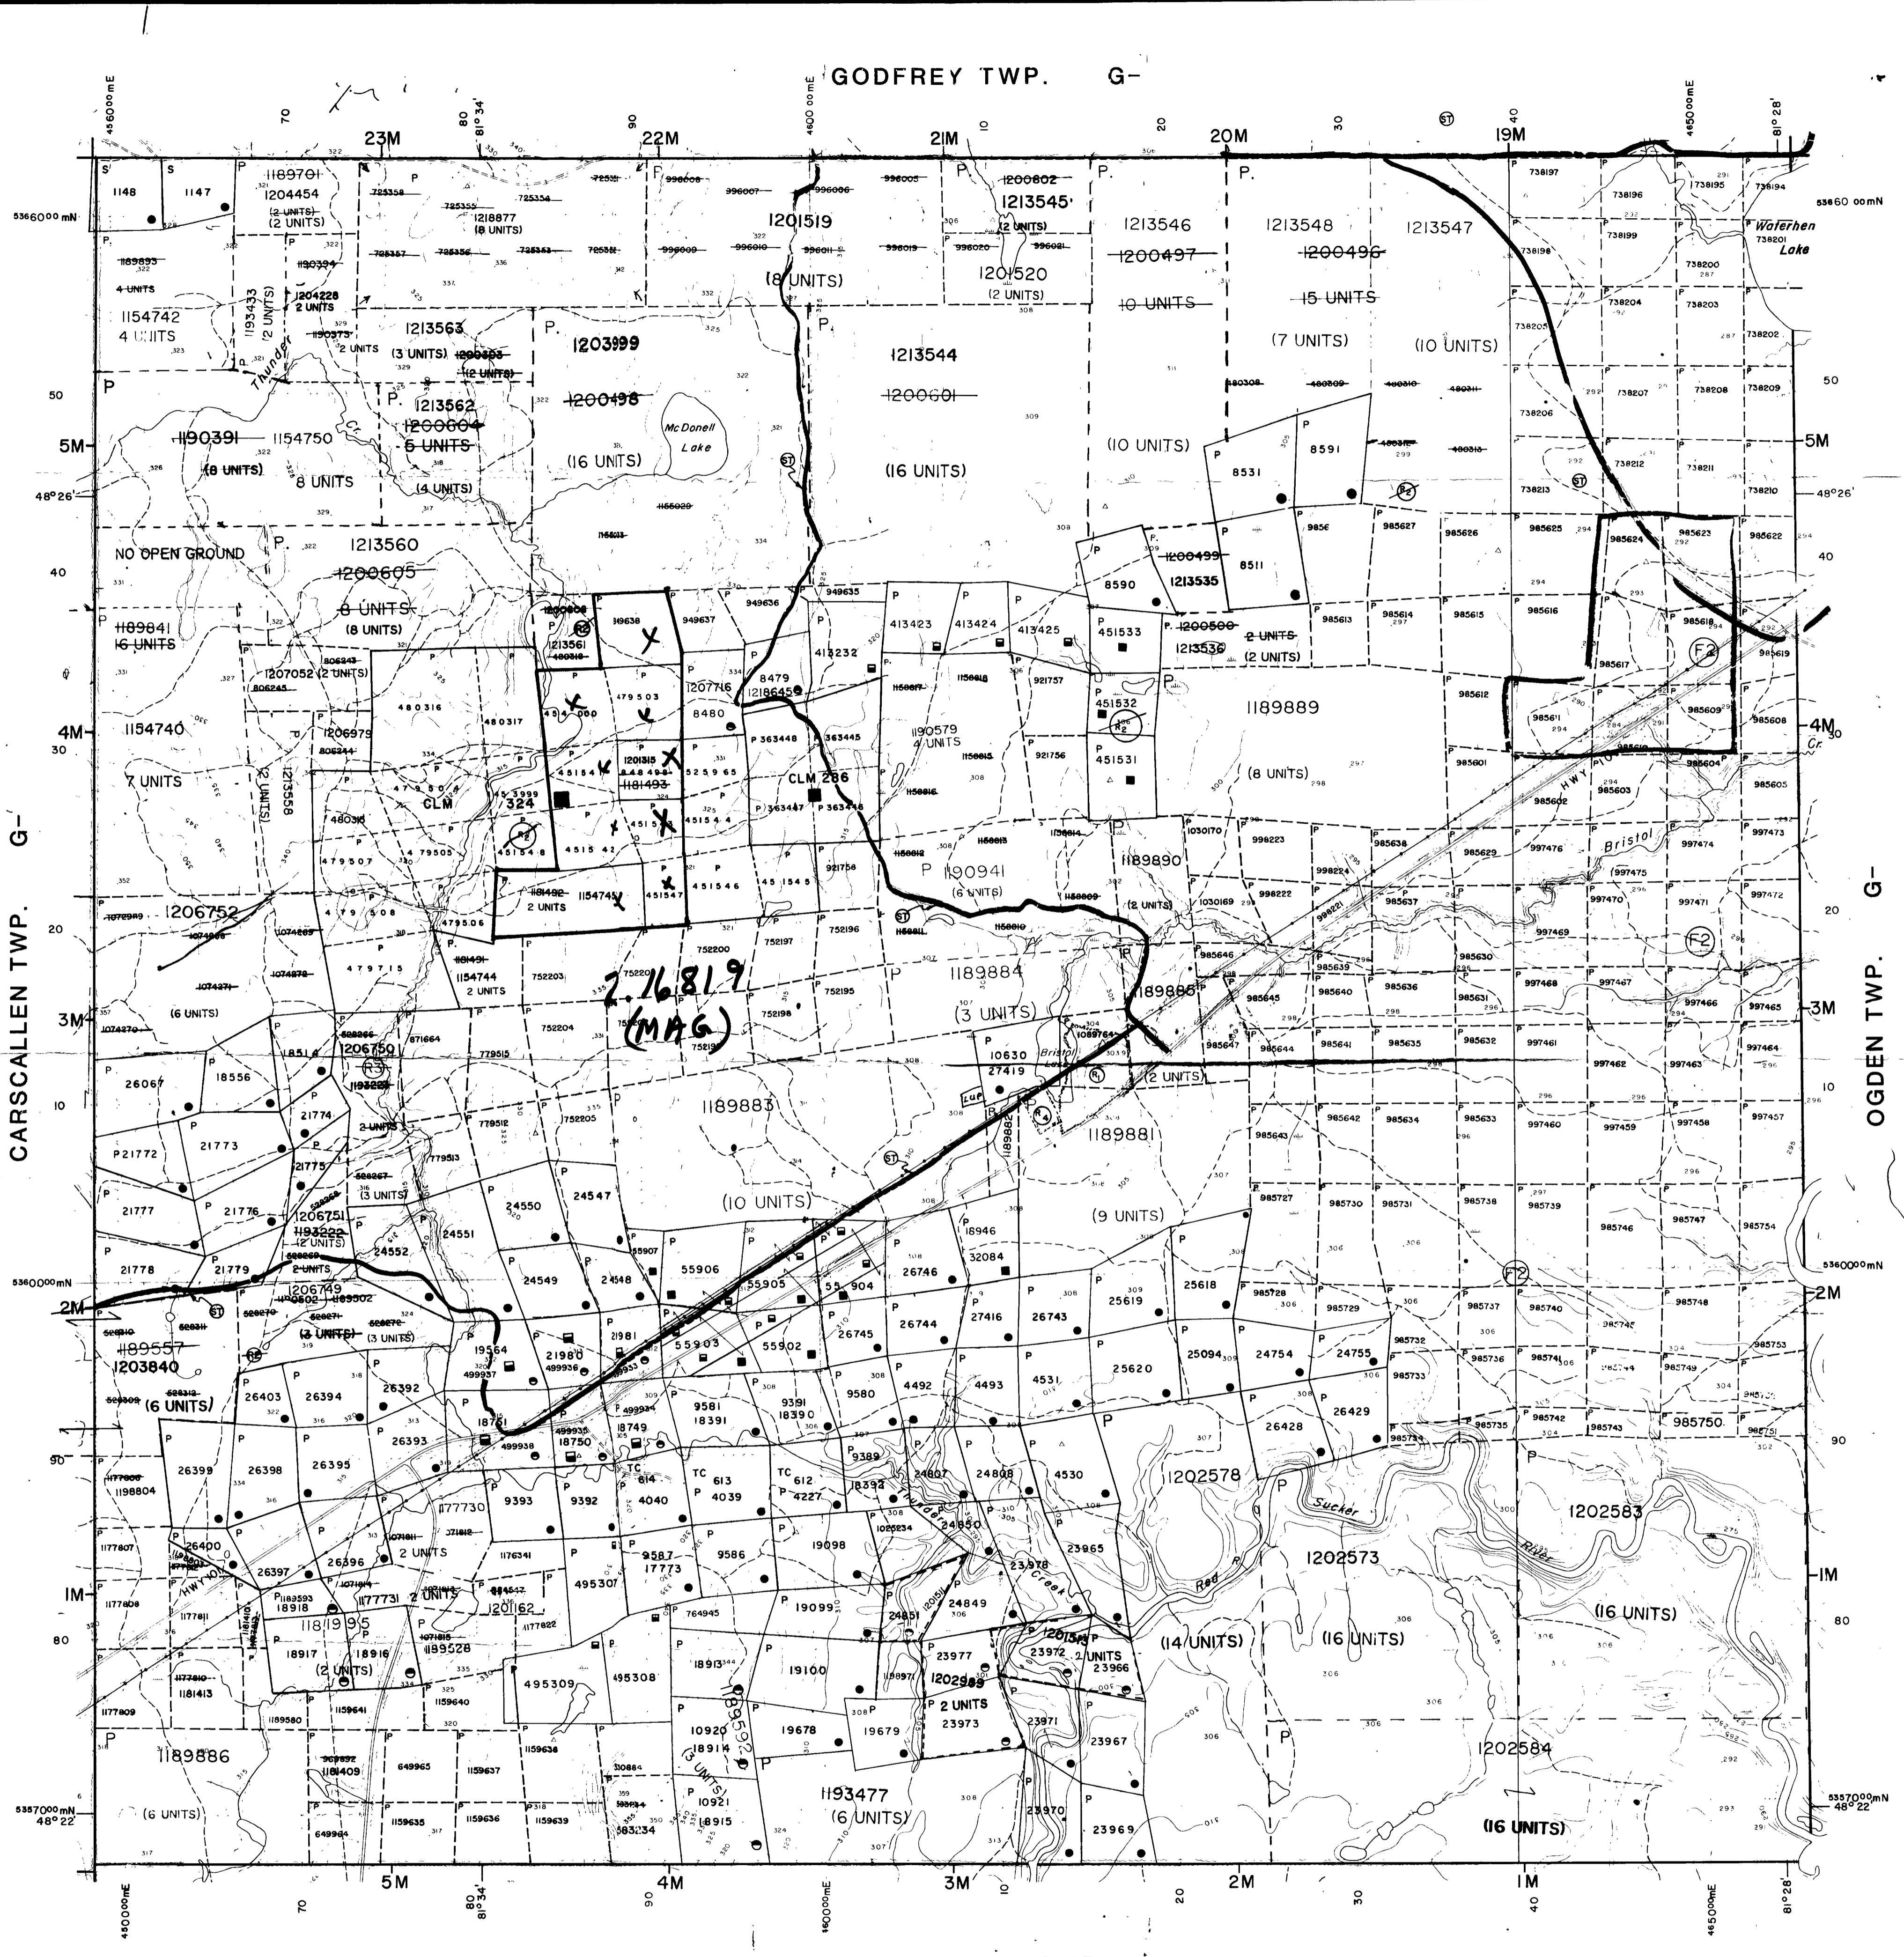


LEGEND

Highway and Route No.	
Other Roads	
Trails	
Surveyed Lines	
Townships, Base Lines, Etc.	
Lots, Mining Claims, Parcels, Etc.	
Unsurveyed Lines	
Lot Lines	
Parcel Boundary	
Mining Claims Etc.	
Railway and Right of Way	
Utility Lines	
Non-Perennial Stream	
Flooding or Flooding Rights	
Subdivision or Composite Plan	
Reservations	
Original Shoreline	
Marsh or Muskeg	
Mines	
Traverse Monument	

DISPOSITION OF CROWN LANDS

TYPE OF DOCUMENT	SYMBOL
PATENT, SURFACE & MINING RIGHTS	
SURFACE RIGHTS ONLY	
MINING RIGHTS ONLY	
LEASE, SURFACE & MINING RIGHTS	
SURFACE RIGHTS ONLY	
MINING RIGHTS ONLY	
LICENCE OF OCCUPATION	
ORDER-IN-COUNCIL	
RESERVATION	
CANCELLED	
SAND & GRAVEL	

NOTE: MINING RIGHTS IN PARCELS PATENTED PRIOR TO MAY 6, 1913, VESTED IN ORIGINAL PATENTEES BY THE PUBLIC LANDS ACT, R.S.O. 1970, CHAP. 380, SEC. 63, SUBSEC. 1.

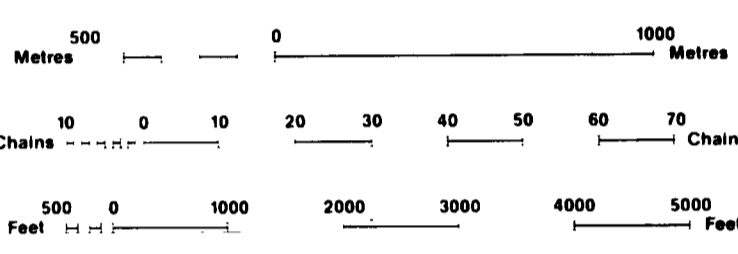

SCALE 1:20 000 ZONE 17

- APPLICATION PENDING UNDER THE PUBLIC LANDS ACT NOTICE RECEIVED 92-DEC-21 SNOWMOBILE TRAILS
- APPLICATION FOR CROWN LAND UNDER THE PUBLIC LANDS ACT NOTICE RECEIVED 93-MAY-4 CBR EXCAVATION TOP SOIL HOLDING STORAGE ETC.
- THIS TWP SUBJECT TO FOREST ACTIVITY IN 1995/96. AREAS DESIGNATED EXACTLY AS SUBMITTED BY MNR TIMMINS.

2.16819

W9460.00506

TOWNSHIP

BRISTOL

M.N.R. ADMINISTRATIVE DISTRICT

TIMMINS

MINING DIVISION

PORCUPINE

LAND TITLES / REGISTRY DIVISION

COCHRANE




RECEIVED
 Ministry of Natural Resources
 Management
 15 1996

ORIGINAL COMPILATION JULY 1984
 ACTIVATED JULY 13, 1992 BY D.C.
 REVISED BY G.W.
 CHECKED BY G.W.

MINING LANDS BRANCH G-3998




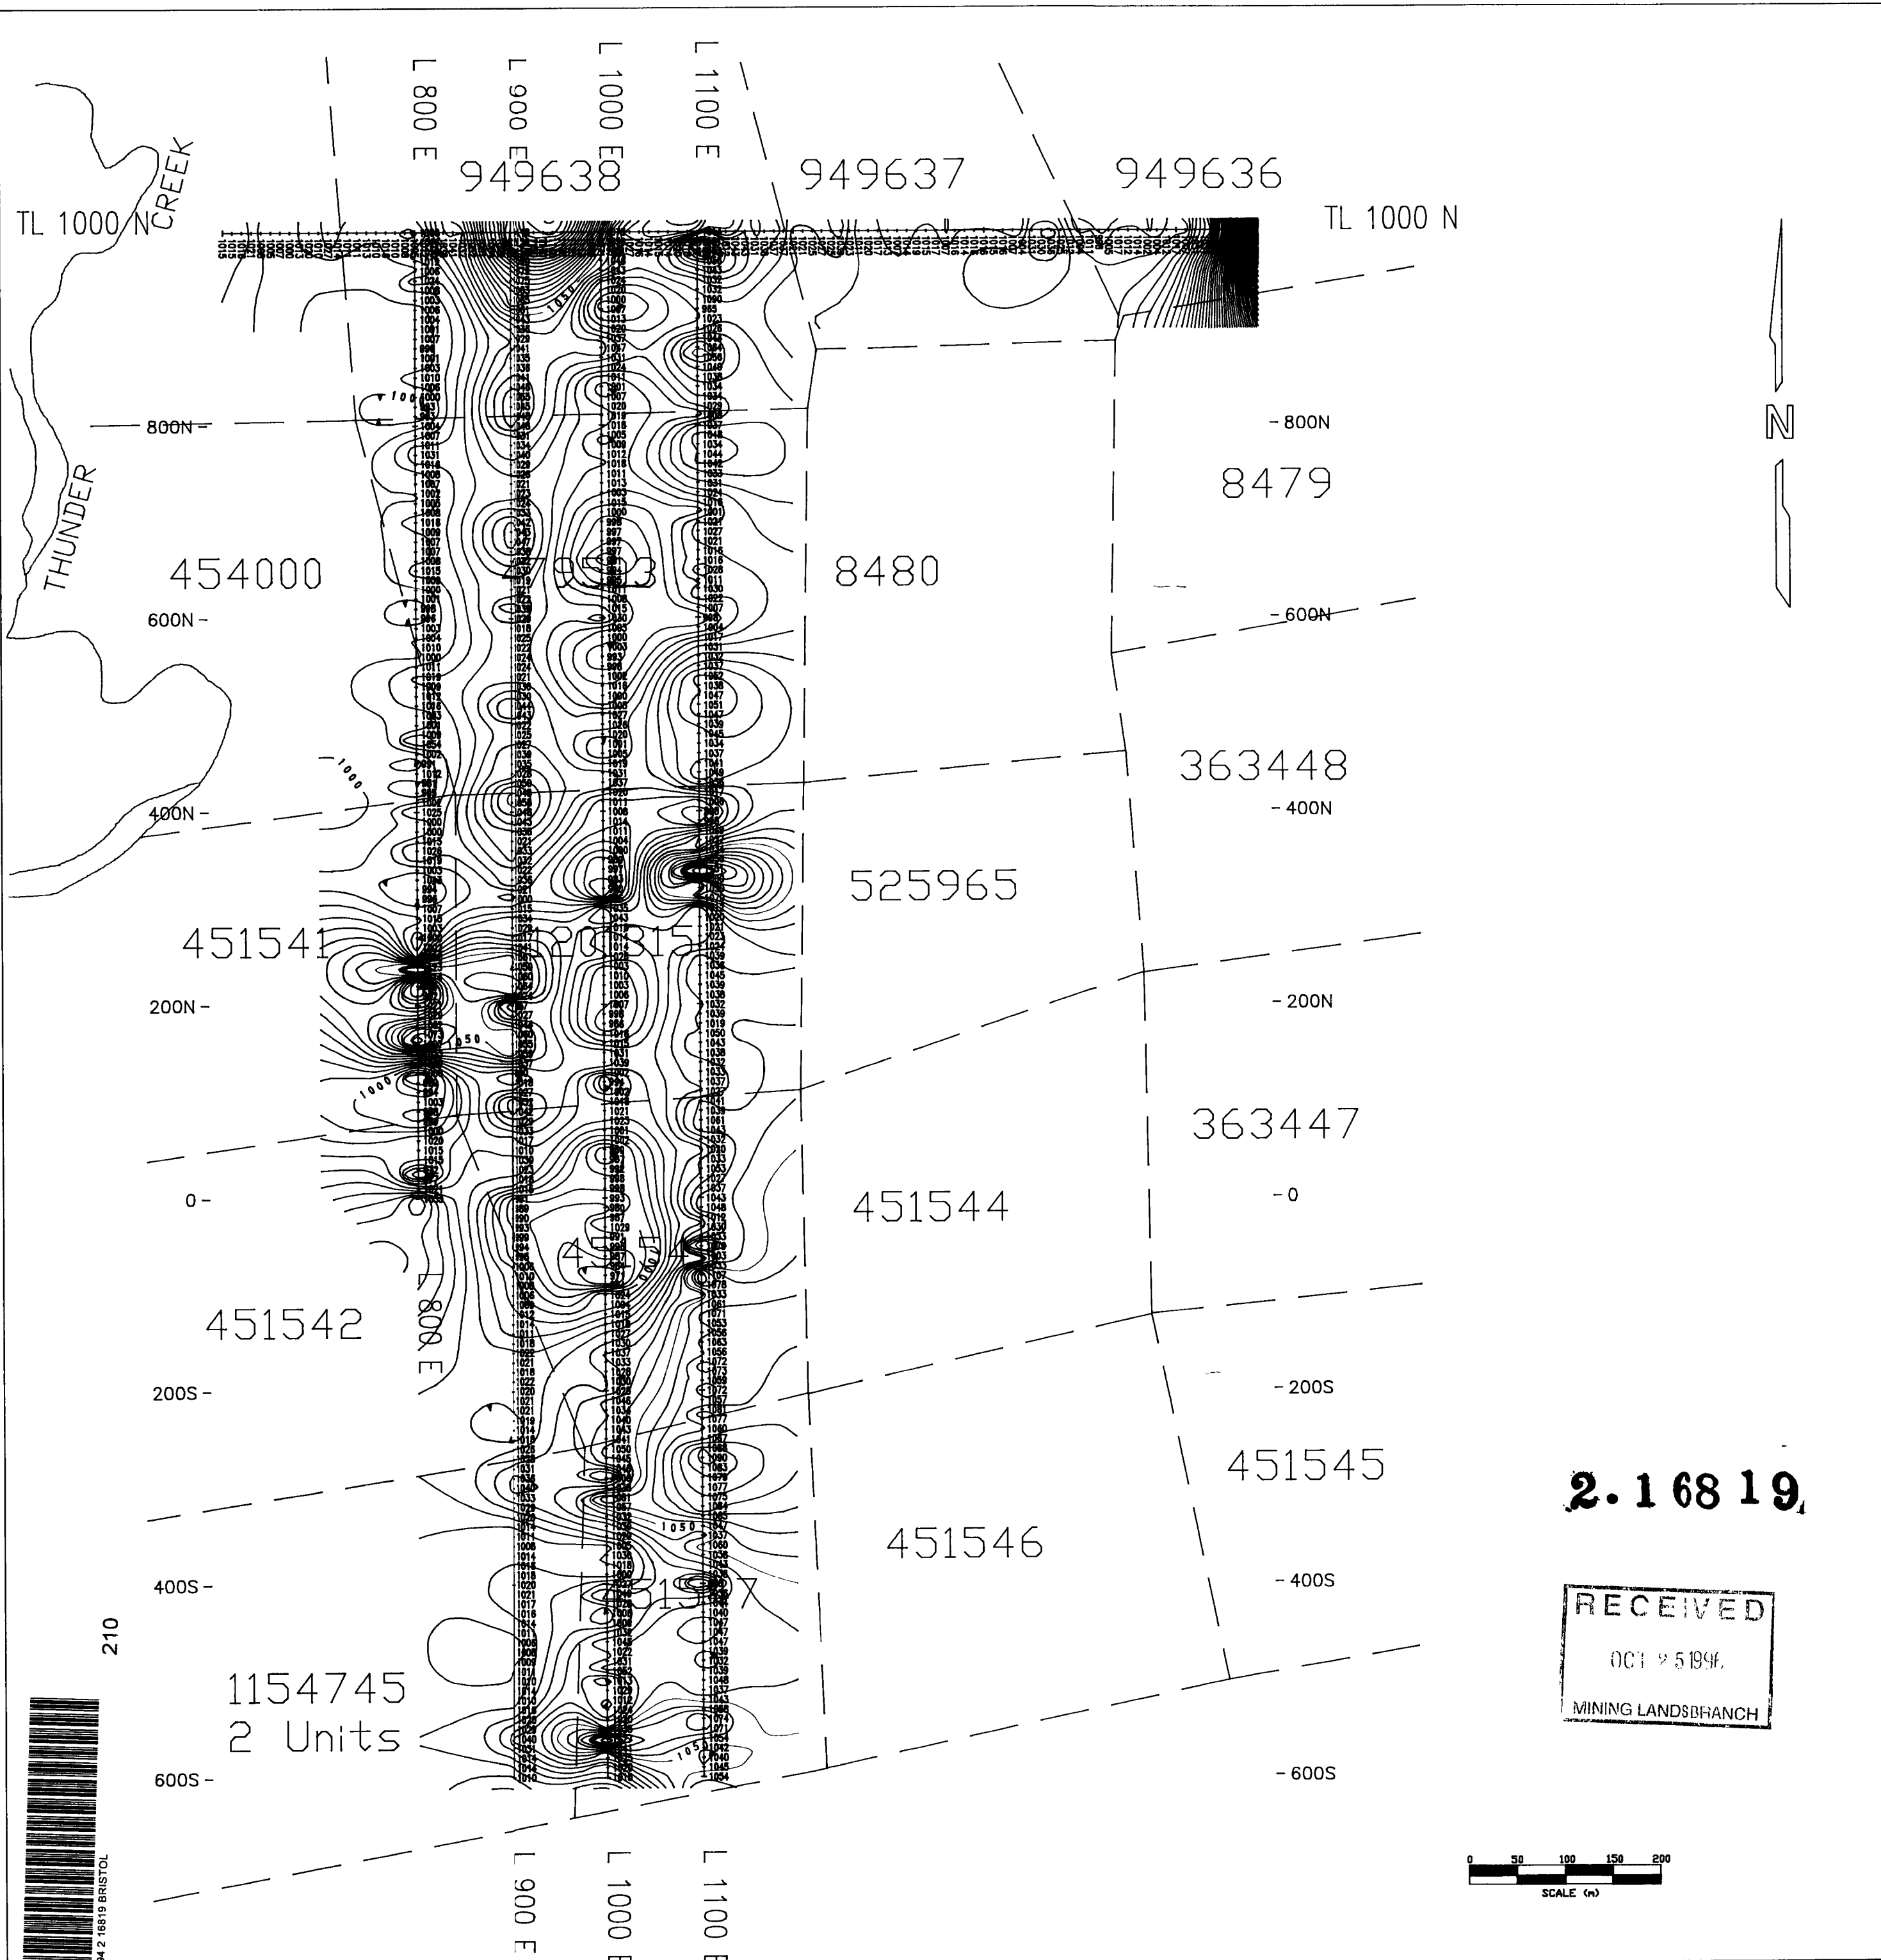


210

2.16819

RECEIVED
OCT 15 1996
MINING LANDS BRANCH

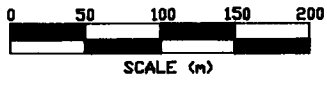

LEGEND
 Instruments: Scintrex MP-2 Proton Precession Mag
 Parameters Measured: Earth's total magnetic field
 Accuracy: +/- 10 nano-teslas
 Diurnals: Corrected by base line looping
 Contour Interval: 0,5,10,15,20,25,30,35,40,.....
 Reference Field:
 Datum Subtracted: 57,000 gammas

 EXSICS EXPLORATION LTD. P.O. Box 1880, P4N-7X1 Suite 13, Hollinger Bldg, Timmins Ont. Telephone: 705-267-4151		
CLIENT: PROSPECTORS ALLIANCE INC.		
PROPERTY: GRID EAST PROPERTY		
TITLE: BRISTOL TWP MAGNETOMETER SURVEY		
Date: Aug. 1996	Scale: 1:5000	NTS:
Drawn: P. Gauthier	Interp: J.C. Grant	Job No.: E-190