

Date: 19 Mar, 2000

MAPLE MINERALS INC.

Page: 1 of 2

Northing: 450.00
 Easting: 10400.00
 Elevation: 1000.00

DRILL HOLE RECORD

Drill Hole: MAP-00-1

Collar Azi.: 330.0
 Collar Dip: -50.0

*** Dip Tests ***
 Depth Azi. Dip

Claim: P-1218063
 Township: Thomas Township
 Core Size: NQ
 Stored at: Timmins
 Date Started: 1 Feb 2000
 Date Finished: 2 feb 2000

Hole Length: 104.60

Property: Maple Minerals
 Date Logged: 3 Feb 2000
 Drilled by: Norex Drilling Ltd.
 Logged by: R.S. Middleton
 Materials left: None
 Purpose: To test IP anomaly and regional stratigraphy.
 Field Co-ords:

R. Middleton
 PGM

From (m)	To (m)	Geology	Sample	From (m)	To (m)	Lngt (m)	AU PPM
.00	48.00	OVERBURDEN					
48.00	104.60	MAFIC FRAGMENTAL CRYSTALL TUFF Similar in appearance to basalt fragmental near Sheraton Lake - Golden Knight hole Sk-1. Vesicular- pumaceous felsic cream to yellow fragments up to 0.25 m in size stretched down core axis. Chlorite spotting throughout. Schistosity is 0 to 10 degrees to core axis so may be drilling downdip. Hole stopped and moved north to drill Azimuth 160 degrees from 612N. 65.00 Whole rock of felsic fragmental - sample MAP1-65.					

From (m)	To (m)	Geology	Sample	From (m)	To (m)	Lngt (m)	AU PPM
		<p style="text-align: center;">Matrix medium to dark green.</p> <p>104.60 END OF HOLE.</p>					

Date: 19 Mar, 2000

MAPLE MINERALS INC.

Page: 1 of 2

Northing: 612.00
 Easting: 10400.00
 Elevation: 1000.00

DRILL HOLE RECORD

Drill Hole: MAP-00-2

Collar Azi.: 160.0
 Collar Dip: -50.0

*** Dip Tests ***
 Depth Azi. Dip

Claim: P-1218063
 Township: Thomas Township
 Core Size: NQ
 Stored at: Timmins
 Date Started: 2 Feb. 2000
 Date Finished: 3 Feb. 2000

Hole Length: 176.00

Property: Maple Minerals
 Date Logged: 3 Feb. 2000
 Drilled by: Norex Drilling Ltd.
 Logged by: R.S. Middleton
 Materials left: None
 Purpose: To test IP anomaly and regional stratigraphy.
 Field Co-ords:

R. Middleton
 P. Eng

From (m)	To (m)	Geology	Sample	From (m)	To (m)	Lngt (m)	AU PPM
.00	68.00	OVERBURDEN Sand. Reamed casing to 71.0 metres after to cover seams in bedrock at 68.6m and 69m.					
68.00	176.00	MAFIC FRAGMENTAL CRYSTALL TUFF Crystall tuff package of rocks similar to magnesium thoeliite in appearance to units in Sheraton Township south of Sheraton Lake. (see Golden Knight hole SK-1). Green chloritic matrix with large felsic ? fragments that are pumaceous - full of gas holes, quartz eyes, chlorite spots. Amygdules stretched 68m to 79m, then becomes more fragmental after 79m.					

From (m)	To (m)	Geology	Sample	From (m)	To (m)	Lngr (m)	AU PPM
		Some fragments are yellow - cream in colour and others have alteration margins and are more overprinted with chlorite.					
		Shearing - stretching 68m to 79m is 25 degrees to core axis. Occasional 0.5cm quartz calcite veinlets along fractures or joints at 35 to 40 degrees to core axis.					
		72.50 MAP-2: Whole rock of amygdaloidal basalt.					
		113.00 114.00 Up to 30% quartz cl\alcite veining. Some fragments stretched slightly at 30 degrees to core axis. Most are ellipsoidal to angular. Core remains the same to 176.0 m. Fragments reach 8 cm in size - normally 3 to 4 cm.					
		See MAP-1 for whole rock of a fragmental and core.					
		176.00 END OF HOLE.					



Date: 19 Mar, 2000

MAPLE MINERALS INC.

Page: 1 of 2

Northing: 275.00
 Easting: 10600.00
 Elevation: 1000.00

DRILL HOLE RECORD

Drill Hole: MAP-00-3

Collar Azi.: 180.0
 Collar Dip: -50.0

*** Dip Tests ***
 Depth Azi. Dip

Claim: P-1218063
 Township: Sheraton Township
 Core Size: NQ
 Stored at: Timmins
 Date Started: 4 Feb. 2000
 Date Finished: 5 Feb. 2000

Hole Length: 142.00

Property: Maple Minerals
 Date Logged: 6 Feb. 2000
 Drilled by: Norex Drilling Ltd.
 Logged by: R.S. Middleton
 Materials left: None
 Purpose: To test IP anomaly and regional stratigraphy.
 Field Co-ords:

R. Middleton
Per

From (m)	To (m)	Geology	Sample	From (m)	To (m)	Lngr (m)	AU PPM
.00	63.00	OVERBURDEN Sand.					
63.00	142.00	BASALT Dark green basalt - possible iron thoeliite, however there are occasional felsic clasts up to 5 to 8 cm (yellow cream colour) with quartz eyes - pumaceous ? clasts like hole MAP-1 & 2 which may be magnesium thoeliite. Up to 35% fragments starting around 129 m to bottom of hole. Core angles at 35 degrees to core axis to 70m, then increase to 45 degrees for the rest of the hole. Dark green chloirctic, broken and blocky ground - faults at 62.0 to 65m, 71.3 to 71.5m, 72.0 to 76m, 80.0 to 82.8m. Occasional 0.5cm quartz calcite veinlets at 45 degrees to core					

From (m)	To (m)	Geology	Sample	From (m)	To (m)	Lngt (m)	AU PPM
		axis cutting schisosity.					
	84.00 85.00	Bleached cream coloured section with quartz eyes like a large fragment.					
	93.50	Pyrite cubes in dark green chlorite phase.					
	112.90 113.50	Bull white quartz vein at 35 degrees to core axis with fragments of chlorite. Occasional dark green chlorite shears.					
	142.00	END OF HOLE.					



Date: 19 Mar, 2000

MAPLE MINERALS INC.

Page: 1 of 2

Northing: -1225.00
 Easting: 10900.00
 Elevation: 1000.00

DRILL HOLE RECORD

Drill Hole: MAP-00-4

Collar Azi.: 320.0
 Collar Dip: -55.0

*** Dip Tests ***
 Depth Azi. Dip

Claim: P-1218058
 Township: Sheraton Township
 Core Size: NQ
 Stored at: Timmins
 Date Started: 9 Feb 2000
 Date Finished: 10 Feb 2000

Hole Length: 77.00

Property: Maple Minerals
 Date Logged: 11 Feb 2000
 Drilled by: Norex Drilling Ltd.
 Logged by: R.S. Middleton
 Materials left: None
 Purpose: To test IP anomaly and regional stratigraphy.
 Field Co-ords:

R. Middleton
Peng

From (m)	To (m)	Geology	Sample	From (m)	To (m)	Lngt (m)	AU PPM
.00	57.00	OVERBURDEN					
57.00	63.50	MAFIC TUFF - ASH Very fine grained, moderately foliated, medium green, weakly to moderately calcitic. Shearing at 0 to 15 degrees to core axis.					
63.50	77.00	QUARTZ - CALCITE - TOURMALINE ZONE Zone consisting of 5 to 25% clastic quartz veins. Veins are generally ragged and deformed and are subparallel of core axis. There is some sericite and chlorite alteration associated with the veining. Pyrite content is variable but averages 3 to 5% overall. The only significant tourmaline is from 68 to 68.5. And 0.5% moly at 64m. 63.50 65.00 20% quartz calcite, grey in places due to fine moly. 5-8% pyrite.	38996	63.50	65.00	1.50	780.0
			38997	65.00	66.50	1.50	5.0
			38998	66.50	68.00	1.50	15.0
			36946	68.00	69.00	1.00	<5.0
			36947	69.00	70.00	1.00	<5.0
			36948	70.00	71.00	1.00	75.0
			36949	71.00	72.50	1.50	5.0
			36950	72.50	74.00	1.50	<5.0

From (m)	To (m)	Geology	Sample	From (m)	To (m)	Lngt (m)	AU PPM
	65.00	66.50 Sheared, chlorite, broken with 10% lost core. 2% pyrite.	2348	74.00	75.70	1.70	<5.0
			2338	75.70	77.00	1.30	<5.0
	66.50	68.00 Sheared, chloritic, vuggy with 3-5% pyrite.					
	68.00	69.00 Sheared, deformed 20% quartz calcite.					
	69.00	70.00 10 to 15% quartz calcite, highly deformed. 2% pyrite.					
	70.00	71.00 Some broken core, 20% lost core. 2% pyrite.					
	71.00	72.50 Moderately sheared, 10% quartz calcite veining. 2% pyrite.					
	72.50	74.00 Moderately sheared, 10% quartz calcite veining. 2% pyrite.					
	74.00	75.70 20% quartz calcite veining with 5 to 7% fine grained disseminated pyrite.					
	75.70	77.00 Less sheared and only 5% veining. 1% disseminated pyrite.					
	77.00	END OF HOLE.					

Date: 19 Mar, 2000

MAPLE MINERALS INC.

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Northing: 1000.00
 Easting: 10850.00
 Elevation: 1000.00

DRILL HOLE RECORD

Drill Hole: MAP-00-5

*** Dip Tests ***
 Depth Azi. Dip

Claim: P-1218058
 Township: Sheraton Township
 Core Size: NQ
 Stored at: Timmins
 Date Started: 11 Feb. 2000
 Date Finished: 12 Feb. 2000

Collar Azi.: 160.0
 Collar Dip: -50.0

Hole Length: 230.00

Property: Maple Minerals
 Date Logged: 13 Feb. 2000
 Drilled by: Norex Drilling Ltd.
 Logged by: R.S. Middleton
 Materials left: None
 Purpose: To test IP anomaly
 Field Co-ords:

R. Middleton
 P. Eng

From (m)	To (m)	Geology	Sample	From (m)	To (m)	Lngt (m)	AU PPM
.00	81.00	OVERBURDEN					
81.00	86.00	MAFIC TUFF - LAPILLI CRYSTALL TUFF Chloritized lapilli or crystall tuff. Primarily small broken pieces of core and mud. Foliation at 20 to 30 degrees to core axis where visible. Core recovery at 50 %.					
86.00	104.50	FELDSPAR PORPHYRY CRYSTALL TUFF Entire interval has been subjected to surface weathering fracturing and leaching, Core recovery 75%. Some 0.5 to 1.5 meter intervals of more chloritic, sheared material (sheared porphyry or tuff). 87.00 87.80 More chloritic. 88.80 89.90 Chloritic, limonitic mud. 89.90 89.50 Better core recovery - looks like porphyry.					


From (m)	To (m)	Geology	Sample	From (m)	To (m)	Lngr (m)	AU PPM
		96.00 98.00 Quite chloritic, sheared, some darker chlorite that in places pseudomorphs pre existing mineral. 102.30 102.40 Strong pink alteration - possible narrow dike.					
104.50	211.30	FELDSPAR PORPHYRY CRYSTALL TUFF Medium to light green grey, weakly to moderately foliated. Feldspar are frequently pink altered. Occasional fragmental intervals or bleached lozenges. Foliation at 20 to 30 degrees to core axis. 135.00 135.80 Occasional quartz calcite epidote veining with black tourmaline. 150.00 168.00 Less pink alteration. 160.00 5 cm of quartz calcite tourmaline. 137.00 200.00 Minor calcite fractures at nearly 90 degrees to core axis. 177.50 195.00 Occasional bleached fragments (lapilli to bomb sized) of similar composition. In places fragments vs fragmentation is difficult to distinguish. 194.50 195.20 10 to 20% irregular quartz tourmaline calcite veining - deformed with 2% disseminated cubic pyrite. No significant alteration.	38995	194.50	195.20	.70	85.0
211.30	213.20	MAFIC DIKE Fine grained, massive dike.					
213.20	230.00	CRYSTALL TUFF Quite bleached, occasionally epidote altered. Feldspar orange stained, weakly crenulated. Becoming more sheared and calcitic from 226.0m. 230.00 END OF HOLE.					



Declaration of Assessment Work Performed on Mining Land

Mining Act, Subsection 65(2) and 66(3), R.S.O. 1990

Transaction Number (office use) WDO 60.00174
Assessment Files Research Imaging

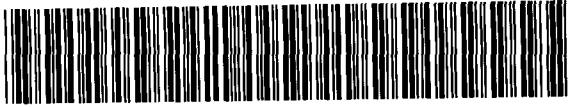

42A07NW2016 2.20237 SHERATON 900

Subsections 65(2) and 66(3) of the Mining Act. Under section 8 of the Mining Act, this document work and correspond with the mining land holder. Questions about this collection should be directed to the Ministry of Northern Development and Mines, 3rd Floor, 933 Ramsey Lake Road, Sudbury, Ontario, P3E 6B5.

Instructions: - For work performed on Crown Lands before recording a claim, use form 0240. - Please type or print in ink.

1. Recorded holder(s) (Attach a list if necessary)

Form with fields for Name, Address, Client Number, Telephone Number, and Fax Number. Includes handwritten entry for MAPLE MINERALS INC.

2. Type of work performed: Check (✓) and report on only ONE of the following groups for this declaration.

Geotechnical: prospecting, surveys, assays and work under section 18 (regs) []
Physical: drilling stripping, trenching and associated assays [x]
Rehabilitation []

Form with fields for Work Type (Diamond Drilling, logging, assaying), Office Use, Commodity, Total \$ Value of Work Claimed (40,840), Dates Work Performed, NTS Reference, Mining Division, Resident Geologist, and District.

Please remember to: - obtain a work permit from the Ministry of Natural Resources as required; - provide proper notice to surface rights holders before starting work; - complete and attach a Statement of Costs, form 0212; - provide a map showing contiguous mining lands that are linked for assigning work; - include two copies of your technical report.

3. Person or companies who prepared the technical report (Attach a list if necessary)

Form with fields for Name, Address, Telephone Number, and Fax Number. Includes handwritten entry for Robert S. Middleton P.Eng and a RECEIVED stamp from the GEOSCIENCE ASSESSMENT OFFICE dated APR 14 2000.

4. Certification by Recorded Holder or Agent

I, Robert S. Middleton, do hereby certify that I have personal knowledge of the facts set forth in this Declaration of Assessment Work having caused the work to be performed or witnessed the same during or after its completion and, to the best of my knowledge, the annexed report is true.

Form with fields for Signature of Recorded Holder or Agent, Date (April 3, 2000), Agent's Address, Telephone Number, and Fax Number.

5. Work to be recorded and distributed. Work can only be assigned to claims that are contiguous (adjoining) to the mining land where work was performed, at the time work was performed. A map showing the contiguous link must accompany this form.

Mining Claim Number. Or if work was done on other eligible mining land, show in this column the location number indicated on the claim map.	Number of Claim Units. For other mining land, list hectares.	Value of work performed on this claim or other mining land.	Value of work applied to this claim.	Value of work assigned to other mining claims.	Bank. Value of work to be distributed at a future date
eg TB 7827	16 ha	\$26,825	N/A	\$24,000	\$2,825
eg 1234567	12	0	\$24,000	0	0
eg 1234568	2	\$ 8,892	\$ 4,000	0	\$4,892
1 1218062	16			6400	
2 1218063	16	22326.28	-		1263.73
3 1223577	16			4342	
4 1218061	12			4800	
5 1218058	8	18574.45	3235	3235	
6 1218059	4			1600	
7 1218060	16			6400	
8 1223578	16			6400	
9 1223579	16			6400	
10					
11					
12					
13					
14					
15					
Column Totals		40840.73		39577	1263.73

I, Robert S. Middleton P.Eng (Print Full Name), do hereby certify that the above work credits are eligible under subsection 7 (1) of the Assessment Work Regulation 6/96 for assignment to contiguous claims or for application to the claim where the work was done.

Signature of Recorded Holder or Agent Authorized in Writing: R. Middleton Date: April 3, 2000

6. Instructions for cutting back credits that are not approved.


Some of the credits claimed in this declaration may be cut back. Please check (✓) in the boxes below to show how you wish to prioritize the deletion of credits:

- 1. Credits are to be cut back from the Bank first, followed by option 2 or 3 or 4 as indicated.
- 2. Credits are to be cut back starting with the claims listed last, working backwards; or
- 3. Credits are to be cut back equally over all claims listed in this declaration; or
- 4. Credits are to be cut back as prioritized on the attached appendix or as follows (describe):

Note: If you have not indicated how your credits are to be deleted, credits will be cut back from the Bank first, followed by option number 2 if necessary.

For Office Use Only

Received Stamp

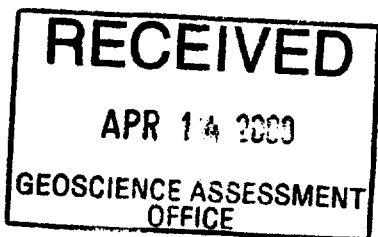

0241 (03/97)

Deemed Approved Date	Date Notification Sent
Date Approved	Total Value of Credit Approved
Approved for Recording by Mining Recorder (Signature)	



Statement of Costs for Assessment Credit

Transaction Number (office use) W0060-00174

Personal information collected on this form is obtained under the authority of subsection 6 (1) of the Assessment Work Regulation 6/96. Under section 8 of the Mining Act, this information is a public record. This information will be used to review the assessment work and correspond with the mining land holder. Questions about this collection should be directed to a Provincial Mining Recorder, Ministry of Northern Development and Mines, 3rd Floor, 933 Ramsey Lake Road, Sudbury, Ontario, P3E 6B5.

Table with 4 columns: Work Type, Units of work, Cost Per Unit of work, Total Cost. Rows include Diamond Drilling (723.6 m, 53.22, 38,512.51), Assays (42-2, 59.28), Logging Splitting Assays (Feb 1-13, 13 days, 268.94, 2000), and Associated Costs.

RECEIVED APR 14 2000 GEOSCIENCE ASSESSMENT OFFICE

Total Value of Assessment Work 40890.73

Calculations of Filing Discounts:

- 1. Work filed within two years of performance is claimed at 100% of the above Total Value of Assessment Work.
2. If work is filed after two years and up to five years after performance, it can only be claimed at 50% of the Total Value of Assessment Work.

TOTAL VALUE OF ASSESSMENT WORK x 0.50 = Total \$ value of worked claimed.

Note:

- Work older than 5 years is not eligible for credit.
- A recorded holder may be required to verify expenditures claimed in this statement of costs within 45 days of a request for verification and/or correction/clarification.

Certification verifying costs:

I, Robert S Middleton, do hereby certify, that the amounts shown are as accurate as may reasonably be determined and the costs were incurred while conducting assessment work on the lands indicated on the accompanying

Declaration of Work form as MAPLE MINERALS INC. I am authorized to make this certification.

(recorded holder, agent, or state company position with signing authority)

Robert S. Middleton PEing Agent

Signature R. Middleton Date April 3/00

Geoscience Assessment Office
933 Ramsey Lake Road
6th Floor
Sudbury, Ontario
P3E 6B5

Telephone: (888) 415-9845
Fax: (877) 670-1555

May 8, 2000

MAPLE MINERALS INC.
THE EXCHANGE TOWER, 130 KING ST. W.
SUITE 2810
TORONTO, ONTARIO
M5X-1A9

Visit our website at:
www.gov.on.ca/MNDM/MINES/LANDS/mlsmnpgc.htm

Dear Sir or Madam:

Submission Number: 2.20237

Status

Subject: Transaction Number(s): W0060.00174 Approval


We have reviewed your Assessment Work submission with the above noted Transaction Number(s). The attached summary page(s) indicate the results of the review. **WE RECOMMEND YOU READ THIS SUMMARY FOR THE DETAILS PERTAINING TO YOUR ASSESSMENT WORK.**

If the status for a transaction is a 45 Day Notice, the summary will outline the reasons for the notice, and any steps you can take to remedy deficiencies. The 90-day deemed approval provision, subsection 6(7) of the Assessment Work Regulation, will no longer be in effect for assessment work which has received a 45 Day Notice. Allowable changes to your credit distribution can be made by contacting the Geoscience Assessment Office within this 45 Day period, otherwise assessment credit will be cut back and distributed as outlined in Section #6 of the Declaration of Assessment work form.

Please note any revisions must be submitted in **DUPLICATE** to the Geoscience Assessment Office, by the response date on the summary.

If you have any questions regarding this correspondence, please contact LUCILLE JEROME by e-mail at lucille.jerome@ndm.gov.on.ca or by telephone at (705) 670-5858.

Yours sincerely,

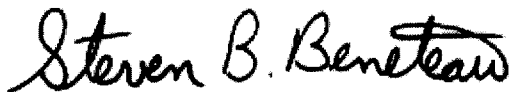

ORIGINAL SIGNED BY
Steve B. Beneteau
Acting Supervisor, Geoscience Assessment Office
Mining Lands Section

Work Report Assessment Results

Submission Number: 2.20237

Date Correspondence Sent: May 08, 2000

Assessor: LUCILLE JEROME

Transaction Number	First Claim Number	Township(s) / Area(s)	Status	Approval Date
W0060.00174	1218063	THOMAS, SHERATON	Approval	May 08, 2000

Section:
16 Drilling PDRILL

Correspondence to:

Resident Geologist
South Porcupine, ON

Assessment Files Library
Sudbury, ON

Recorded Holder(s) and/or Agent(s):

Robert S Middleton
VANCOUVER, BRITISH COLUMBIA, CANADA

MAPLE MINERALS INC.
TORONTO, ONTARIO

MAP SYMBOLOGY

	Pipelng	
	Railroad	
	Single Track	
	Double Track	
	Telegraph	
	Terrace	
	Road	
	Highway, Coach	
	Traverse	
	Scale 1:20,000	
	Horizontal	
	Vertical	
	Diagonal	
	Spot Elevation	
	Contour Interval	
	Lower	
	Transmission Line	
	Power	
	Pylon	
	Tunnel	
	Utility Pole	
	Wharf, Dock, Pier	
	Wooded Area	


AREAS WITHDRAWN FROM DISPOSITION

M.R.O. - MINING RIGHTS ONLY	
S.R.O. - SURFACE RIGHTS ONLY	
M.+S. - MINING AND SURFACE RIGHTS	
Distribution	Date

(R2) - MINING AND SURFACE RIGHTS RE-OPENED UNDER SECTION 35 OF THE MINING ACT, R.S.O. 1990. ORDER NO. C-7-15-197 WSR DATED MAY 18/87. ORDER COMES INTO EFFECT AT 6AM STD TIME, JUNE 1, 1987.

THE INFORMATION THAT APPEARS ON THIS MAP HAS BEEN COMPILED FROM VARIOUS SOURCES AND ACCURACY IS NOT GUARANTEED. THOSE WISHING TO STAKE MINING CLAIMS SHOULD CONSULT WITH THE MINING RECORDER, MINISTRY OF NORTHERN DEVELOPMENT AND MINES FOR ADDITIONAL INFORMATION ON THE STATUS OF THE LANDS SHOWN HEREON.

MACKLEM TWP.

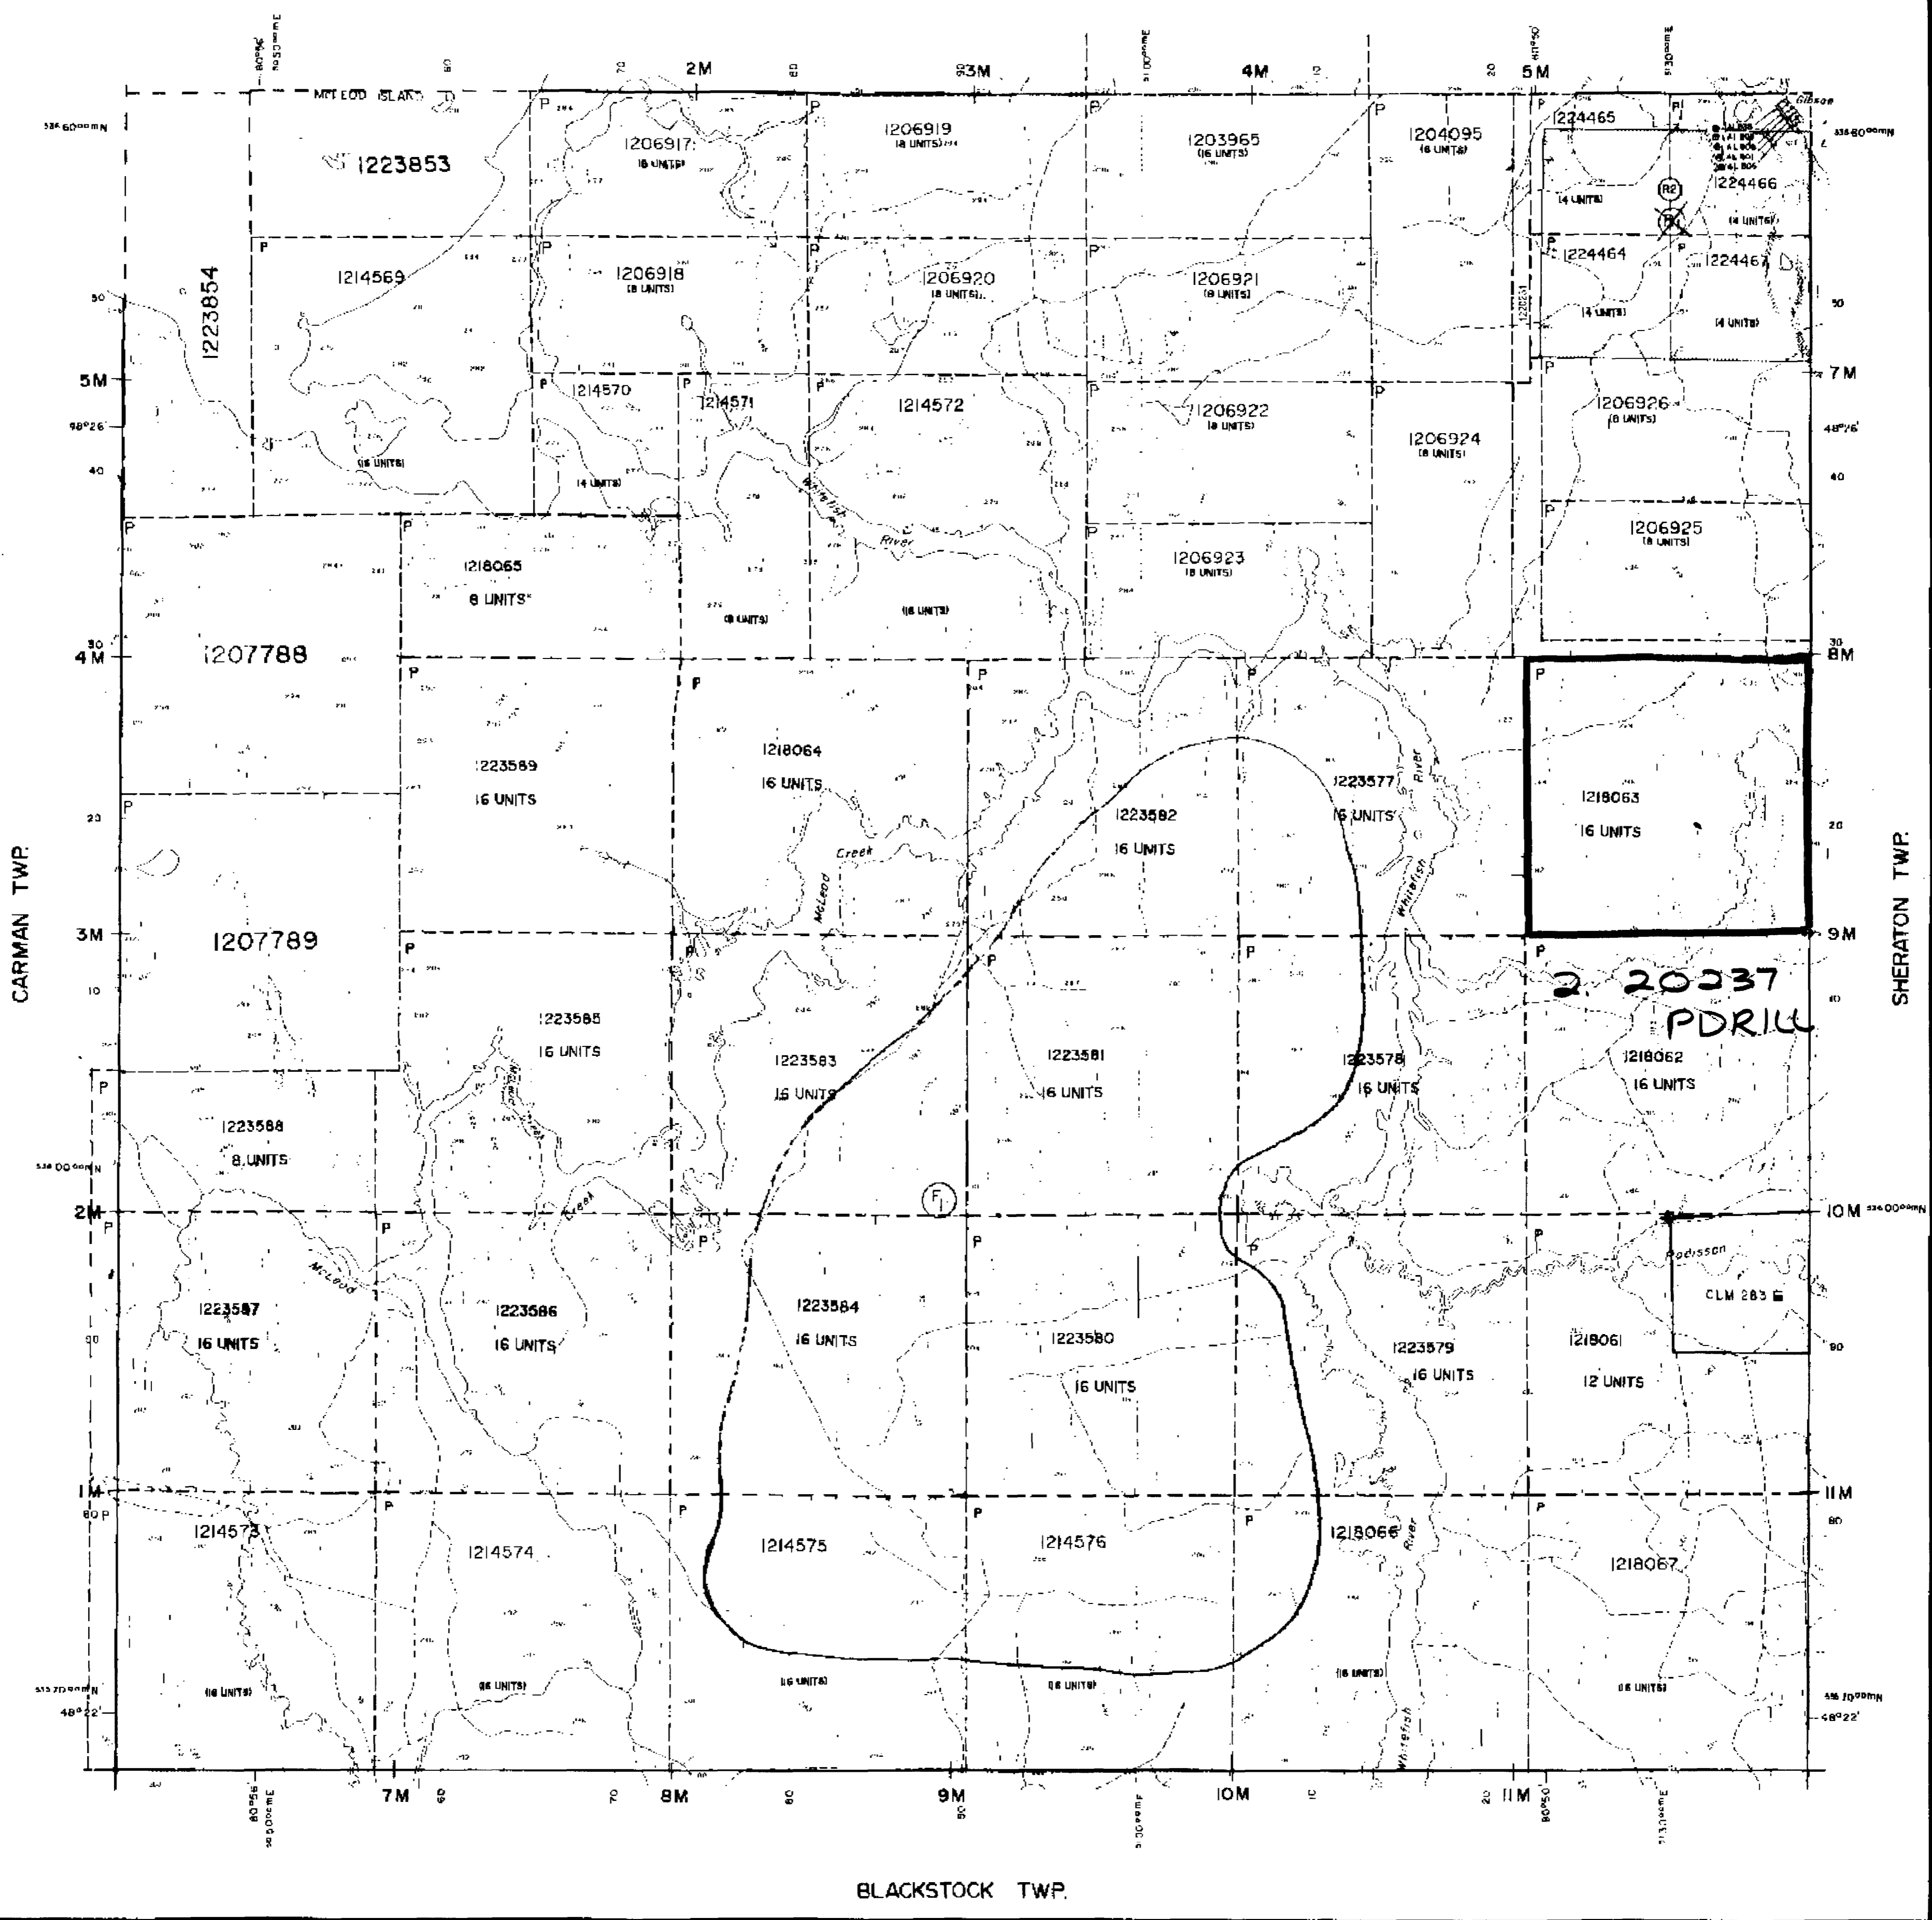

BLACKSTOCK TWP.


LEGEND

HIGHWAY AND ROUTE No.	
OTHER ROADS	
TRAILS	
SURVEYED LINES	
TOWNSHIPS, BASE LINES, ETC.	
LOTS, MINING CLAIMS, PARCELS, ETC.	
UNSURVEYED LINES	
LOT LINES	
PARCEL BOUNDARY	
MINING CLAIMS ETC.	
RAILWAY AND RIGHT OF WAY	
UTILITY LINES	
NON PERENNIAL STREAM	
FLOODING OR FLOODING RIGHTS	
SUBDIVISION OR COMPOSITE PLAN	
RESERVATIONS	
ORIGINAL SHORELINE	
MARSH OR SHINGLE	
MINES	
TRAVERSE MONUMENT	

DISPOSITION OF CROWN LANDS

TYPE OF DOCUMENT	SYMBOL
PATENT, SURFACE & MINING RIGHTS	
SURFACE RIGHTS ONLY	
MINING RIGHTS ONLY	
LEASE, SURFACE & MINING RIGHTS	
SURFACE RIGHTS ONLY	
MINING RIGHTS ONLY	
LICENCE OF OCCUPATION	
ORDER IN COUNCIL	
RESERVATION	
CANCELLED	
SAND & GRAVEL	

NOTE: MINING RIGHTS IN PARCELS PATENTED PRIOR TO MAY 6, 1978, VESTED IN ORIGINAL PATENTEES BY THE PUBLIC LANDS ACT, R.S.O. 1970, CHAP. 380, SEC. 83, SUBSEC. 1.

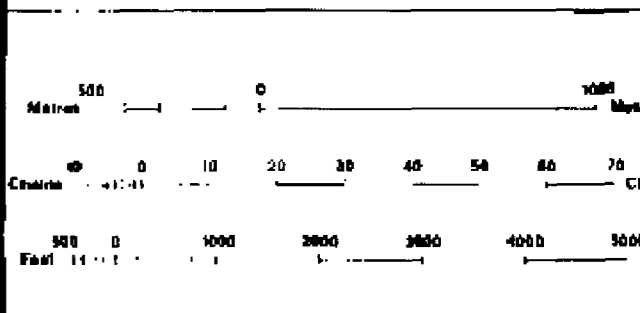


SCALE 1:20 000 GRID ZONE: 17


RESERVE FLOODING RIGHTS TO H.E.P.C. OF ONTARIO TO ELEVATION 803.5 T. B. M.G. RAILWAY DATUM ON NIGHT HAWK LAKE.

(R2) THIS TWP. IS SUBJECT TO FOREST ACTIVITY IN 1995/96. FURTHER INFORMATION AVAILABLE ON FILE.

TOWNSHIP
THOMAS
 M. N. R. ADMINISTRATIVE DISTRICT
TIMMINS
 MINING DIVISION
PORCUPINE
 LAND TITLES / REGISTRY DIVISION
COCHRANE

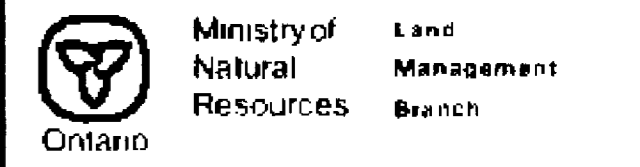

CUSTOMER: G-3977
 DATE: JULY 1984
 REVISIONS: 01/84 BY: B.C.
 CHECKED BY: B.C.
G-3977

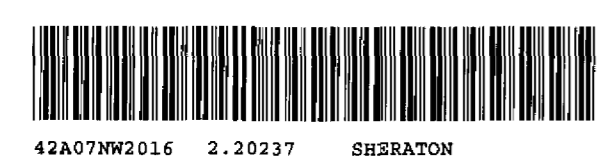

AREAS WITHDRAWN FROM DISPOSITION

- M I O - MINING RIGHTS ONLY
- S R O - SURFACE RIGHTS ONLY
- F I S - MINING AND SURFACE RIGHTS


Description	Order No.	Date	Disposition	File
(R4)	W 66/77	4/8/77	S.R.O.	177189
(R5)	W 66/77	4/8/77	S.R.O.	177189

(R4) - MINING AND SURFACE RIGHTS RE-OPENED UNDER SECTION 35 OF THE MINING ACT R.S.O. 1980 ORDER NO. O-P 43/97 DATED MAY 16/97. ORDER COMES INTO EFFECT AT 8AM STD TIME JUNE 1, 1997.

(R5) - MINING AND SURFACE RIGHTS RE-OPENED UNDER SECTION 35 OF THE MINING ACT R.S.O. 1980 ORDER NO. O-P 16/97 DATED MAY 26/97. ORDER COMES INTO EFFECT AT 8AM STD TIME JUNE 1, 1997.

THE INFORMATION THAT APPEARS ON THIS MAP HAS BEEN COMPILED FROM VARIOUS SOURCES AND ACCURACY IS NOT GUARANTEED. THOSE WISHING TO STAKE MINING CLAIMS SHOULD CONSULT WITH THE MINING RECORDER, MINISTRY OF NORTHERN DEVELOPMENT AND MINES FOR ADDITIONAL INFORMATION ON THE STATUS OF THE LANDS SHOWN HEREON.

BOND TOWNSHIP

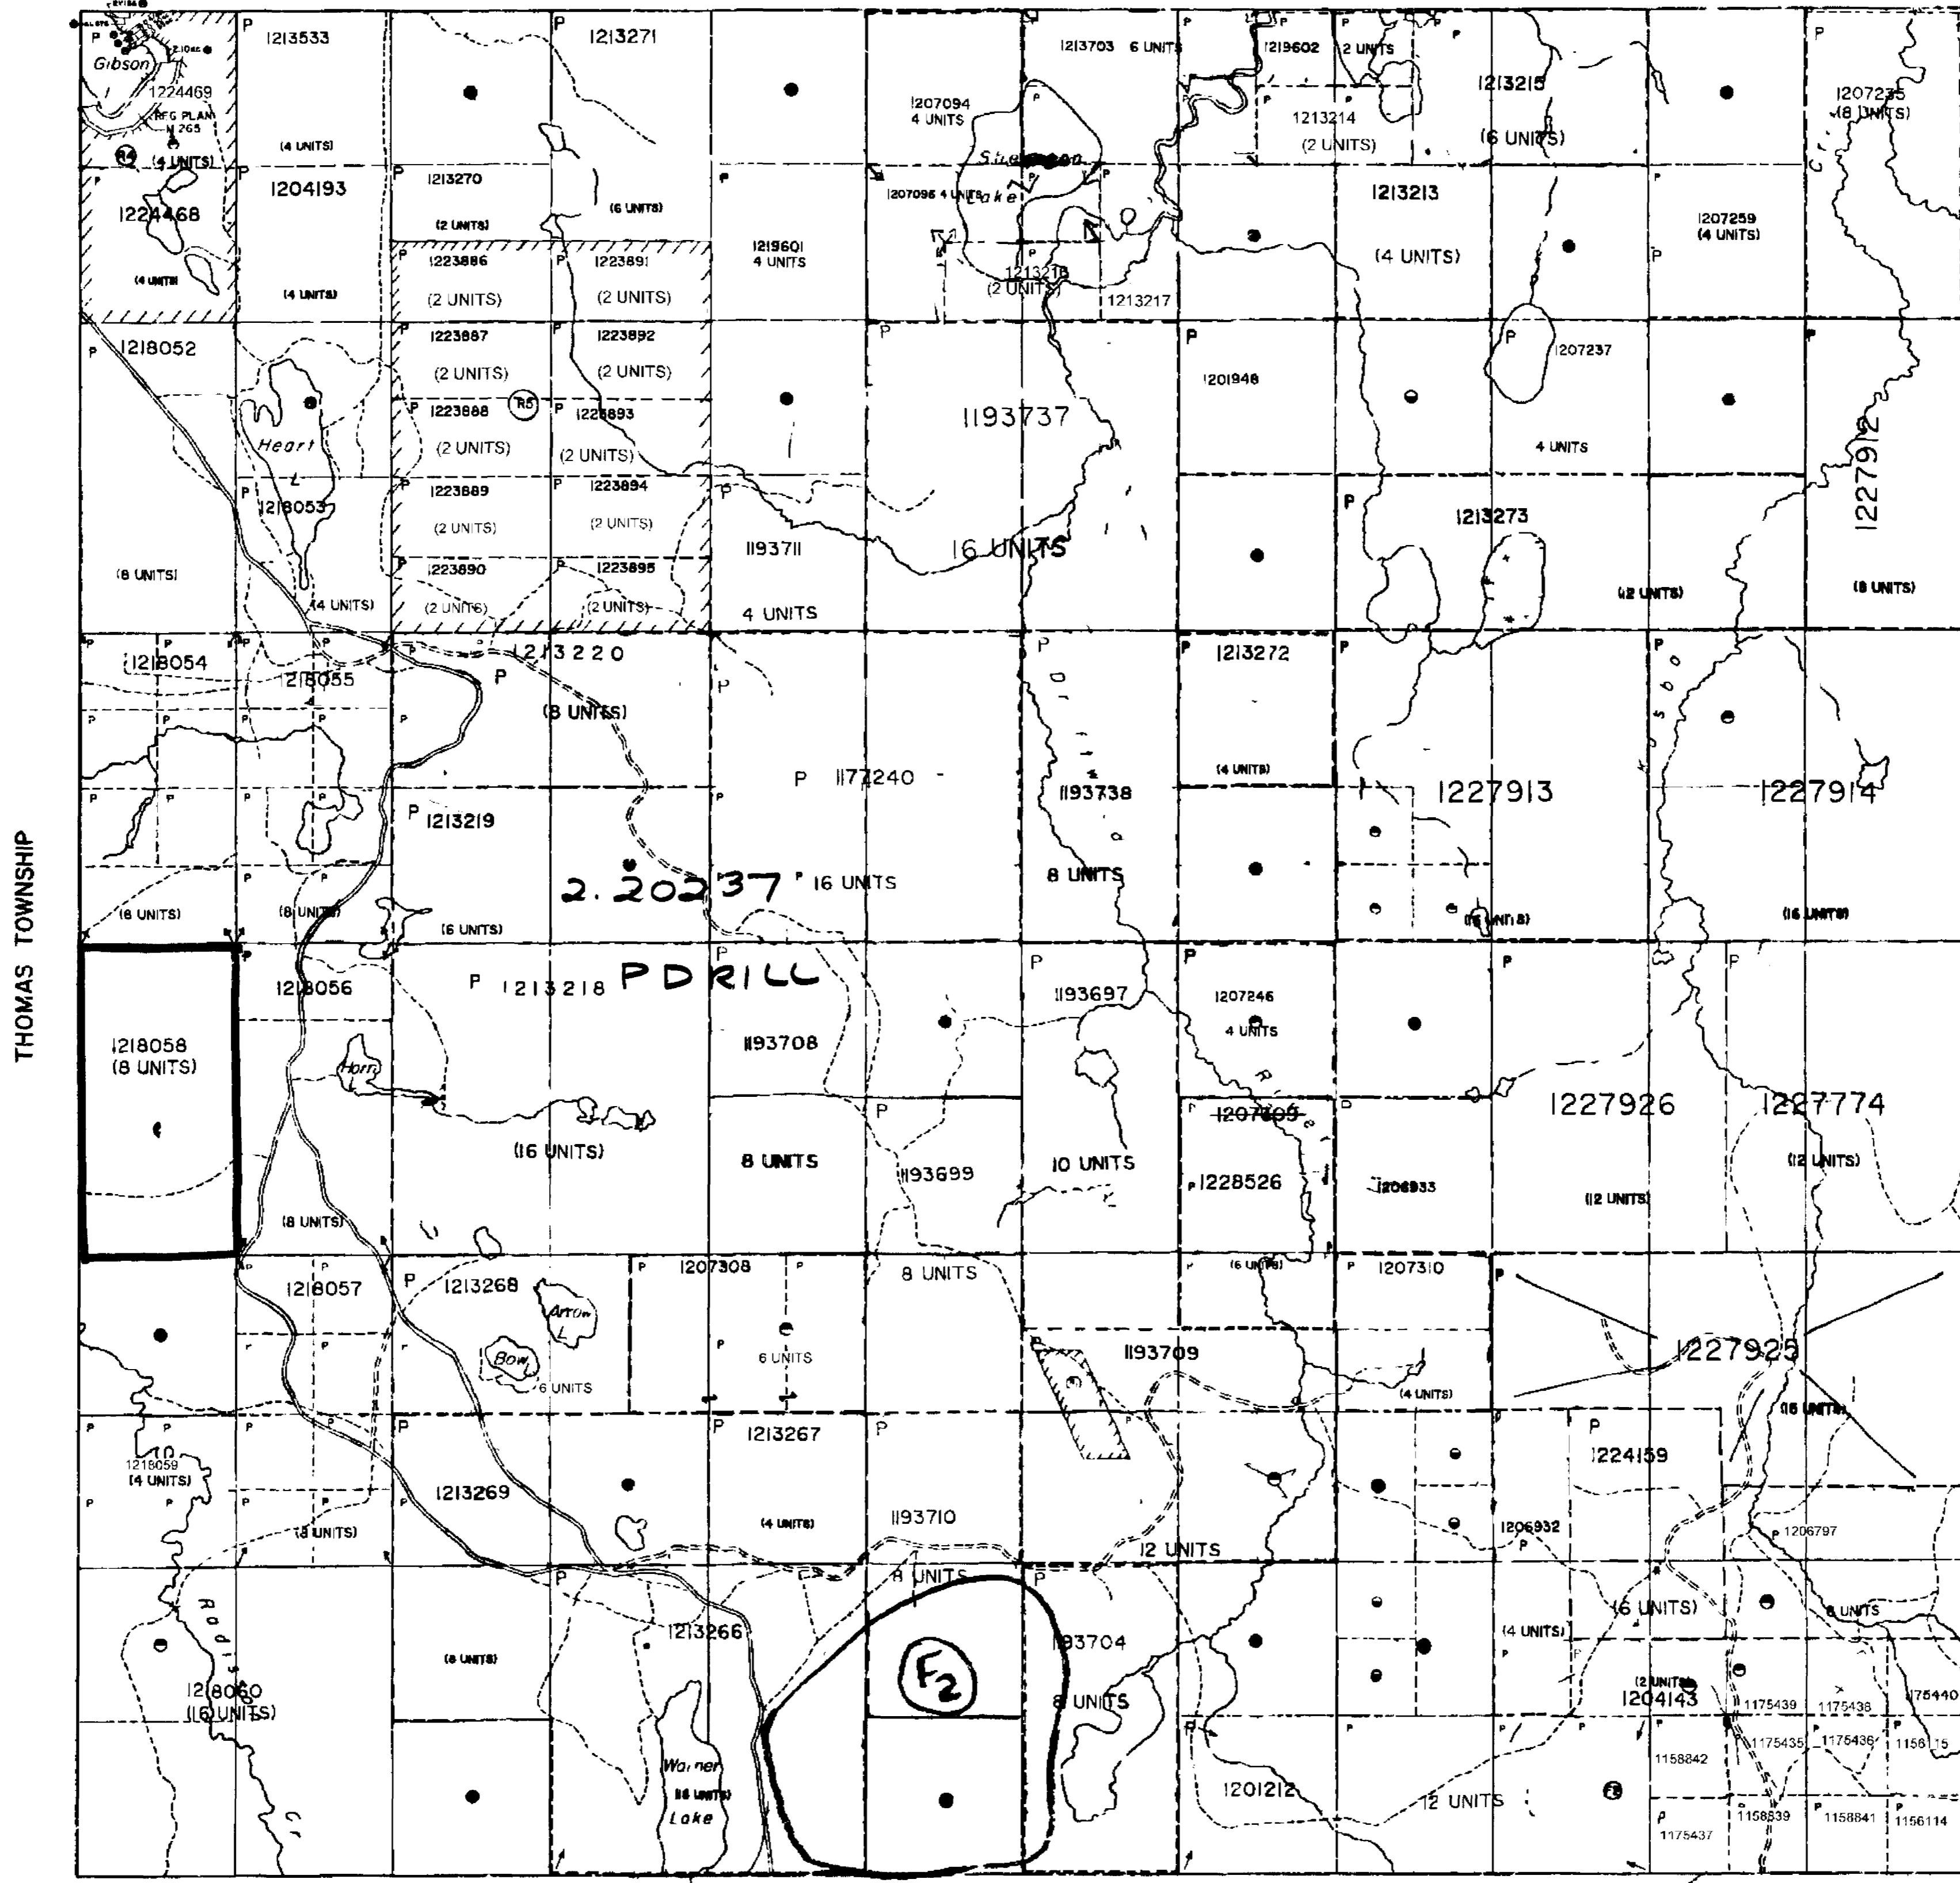


LEGEND

- HIGHWAY AND ROUTE NO.
- OTHER ROADS
- TRAILS
- SURVEYED LINES
- TOWNSHIPS, BASELINES, ETC.
- LOTS, MINING CLAIMS, PARCELS, ETC.
- UNSURVEYED LINES
- LOT LINES
- PARCEL BOUNDARY
- MINING CLAIMS, ETC.
- RAILWAY AND RIGHT OF WAY
- UTILITY LINES
- NON PERENNIAL STREAM
- FLOODING OR FLOODING RIGHTS
- SUBDIVISION OR COMPOSITE PLAN
- RESERVATION
- ORIGINAL SHORELINE
- MARSH OR MUSKEG
- MINES
- TRAVERSE MONUMENT

DISPOSITION OF CROWN LANDS

TYPE OF DOCUMENT	SYMBOL
PATENT, SURFACE & MINING RIGHTS	●
SURFACE RIGHTS ONLY	○
MINING RIGHTS ONLY	○
LEASE, SURFACE & MINING RIGHTS	○
SURFACE RIGHTS ONLY	○
MINING RIGHTS ONLY	○
LICENCE OF OCCUPATION	○
ORDER IN COUNCIL	○
RESERVATION	○
CANCELLED	○
SAND & GRAVEL	○

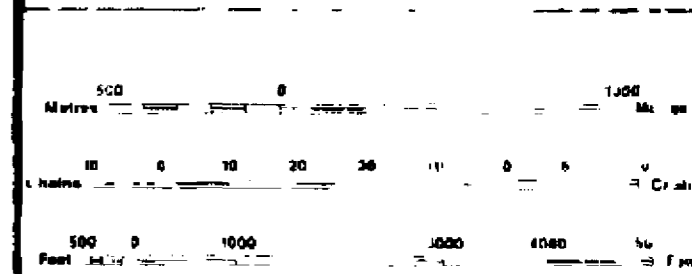

SCALE: 1 : 20,000


NOTES

- ⊗ THIS TWP IS SUBJECT TO FOREST ACTIVITY IN 1986/86. FURTHER INFORMATION AVAILABLE ON FILE.
- ⊗ THIS TWP IS SUBJECT TO FOREST ACTIVITY IN 1986/86. FURTHER INFORMATION AVAILABLE ON FILE.


TOWNSHIP
SHERATON
M.N.R. ADMINISTRATIVE DISTRICT
TIMMINS
MINING DIVISION
PORCUPINE
LAND TITLES/REGISTRY DIVISION
COCHRANE

Ministry of Natural Resources
Ministry of Northern Development and Mines
Ontario

BY AC 04/2016
88
G-3971

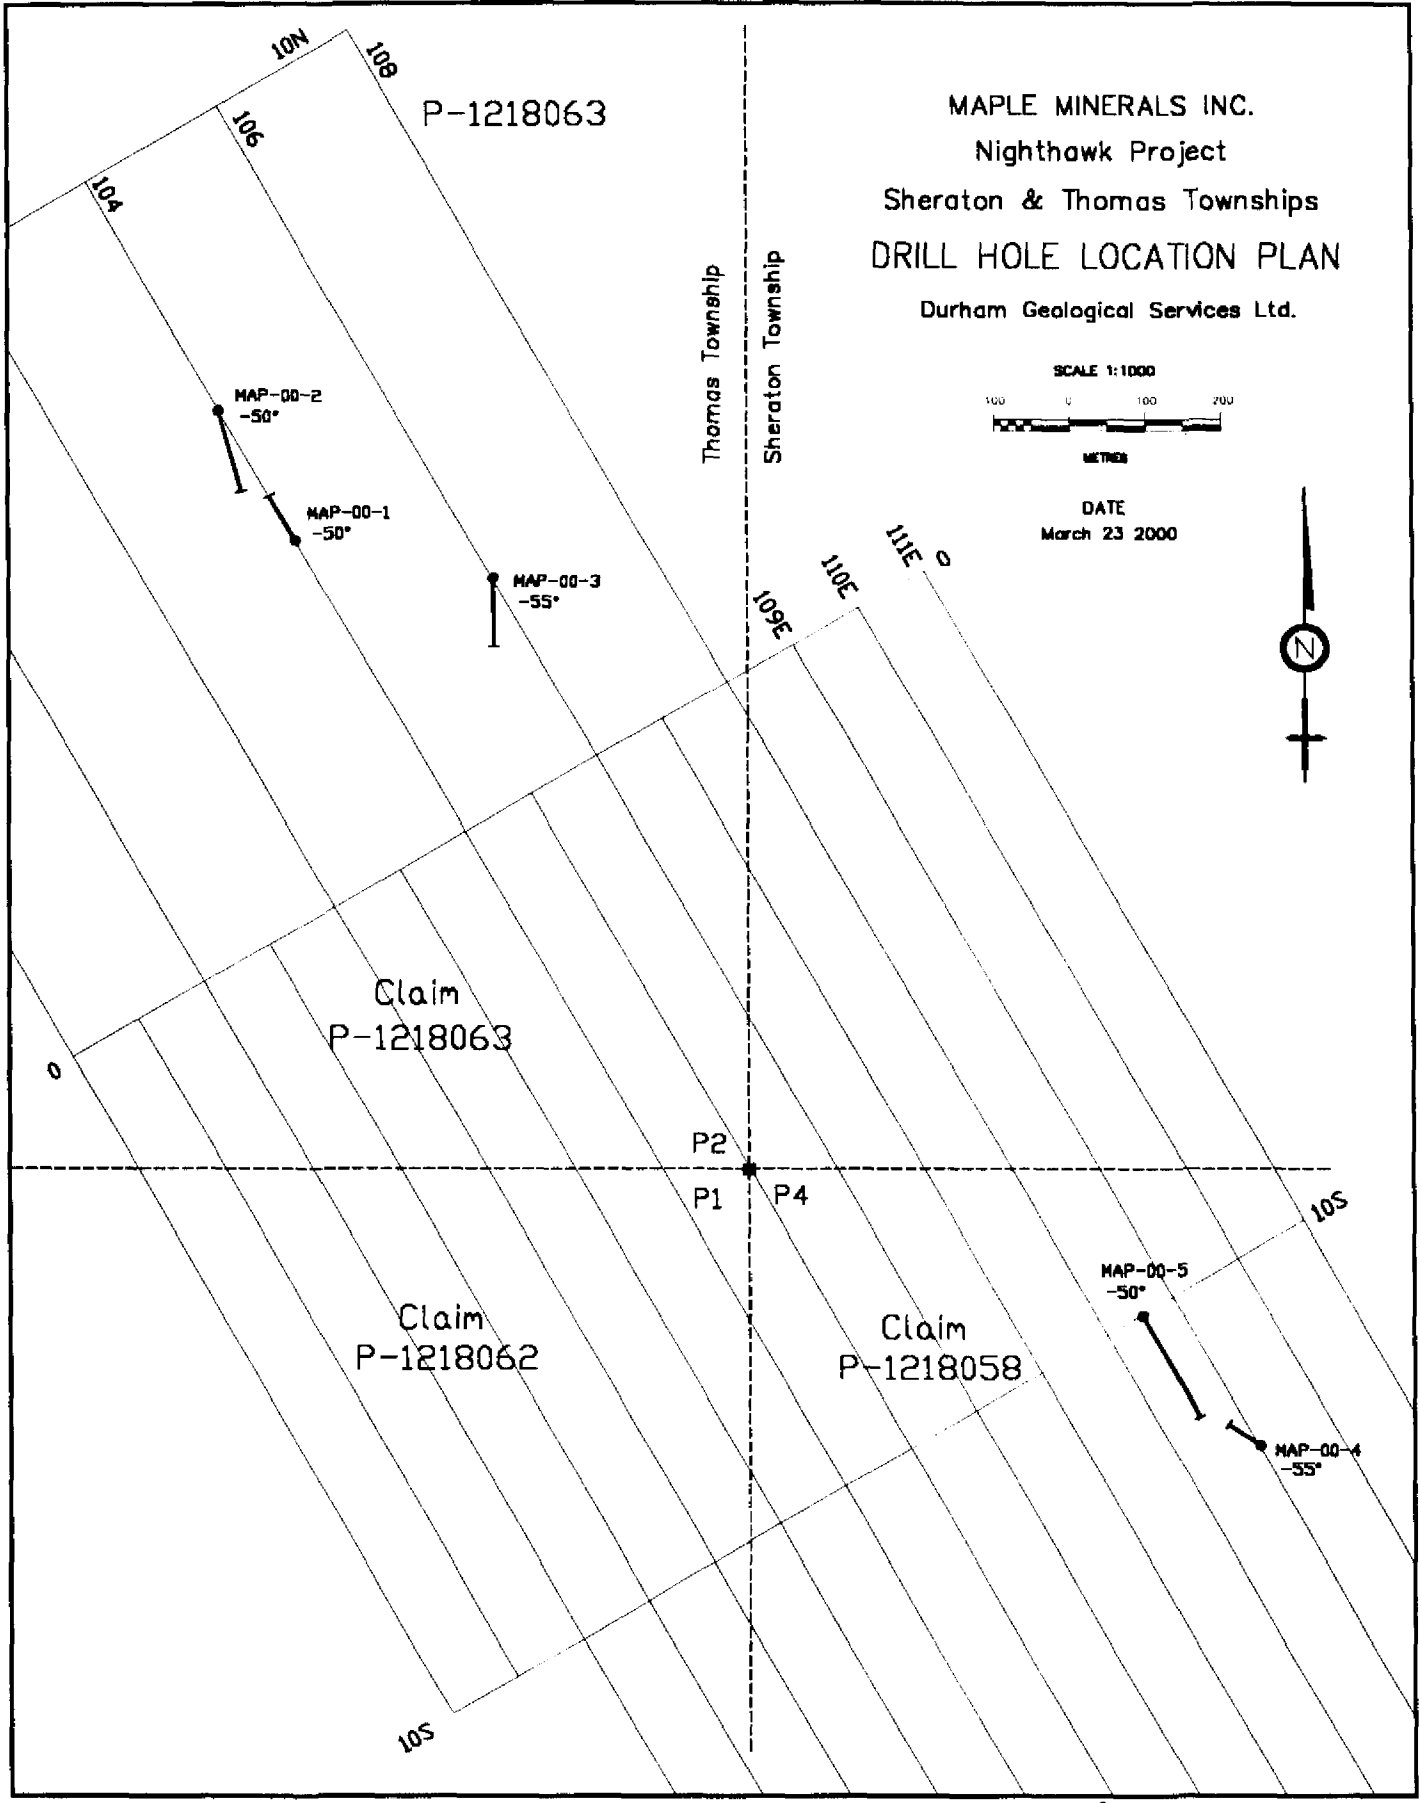


R. Middleton P.Eng.

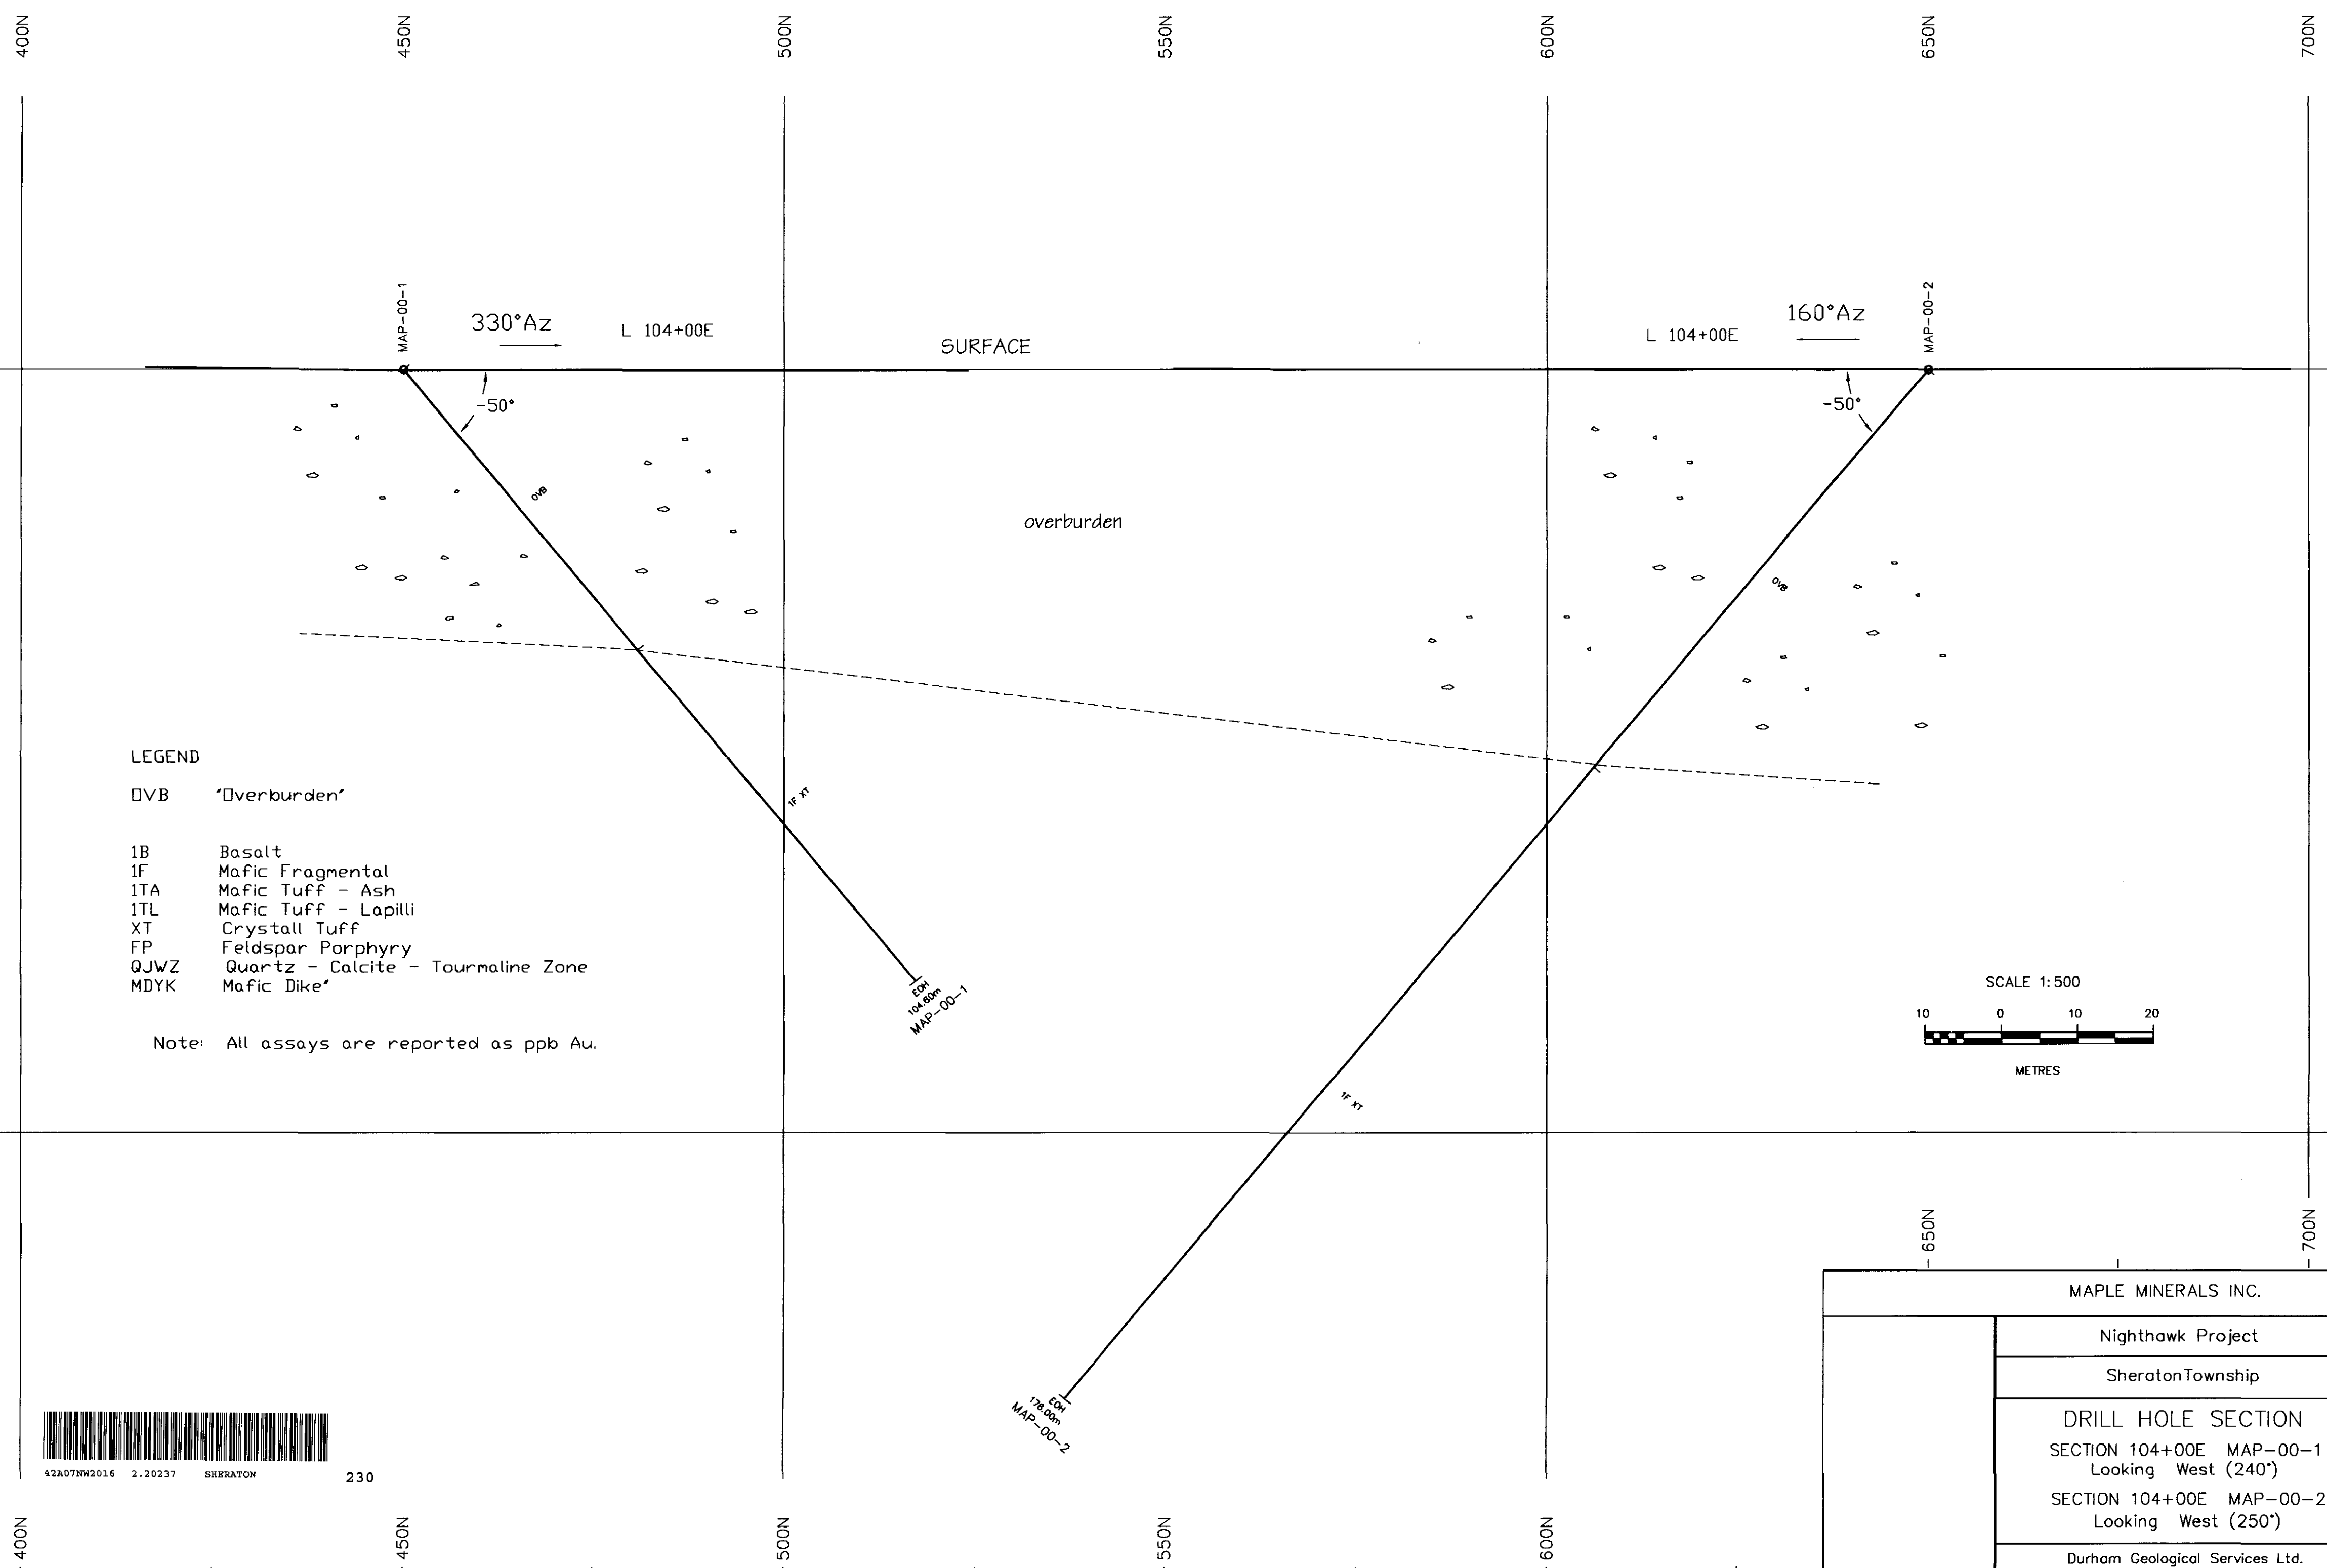

LEGEND

- DVB "Overburden"
- 1B Basalt
- 1F Mafic Fragmental
- 1TA Mafic Tuff - Ash
- 1TL Mafic Tuff - Lapilli
- XT Crystall Tuff
- FP Feldspar Porphyry
- QJWZ Quartz - Calcite - Tourmaline Zone
- MDYK Mafic Dike

Note: All assays are reported as ppb Au.

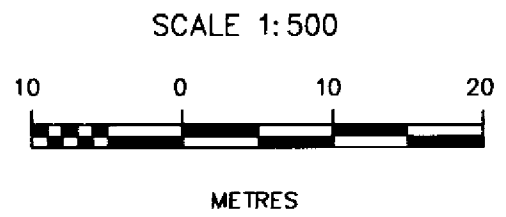

MAPLE MINERALS INC.		
Nighthawk Project	SURVEY BY:	
Sheraton Township	DRAWN BY:	LOG II
DRILL HOLE SECTION		APPROVED BY:
SECTION 104+00E MAP-00-1 Looking West (240°)	Claim No.	1218063
SECTION 104+00E MAP-00-2 Looking West (250°)	DATE	March 23 2000
Durham Geological Services Ltd.		NTS

R. Michton

150N

200N

250N

300N

350N

1000

1000

950

950

900

900

- LEGEND
- OVB "Overburden"
 - 1B Basalt
 - 1F Mafic Fragmental
 - 1TA Mafic Tuff - Ash
 - 1TL Mafic Tuff - Lapilli
 - XT Crystall Tuff
 - FP Feldspar Porphyry
 - QJWZ Quartz - Calcite - Tourmaline Zone
 - MDYK Mafic Dike

Note: All assays are reported as ppb Au.

SURFACE


180°Az

MAP-00-3

L 106+00E

-55°

overburden

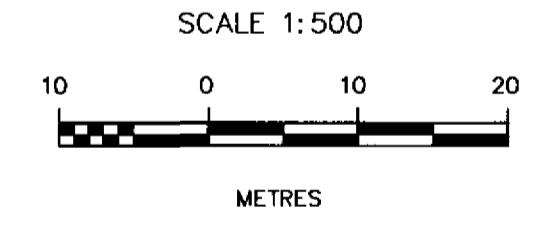

EDH
1+2,00m
MAP-00-3



42A07NW2016 2.20237 SHERATON 240


150N

200N

250N

MAPLE MINERALS INC.		
Nighthawk Project	SURVEY BY:	
Sheraton Township	DRAWN BY:	LOG II
DRILL HOLE SECTION SECTION 106+00E MAP-00-3 Looking Due West		APPROVED BY:
		Claim No. 1218063
		DATE March 23 2000
		NTS
Durham Geological Services Ltd.		


R. Middleton

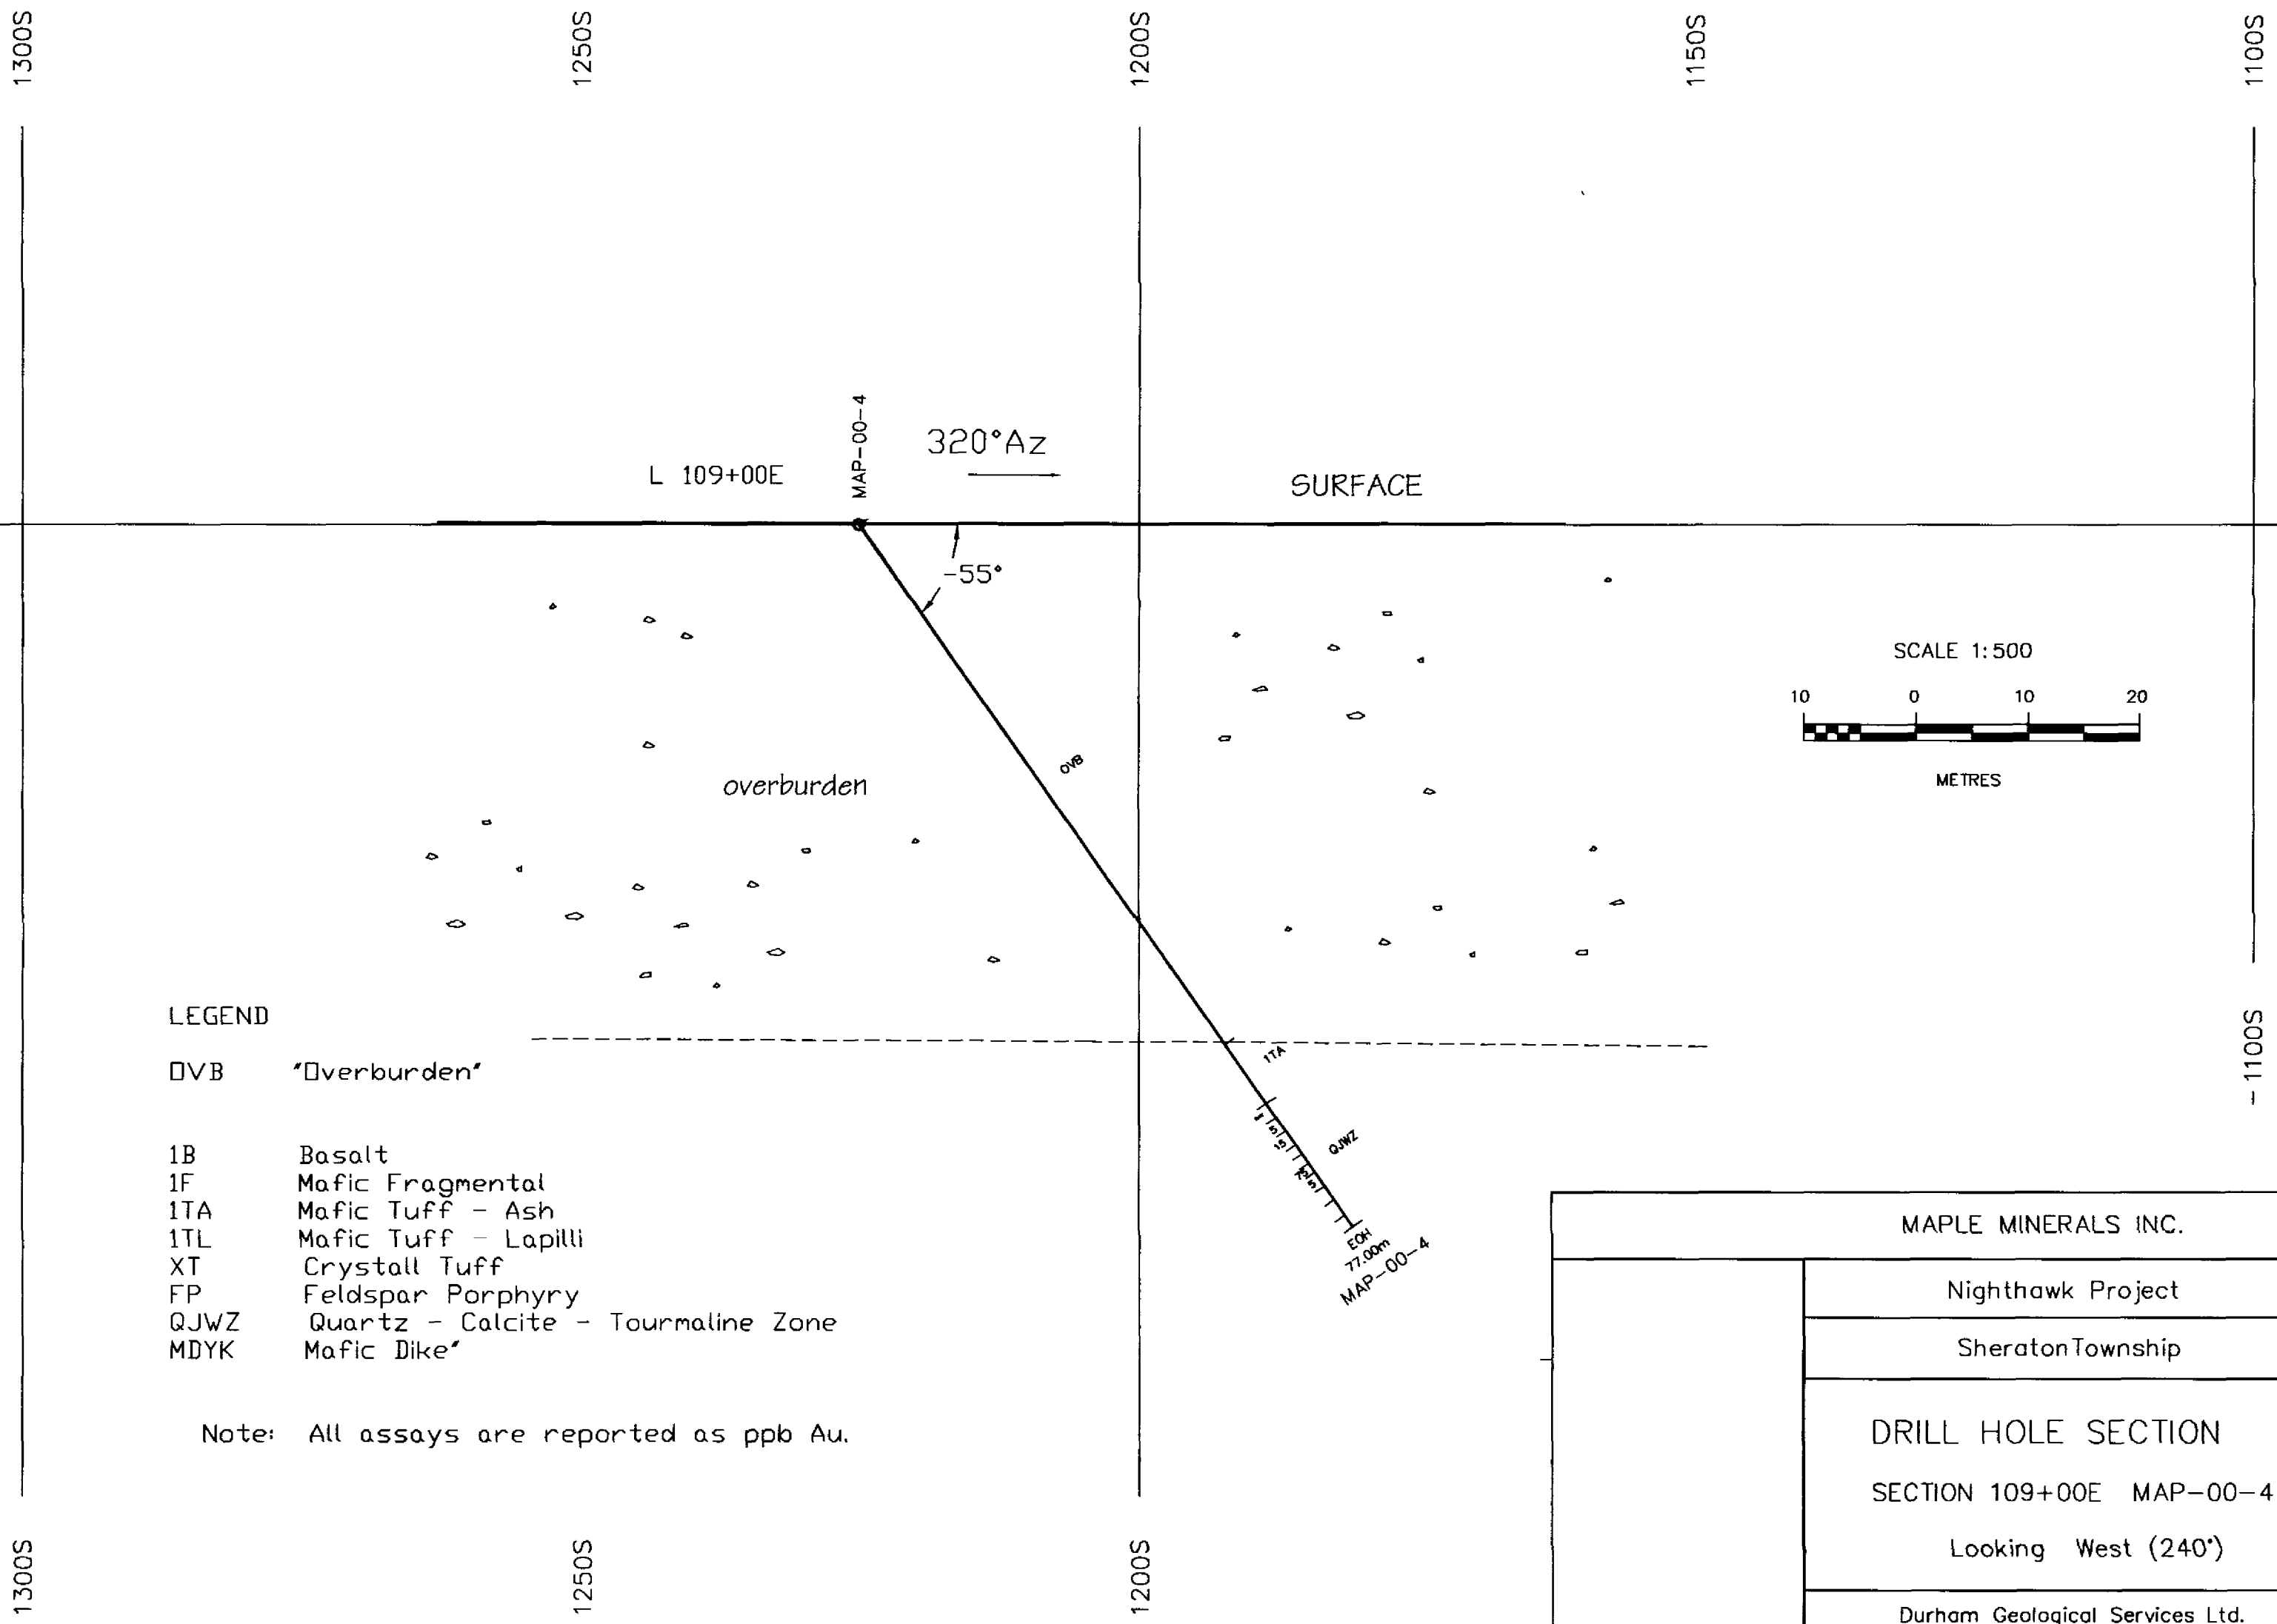

LEGEND

- V B "Overburden"
- 1B Basalt
- 1F Mafic Fragmental
- 1TA Mafic Tuff - Ash
- 1TL Mafic Tuff - Lapilli
- XT Crystall Tuff
- FP Feldspar Porphyry
- QJWZ Quartz - Calcite - Tourmaline Zone
- MDYK Mafic Dike

Note: All assays are reported as ppb Au.

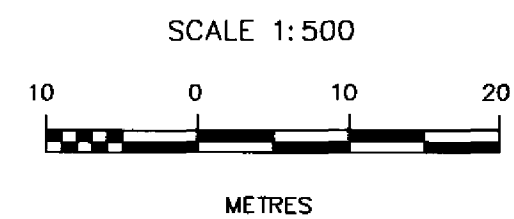

MAPLE MINERALS INC.		
	Nighthawk Project	SURVEY BY:
	Sheraton Township	DRAWN BY: LOG II
	DRILL HOLE SECTION	APPROVED BY:
	SECTION 109+00E MAP-00-4	Claim No. 1218058
	Looking West (240°)	DATE March 23 2000
	Durham Geological Services Ltd.	NTS

R. Madhavan

1150S 1100S 1050S 1000S 950S

1000 1000

950 950

900 900

850 850

LEGEND

- OVB "Overburden"
- 1B Basalt
- 1F Mafic Fragmental
- 1TA Mafic Tuff - Ash
- 1TL Mafic Tuff - Lapilli
- XT Crystall Tuff
- FP Feldspar Porphyry
- QJWZ Quartz - Calcite - Tourmaline Zone
- MDYK Mafic Dike

Note: All assays are reported as ppb Au.

SURFACE

160°Az

-50°

MAP-00-5

L 108+50E

overburden

ovb

1TL XT


FP XT

FP XT

XT

MDYK

169m
230.00m
MAP-00-5

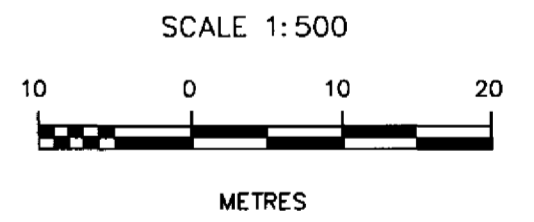

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GEOSCIENCE ASSESSMENT
OFFICE

MAPLE MINERALS INC.

Nighthawk Project

Sheraton Township

DRILL HOLE SECTION

SECTION 108+50E MAP-00-5

Looking West (250')

Durham Geological Services Ltd.

SURVEY BY:

DRAWN BY:
LOG II

APPROVED BY:

Claim No.
1218058

DATE
March 23 2000

NTS



42A07NW2016 2.20237 SHERATON

260

1150S

1100S

1050S

1000S

R. Wichter