



42A15SW0048 2.16313 NEWMARKET

010

**GEOPHYSICAL REPORT
FOR
FALCONBRIDGE LIMITED
ON THE
MANN BELT PROJECT, NEW 95-02
PORCUPINE MINING DIVISION
NORTHEASTERN ONTARIO**

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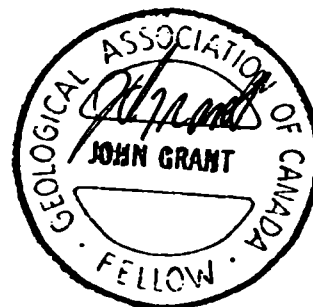
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MINING LANDS BRANCH

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**PREPARED BY: J.C. Grant, CET, FGAC
October, 1995**





42A15SW0048 2.16313 NEWMARKET

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INTRODUCTION

A detailed linecutting and geophysical program was completed by Exsics Exploration Limited for Falconbridge Limited on a group of claims, New 95-02, located in Newmarket Township of the Porcupine Mining Division of Northeastern Ontario. Figure 1

The purpose of this program was to locate and outline several airborne targets which may represent areas of potential base metal deposition. The linecutting portion of the project was completed between September 15 and 25, 1995. The follow up geophysical program was completed between September 26 and 27, 1995. This report will deal with the results of this ground program.

LOCATION AND ACCESS

The New 95-02 grid is located in the south half of Lot 4 and southwest quarter of Lot 3 Concession I of Newmarket Township and extends into the north portions of the same lots of Concession 6 of McCart Township of the Porcupine Division. The entire grid is located approximately 10 kilometers northwest of the Town of Iroquois Falls. Figure 2.


Access to the grid during the survey period was by way of Highway 11, north from Iroquois Falls to the Township line between McCart and Newmarket. An ATV access route was then cut along the township line to the east boundary of the grid, approximately 2.41 kilometers. This route was then used by the linecutting crew as well as the geophysical crew.


CLAIM GROUP


The claim numbers which make up the New 95-02 grid are as follows:

P-1200998	16 units
P-1200968	4 units
P-1200969	12 units

Refer to figure 3, copied from the MNDM Plan maps of Newmarket and McCart Townships which outline that portion of the claims which were covered by the ground program.

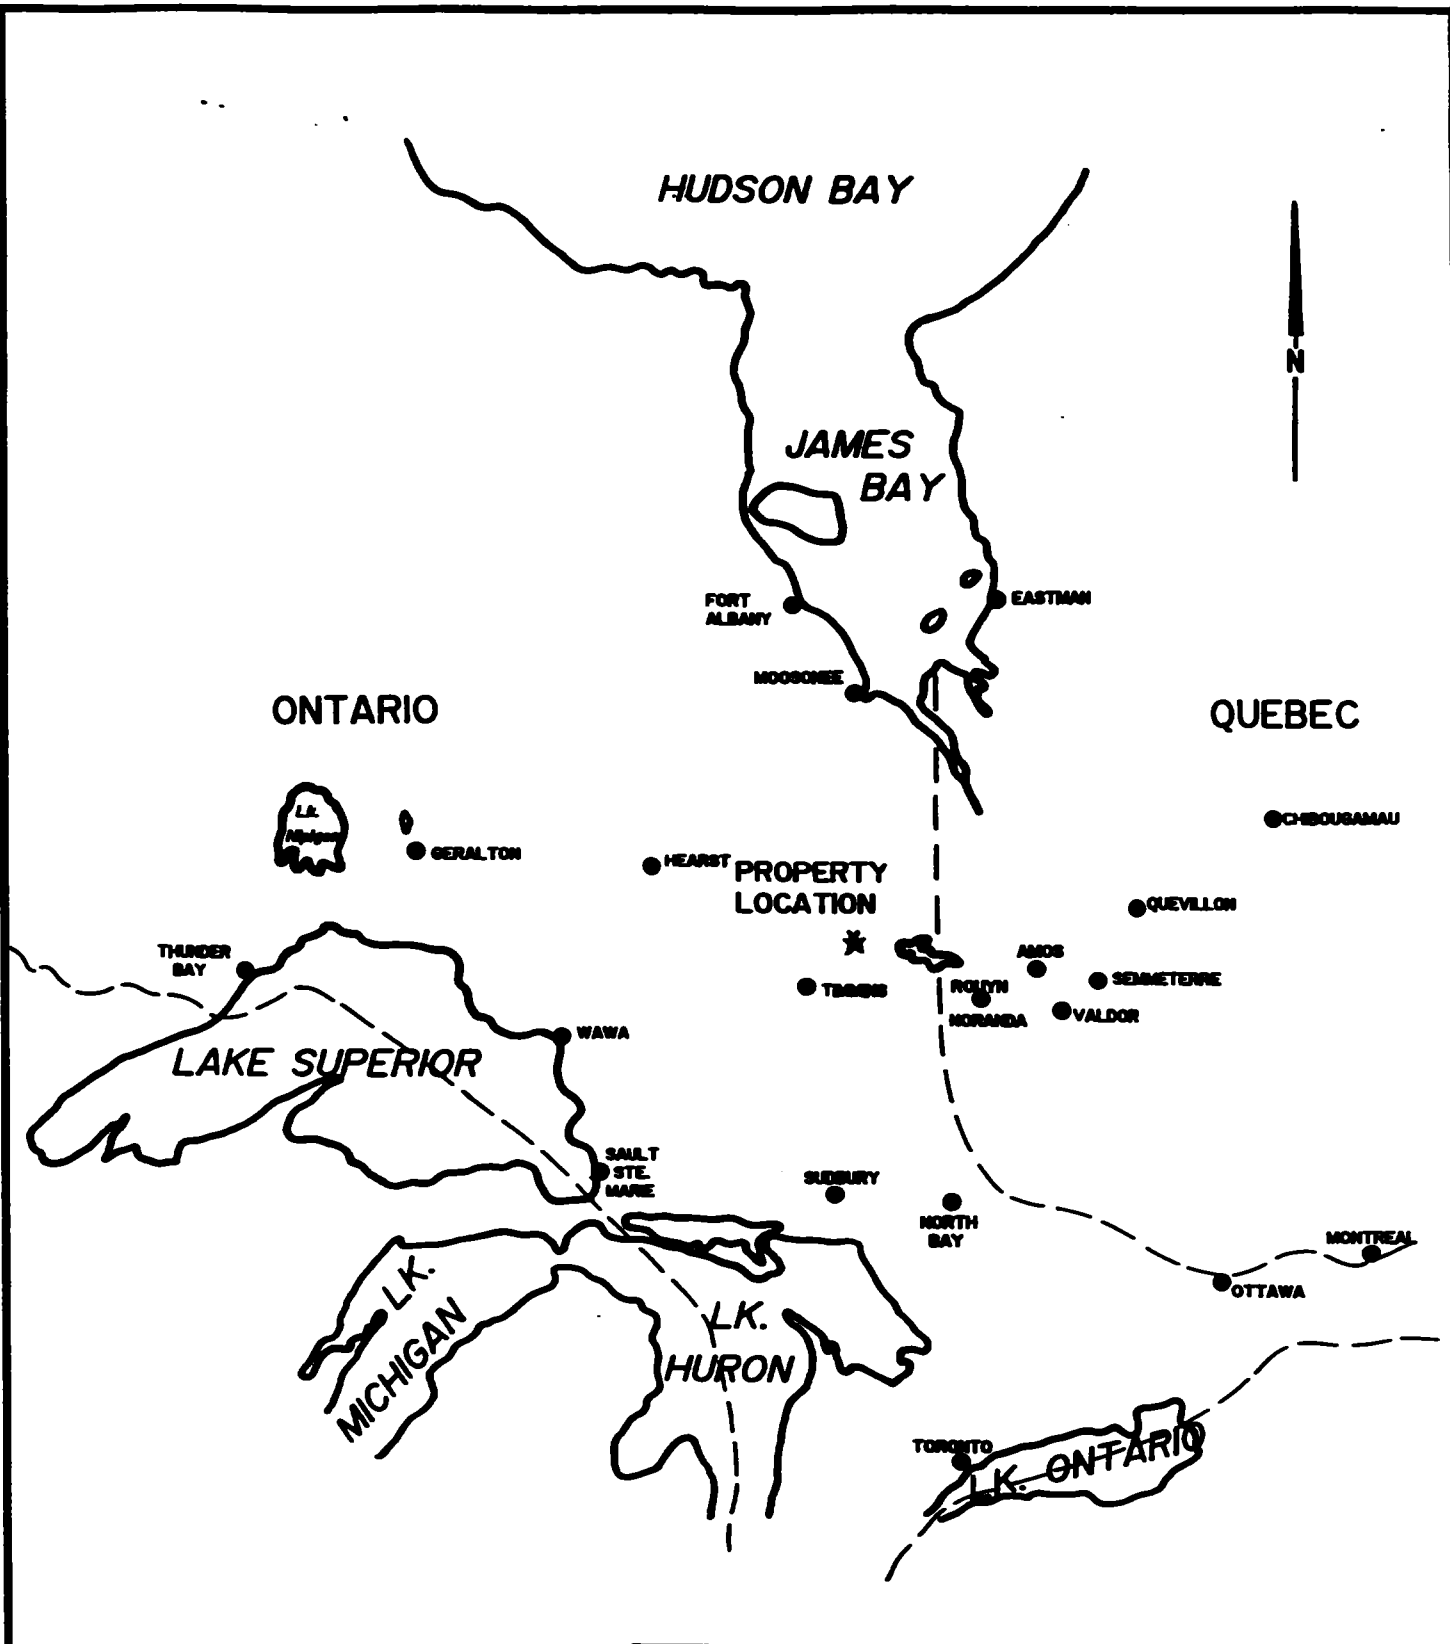


		
EXSICS EXPLORATION LTD. P.O. Box 1888, P4M-7X1 Suite 13, Mullinger Bldg, Timmins Ont. Telephone: 705-267-4151		
CLIENT: FALCONBRIDGE LIMITED		
PROPERTY: MANN BELT PN 8269		
TITLE: NEWMARKET TOWNSHIP LOCATION MAP		
Fig. 1		
Date: Aug. 1995	Scale: 1"=125miles	MNDM Plan#:
Drawn: P. Gauthier	Interp: J.C. Grant	Job No. E-124

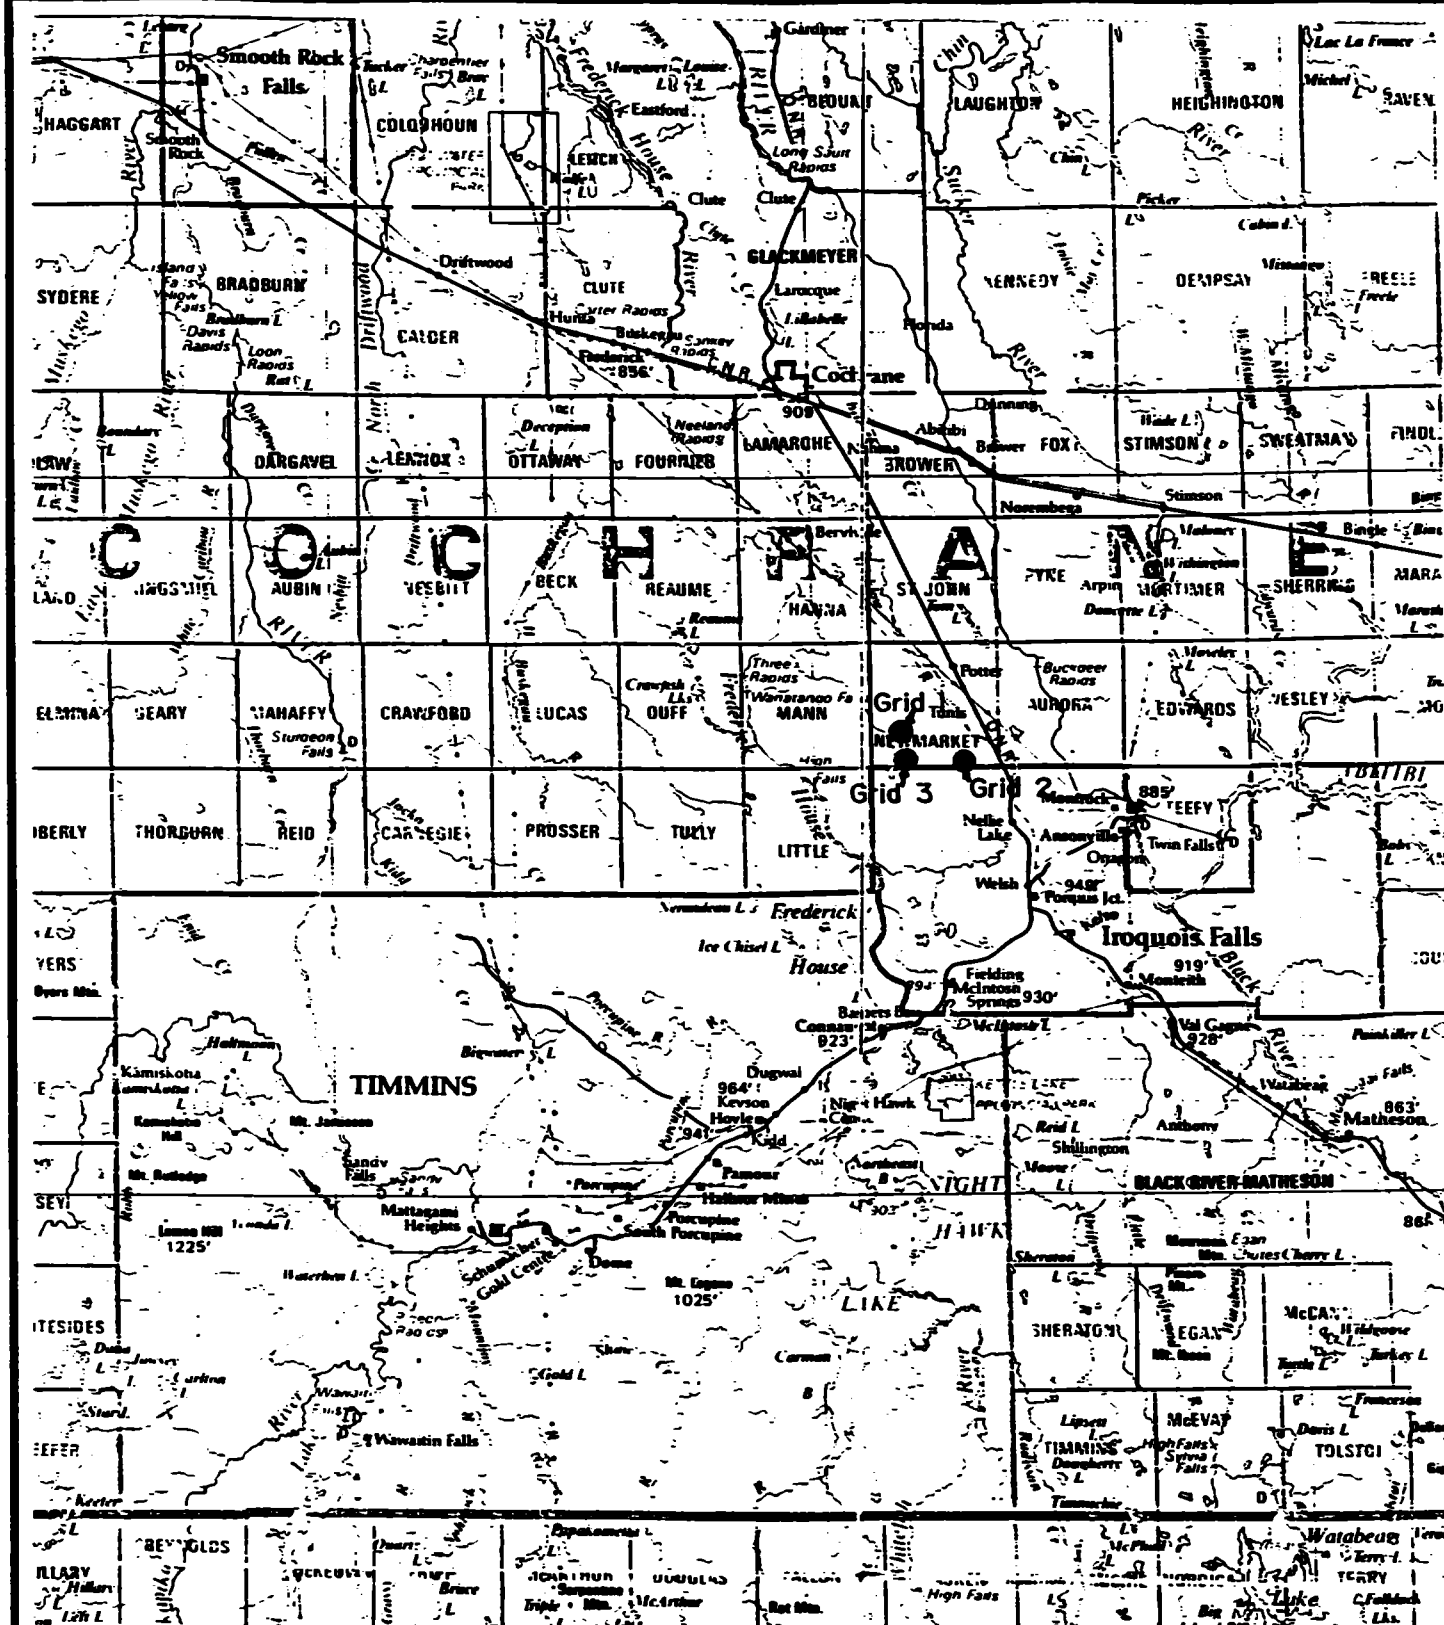

EXSICS EXPLORATION LTD.
 P.O. Box 1000, P4M-7X1
 Suite 13, Halliwell Bldg, Timmins Ont.
 Telephone: 705-267-4151

CLIENT: FALCONBRIDGE LIMITED		
PROPERTY: MANN BELT PN 8269		
TITLE: NEWMARKET TOWNSHIP		
PROPERTY LOCATION Fig. 2		
Date: Aug. 1995	Scale: 1:600,000	MNDM Plan#: 22-6
Drawn:	Interp: J.C. Grant	Job No. E-124

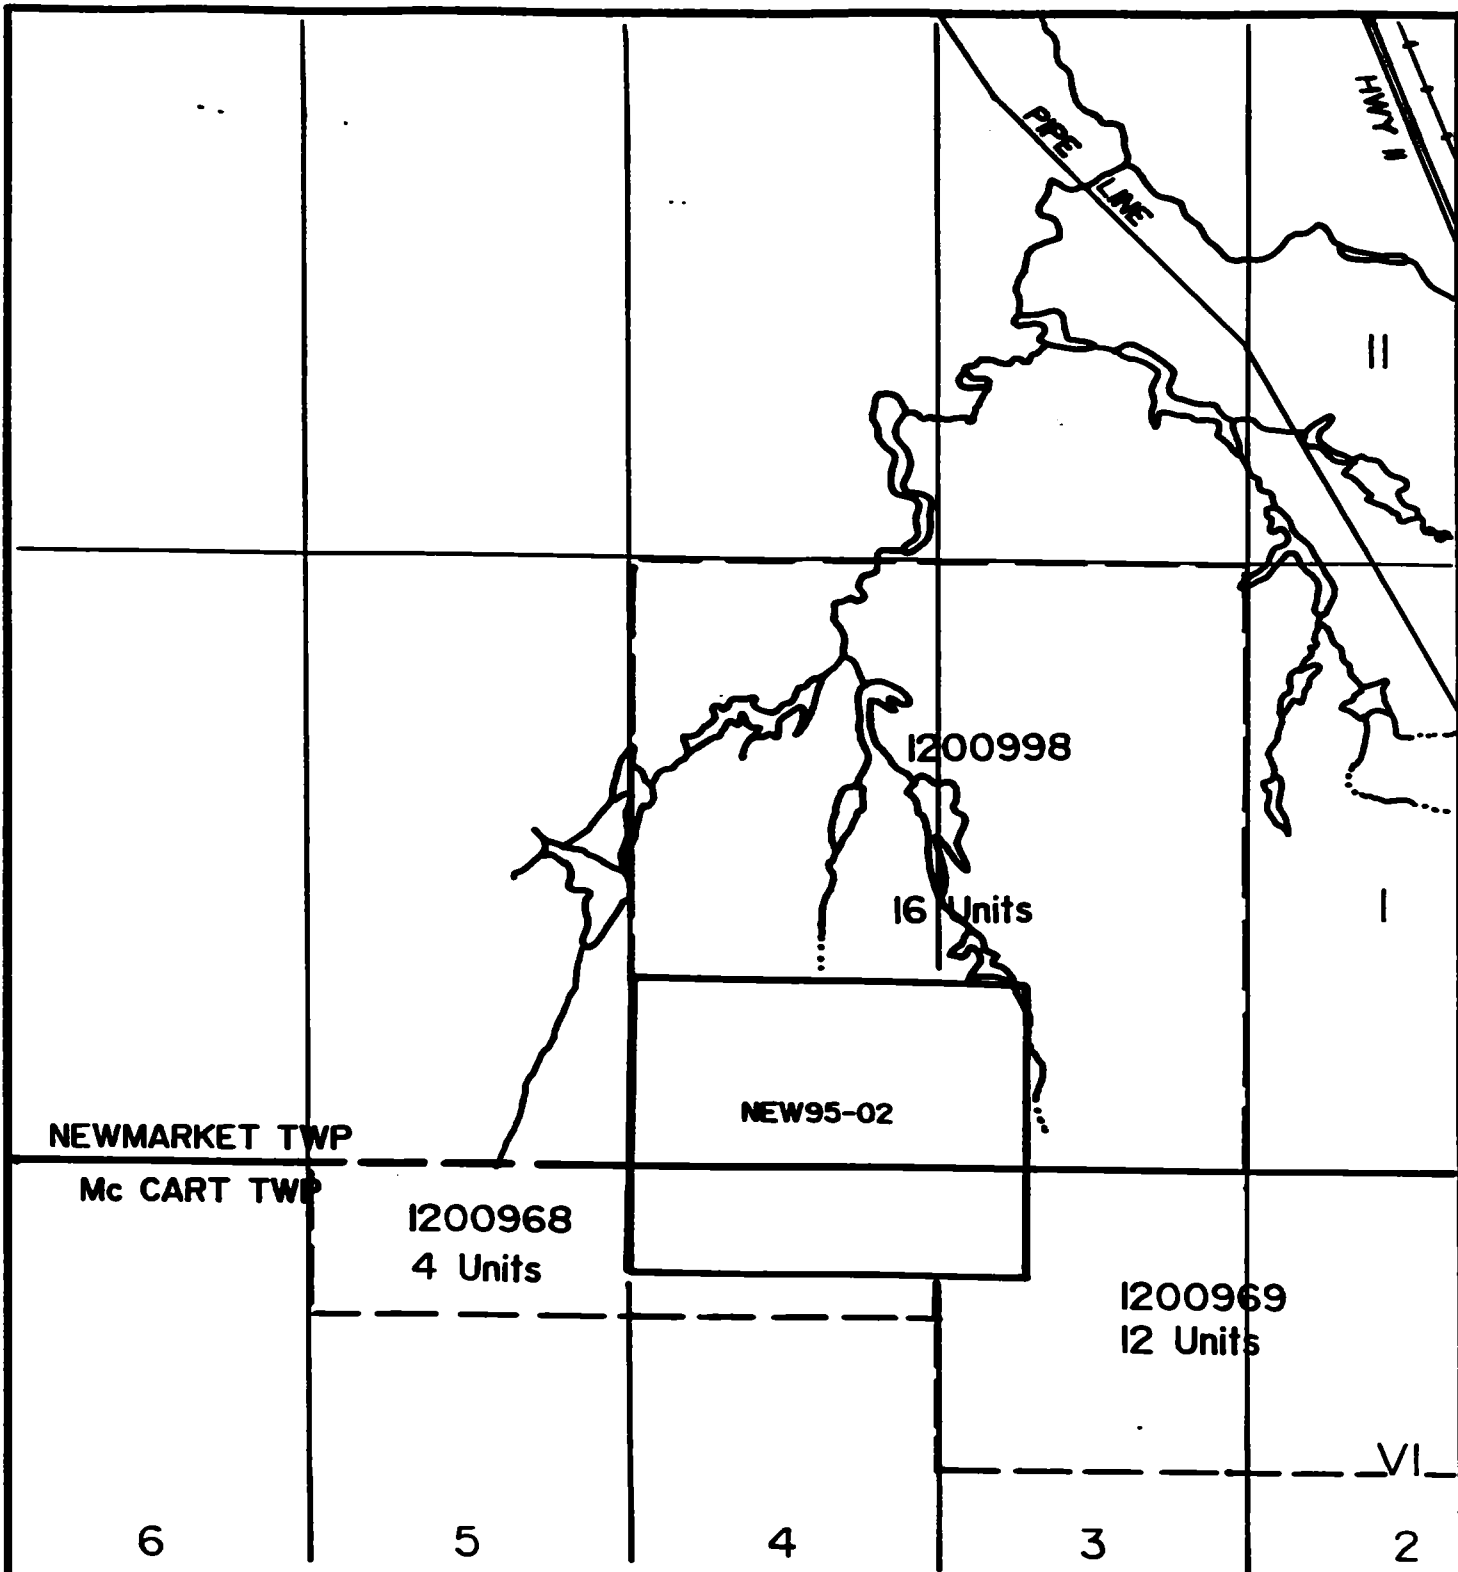

NEWMARKET TWP

Mc CART TWP

NEW95-02

1200998

16 Units

1200968
4 Units

1200969
12 Units

6

5

4

3

2

VI



EXSICS EXPLORATION LTD.

P.O. Box 1000, PLM-7X1
Suite 13, Hollinger Bldg, Timmins Ont.
Telephone: 705-267-451

CLIENT: FALCONBRIDGE LIMITED

PROPERTY: MANN BELT PN 8269

TITLE: NEWMARKET TOWNSHIP

CLAIM SKETCH GRID 2 Fig. 3

Date: Aug. 1995

Scale: 1:20,000

MNDM Plan#: G-3548

Drawn: P.Gauthier

Interp: J.C. Grant

Job No. E-124

PERSONNEL

The crew directly responsible for collecting the field data were as follows:

Bruce Pigeon.....Timmins, Ontario
Steve Olink.....Timmins, Ontario
Richard Mathieu.....Timmins, Ontario

The project was carried out under the direct supervision of J.C.Grant. The plotting and computer compilation was carried out by P.Gauthier of Exsics Exploration.

GROUND PROGRAM

This program was a two phase project. The first phase consisted of establishing a detailed metric grid across a portion of the claim group using 11 lines spaced 100 meters apart which were turned off of a control line cut west along the southern boundary. All of the lines were cut 0800 meters north and were chained with 20 meter pickets which were metal tagged. A tie line was also cut along the north boundary of the grid to control the lines. In all, a total of 10.4 kilometers of grid was established.

The second phase of the project was to complete a detailed magnetometer survey over all of the cut lines. This survey was done in conjunction with an HLEM survey which was read on the cross lines only. The magnetic survey was completed using the BRGM OMNI IV system and the HLEM survey was completed using the Apex Parametrics MaxMin II System. Specifications for these units can be found as Appendix A and B respectfully. The following parameters were kept constant throughout each survey.

MAGNETOMETER SURVEY

Linespacing..... 100 meters
Station spacing..... 20 meters
Diurnal Correction..... Basestation recorder
Reading interval..... 30 seconds
Reference field..... 58900 gammas
Datum Subtraction..... 57500 gammas
Unit accuracy..... +/- 0.5 gammas

The corrected and levelled data was then plotted directly onto a mylar base map and then contoured at 10 gamma intervals where possible. A copy of this contour map is included in the back pocket of this report.

HLEM SURVEY

Linespacing..... 100 meters
Station spacing..... 20 meters
Coil seperation..... 150 meters
Theoretical search depth... 75-80 meters
Frequencies read..... 1777hz, 444hz
Parameters Measured..... inphase and quadrature
 componetnt of the secondary field
Unit accuracy..... +\ - 0.5 %

The collected data was then plotted directly onto a mylar base map at a scale of 1:5000 and then profiled at lcm to 20%. A seperate mylar base map was done for each frequency. Any and all conductor axis were placed directly onto the maps and interpreted where possible. Conductor depths and conductivities were placed directly on each axis. A copy of each profiled map is included in the back pocket of this report.

SURVEY RESULTS

The geophysical program was successful in locating and outlining two legitimate bedrock conductors on the grid. Each of the zones has been lettered and will be discussed seperately and in detail.

Zone A

This feature is the most predominant conductor on the grid. It strikes west to east and continues off of the grid in both directions. The zone is situated at a depth to source between 70 and 80 meters with strong conductivity ranging from 20 to 46 mhos. The zone is dipping near vertical to slightly grid north. The eastern portion of the grid lying across lines 600MW to 200MW has a magnetic low association suggesting this portion of the zone lies within the mafics. As the zone continues west it appears to moderately change direction to the west-northwest and has a more magnetic high association suggesting it now may represent a contact zone between the mafics and ultramafic intrusive.

Zone B

This feature represents a short, moderately strong zone striking east-west across lines 400MW to 200MW. The zone is situated at a depth to source of 90 meters with a conductivity range of 7 to 22 mhos. The dip of the zone appears vertical.

The magnetics show a bulging in the contour pattern across the conductor axis suggesting there may be minor faulting or folding present. Again the zone may relate to a contact.

The magnetic survey was successful in mapping the geology of the grid. The results show an ultramafic unit generally crossing the central and southwest section of the grid at approximately 115 degrees. Indications of another ultramafic unit may be evident coming into the southeast corner of the grid. The north central and northeastern section of the grid is probably underlain by mafic rocks as the magnetic signature is significantly lower.

CONCLUSIONS AND RECOMMENDATIONS

The ground program was successful in locating and outlining two legitimate bedrock conductors. Zone A is a well defined structure which may relate to the contact between the mafics and ultramafic intrusive. The eastern section of the zone appears to be contained within the mafic host rocks.

Zone B is a shorter structure but with good conductivity. A bulging in the magnetics suggest either folding or faulting which would make the target a priority. However, the depth interpreted is at the maximum search depth capabilities of the present survey and care should be taken before drilling is planned.

Certainly zone A can be tested by diamond drilling. Zone B should be tested by a deep penetrating survey to better define the source or to extend it's strike length. This would serve to enhance the MaxMin target and possibly aid in spotting a drill hole.

Respectfully submitted

J. C. Grant



TABLE 1. CONDUCTOR CHARACTERISTICS

<u>Zone</u>	<u>Line/Station</u>	<u>Depth</u>	<u>Dip</u>	<u>Cond/Mhos</u>	<u>Mag Corr.</u>	<u>Comment</u>
A	1000MW/480MN	78m	vert	20	flank high	contact
A	900MW/465MN	80m	vert	36	mod high	contact
A	800MW/460MN	72m	North	36	flank high	contact
A	400MW/430MN	76m	north	46	low	contact?
A	300MW/450MN	72m	north	30	low	stringer
A	200MW/455MN	70m	vert.	30	low	stringer

B	400MW/235MN	90m	vert.	22	mod.	contact or fault
B	300MW/240MN	92m	vert.	7	mod.	contact or fault

 444 hz Frequency interpretation

CERTIFICATE

I, John C. Grant, hereby certify that:

- 1) I am a graduate geophysicist (1975) of the three year program in Geological Technology at Cambrian College of Applied Arts and Technology, Sudbury, Campus. I have worked subsequently as an Exploration Geophysicist for Teck Exploration Limited (5 years), North Bay office, and as Exploration Manager and Geophysicist for Exsics Exploration Limited from 1980 to present.
- 2) I am a Member of the Certified Engineering Technologist Association since 1984.
- 3) I am a member of the Geological Association of Canada.
- 4) I have been actively engaged in my profession for the last twenty (20) years, including all aspects of exploration studies, surveys and interpretations.
- 5) I have no specific or special interest in the described property. I have been retained as a Consulting Geophysicist by the claim holders.


John Charles Grant, CET, FGAC



APPENDIX A

OMNI IV "Tie-Line" Magnetometer

EDA

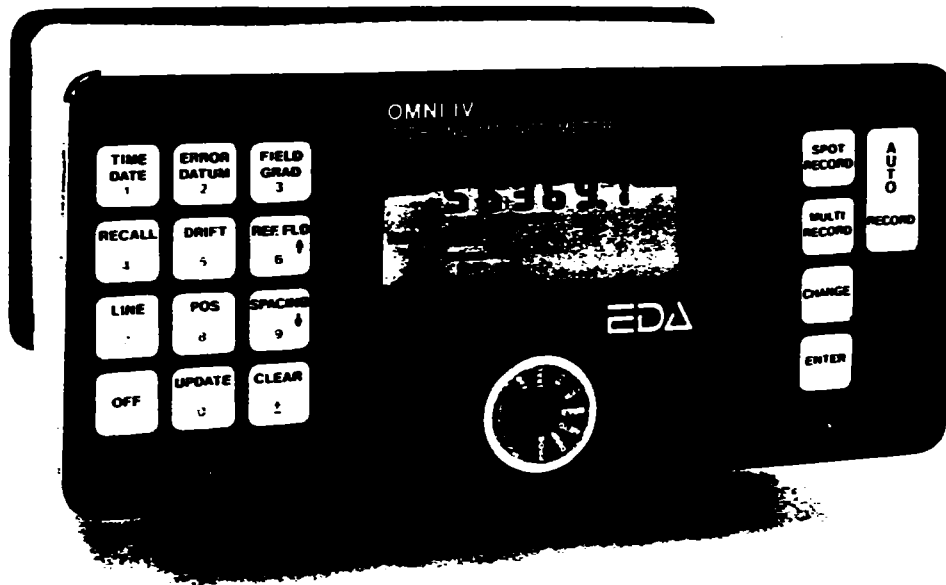

- Four Magnetometers in One
- Self Correcting for Diurnal Variations
- Reduced Instrumentation Requirements
- 25% Weight Reduction
- User Friendly Keypad Operation
- Universal Computer Interface
- Comprehensive Software Packages



Specifications

Dynamic Range	18,000 to 110,000 gammas. Roll-over display feature suppresses first significant digit upon exceeding 100,000 gammas.
Tuning Method	Tuning value is calculated accurately utilizing a specially developed tuning algorithm
Automatic Fine Tuning	$\pm 15\%$ relative to ambient field strength of last stored value
Display Resolution	0.1 gamma
Processing Sensitivity	± 0.02 gamma
Statistical Error Resolution	0.01 gamma
Absolute Accuracy	± 1 gamma at 50,000 gammas at 23°C ± 2 gamma over total temperature range
Standard Memory Capacity	
Total Field or Gradient	1,200 data blocks or sets of readings
Tie-Line Points	100 data blocks or sets of readings
Base Station	5,000 data blocks or sets of readings
Display	Custom-designed, ruggedized liquid crystal display with an operating temperature range from -40°C to $+55^{\circ}\text{C}$. The display contains six numeric digits, decimal point, battery status monitor, signal decay rate and signal amplitude monitor and function descriptors.
RS 232 Serial I/O Interface	2400 baud, 8 data bits, 2 stop bits, no parity
Gradient Tolerance	6,000 gammas per meter (field proven)
Test Mode	A. Diagnostic testing (data and programmable memory) B. Self Test (hardware)
Sensor	Optimized miniature design. Magnetic cleanliness is consistent with the specified absolute accuracy.
Gradient Sensors	0.5 meter sensor separation (standard), normalized to gammas/meter. Optional 1.0 meter sensor separation available. Horizontal sensors optional.
Sensor Cable	Remains flexible in temperature range specified, includes strain-relief connector
Cycling Time (Base Station Mode)	Programmable from 5 seconds up to 60 minutes in 1 second increments
Operating Environmental Range	-40°C to $+55^{\circ}\text{C}$; 0-100% relative humidity; weatherproof
Power Supply	Non-magnetic rechargeable sealed lead-acid battery cartridge or belt; rechargeable NiCad or Disposable battery cartridge or belt; or 12V DC power source option for base station operation.
Battery Cartridge/Belt Life	2,000 to 5,000 readings, for sealed lead acid power supply, depending upon ambient temperature and rate of readings
Weights and Dimensions	
Instrument Console Only	2.8 kg, 238 x 150 x 250mm
NiCad or Alkaline Battery Cartridge	1.2 kg, 235 x 105 x 90mm
NiCad or Alkaline Battery Belt	1.2 kg, 540 x 100 x 40mm
Lead-Acid Battery Cartridge	1.8 kg, 235 x 105 x 90mm
Lead-Acid Battery Belt	1.8 kg, 540 x 100 x 40mm
Sensor	1.2 kg, 56mm diameter x 200mm
Gradient Sensor (0.5 m separation - standard)	2.1 kg, 56mm diameter x 790mm
Gradient Sensor (1.0 m separation - optional)	2.2 kg, 56mm diameter x 1300mm
Standard System Complement	Instrument console; sensor; 3-meter cable, aluminum sectional sensor staff, power supply, harness assembly, operations manual.
Base Station Option	Standard system plus 30 meter cable
Gradiometer Option	Standard system plus 0.5 meter sensor

EDA Instruments Inc.
4 Thorncliffe Park Drive
Toronto, Ontario
Canada M4H 1H1
Telex: 06 23222 EDA TOR
Cable: Instruments Toronto
(416) 425 7800

In U.S.A.
EDA Instruments Inc.
5151 Ward Road
Wheat Ridge, Colorado
U.S.A. 80033
(303) 422 9112

Printed in Canada

APPENDIX B

Five frequencies: 222, 444, 888, 1777 and 3555 Hz.

Maximum coupled (horizontal-loop) operation with reference cable.

Minimum coupled operation with reference cable.

Vertical-loop operation without reference cable.



Coil separations: 25, 50, 100, 150, 200 and 250 m (with cable) or 100, 200, 300, 400, 600 and 800 ft.

Reliable data from depths of up to 180m (600 ft).

Built-in voice communication circuitry with cable.

Tilt meters to control coil orientation.



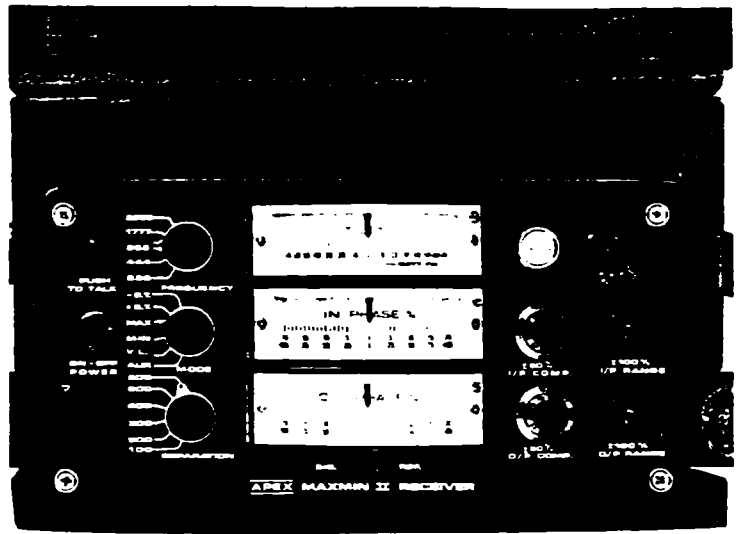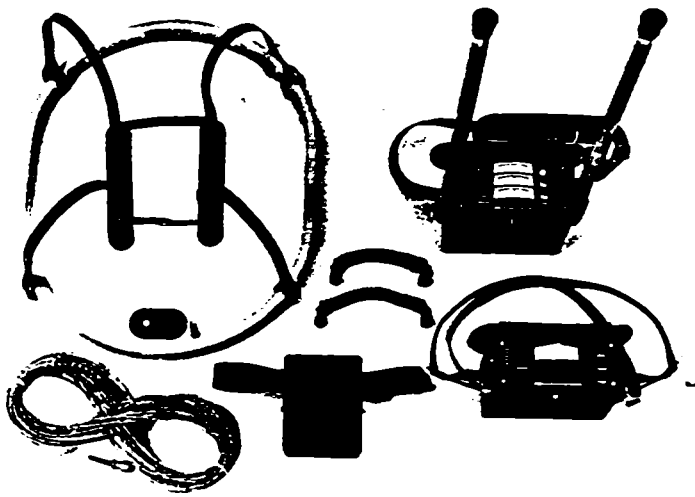

222, 444, 888, 1777 and 3555 Hz.

MAX: Transmitter coil plane and receiver coil plane horizontal (Max-coupled; Horizontal-loop mode). Used with refer. cable.

MIN: Transmitter coil plane horizontal and receiver coil plane vertical (Min-coupled mode). Used with reference cable.

V.L.: Transmitter coil plane vertical and receiver coil plane horizontal (Vertical-loop mode). Used without reference cable, in parallel lines.

25, 50, 100, 150, 200 & 250m (MMII) or 100, 200, 300, 400, 600 and 800 ft. (MMIF).
Coil separations in V.L. mode not restricted to fixed values.

- In-Phase and Quadrature components of the secondary field in MAX and MIN modes.
- Tilt-angle of the total field in V.L. mode.
- Automatic, direct readout on 90mm (3.5") edgewise meters in MAX and MIN modes. No nulling or compensation necessary.
- Tilt angle and null in 90mm edgewise meters in V.L. mode.

In-Phase: $\pm 20\%$, $\pm 100\%$ by push-button switch.
Quadrature: $\pm 20\%$, $\pm 100\%$ by push-button switch.
Tilt: $\pm 75\%$ slope.
Null (V.L.): Sensitivity adjustable by separation switch.

In-Phase and Quadrature: 0.25% to 0.5% ; Tilt: 1%.

$\pm 0.25\%$ to $\pm 1\%$ normally, depending on conditions, frequencies and coil separation used.

- 222Hz : 220 Atm²
- 444Hz : 200 Atm²
- 888Hz : 120 Atm²
- 1777Hz : 60 Atm²
- 3555Hz : 30 Atm²

9V trans radio type batteries (4).
Life: approx. 35 hrs. continuous duty (alkaline, 0.5 Ah), less in cold weather.

12V 6Ah Gel-type rechargeable battery. (Charger supplied).

Light weight 2-conductor teflon cable for minimum friction. Unshielded. All reference cables optional at extra cost. Please specify.

Built-in intercom system for voice communication between receiver and transmitter operators in MAX and MIN modes, via reference cable.

Built-in signal and reference warning lights to indicate erroneous readings.

-40°C to +60°C (-40°F to +140°F).

6kg (13 lbs.)

13kg (29 lbs.)

Typically 60kg (135 lbs.), depending on quantities of reference cable and batteries included. Shipped in two field/shipping cases.

Specifications subject to change without notification

200 STEELCASE RD. E., MARKHAM, ONT., CANADA, L3R 1G2

Phone: (416) 495-1612

Cables: APEXPARA TORONTO

Telex: 06-966773 NORDVIK TOR



Report of Work Conducted After Recording Claim


Mining Act

Transaction Number
W9560.00453

SEE PAGE 2.

Personal information collected on this form is obtained under the authority of the Mining Act. This information will be used for correspondence. Questions about this collection should be directed to the Provincial Manager, Mining Lands, M
Sudbury, Ontario, P3E 6A5, telephone (705) 670-7264.

- Instructions:
- Please type or print and submit in duplicate.
 - Refer to the Mining Act and Regulations for Recorder.
 - A separate copy of this form must be completed for each work group.
 - Technical reports and maps must accompany this form in duplicate.
 - A sketch, showing the claims the work is assigned to, must accompany this form.

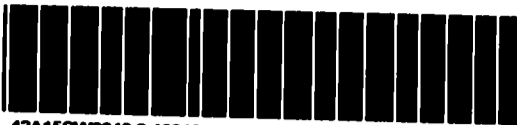

42A15SW0048 2.16313 NEWMARKET

900

Recorded Holder(s) FALCONBRIDGE LIMITED		Client No. 130679
Address 571 Moneta Ave. P.O. Box 1140 Timmins, Ont. P4N7H9		Telephone No. (705) 267-1188
Mining Division PORCUPINE	Township/Area Newmarket + McCart	M or G Plan No.
Date Work Performed From: September 15, 1995	To: September 27, 1995	

Work Performed (Check One Work Group Only)

Work Group	Type
Geotechnical Survey	Line cutting, Magnetic + HLEM surveys
Physical Work, including Drilling	Taking Air Photos + Spotting Grids
Rehabilitation	
Other Authorized Work	
Assays	
Assignment from Reserve	

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DEC 20 1995

MINING LANDS BRANCH

Total Assessment Work Claimed on the Attached Statement of Costs \$ 8229 7784

Note: The Minister may reject for assessment work credit all or part of the assessment work submitted if the recorded holder cannot verify expenditures claimed in the statement of costs within 30 days of a request for verification.

Persons and Survey Company Who Performed the Work (Give Name and Address of Author of Report)

Name	Address
Exsics Exploration Ltd.	Box 1880 Timmins, Ont. P4N 7X1
Hillside Photo	66 Brousseau Ave. Timmins Ont. P4N 5Y2
F. Renaudal Exp. Ltd.	Box 1092, Timmins Ont. P4N 7H9

(attach a schedule if necessary)

Certification of Beneficial Interest * See Note No. 1 on reverse side

I certify that at the time the work was performed, the claims covered in this work were recorded in the current holder's name or held under a beneficial interest by the current recorded holder.	Date Oct 10 '95	Recorded By (Signature) Paul Nagerl
---	---------------------------	---

Certification of Work Report

I certify that I have a personal knowledge of the facts set forth in this Work report, having performed the work or witnessed same during and/or after its completion and annexed report is true.

Name and Address of Person Certifying PAUL NAGERL 571 Moneta Ave. Timmins, Ont.		
Telephone No. (705) 267-1188	Date Oct. 10 '95	Certified By (Signature) Paul Nagerl

For Office Use Only

Total Value Cr. Recorded 7784 \$8229	Date Recorded	Mining Recorder undated Jerry White	RECEIVED OCT. 11 1995 @ 10:20 am (C) UC PORCUPINE MINING DIVISION
Deemed Approval Date Jan 9/96	Date Approved		
Date Notice for Amendments Sent			



Report of Work Conducted After Recording Claim

Mining Act

Transaction Number
W9560.00453

Personal information collected on this form is obtained under the authority of the Mining Act. This information will be used for correspondence. Questions about this collection should be directed to the Provincial Manager, Mining Lands, Ministry of Northern Development and Mines, Fourth Floor, 159 Cedar Street, Sudbury, Ontario, P3E 6A5, telephone (705) 670-7264.

- Instructions:
- Please type or print and submit in duplicate.
 - Refer to the Mining Act and Regulations for requirements of filing assessment work or consult the Mining Recorder.
 - A separate copy of this form must be completed for each Work Group.
 - Technical reports and maps must accompany this form in duplicate.
 - A sketch, showing the claims the work is assigned to, must accompany this form.

2 1 5 3 1 8

Recorded Holder(s) FALCONBRIDGE LIMITED		Client No. 130679
Address P.O. Box 1140, 571 MONETA AVE. TIMMINS, ONTARIO P4N 7H9		Telephone No. (705) 267-1188
Mining Division PORCUPINE	Township/Area NEWMARKET	M or G Plan No.
Dates Work Performed From: September 15, 1995		To: September 27, 1995

Work Performed (Check One Work Group Only)

Work Group	Type
Geotechnical Survey	EXSIC EXPL LINECUTTING, MAGNETICS + ALEM SURVEYS
Physical Work, including Drilling	
Rehabilitation	
Other Authorized Work	
Assays	
Assignment from Reserve	

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DEC 20 1995
MINING LANDS

Total Assessment Work Claimed on the Attached Statement of Costs \$ 445 (PART OF \$8229 TOTAL)

Note: The Minister may reject for assessment work credit all or part of the assessment work submitted if the recorded holder cannot verify expenditures claimed in the statement of costs within 30 days of a request for verification.

Persons and Survey Company Who Performed the Work (Give Name and Address of Author of Report)

Name	Address
EXSIC EXPL. LTD.	Box 1880, Timmins, Ont. P4N 7X1

(attach a schedule if necessary)

Certification of Beneficial Interest * See Note No. 1 on reverse side

When the work was performed, the claims covered in this work were recorded in the current holder's name or held under a beneficial interest by the current recorded holder.	Date Nov. 28/95	Recorded (Signature) Christine Peth
---	---------------------------	---

Certification of Work Report

I certify that I have a personal knowledge of the facts set forth in this Work report, having performed the work or witnessed same during and/or after its completion and annexed report is true.

Name and Address of Person Certifying CHRISTINE PETH P.O. Box 1140, 571 MONETA AVE. TIMMINS, ONTARIO P4N 7H9		
Telephone No. (705) 267-1188	Date NOVEMBER 28, 1995	Certified By (Signature) Christine Peth

For Office Use Only

Total Value Cr. Recorded	Date Recorded	Mining Recorder	Received Stamp RECEIVED NOV 30 1995 11:15 (C) [Signature] PORCUPINE MINING DIVISION
	Deemed Approval Date	Date Approved	
	Date Notice for Amendments Sent		

2041 (03/91)

Work Report Number for Applying Reserve	Claim Number (see Note 2)	Number of Claim Units
2		
1		
3	1300969	12
3	1200968	4
4	1200998	16
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Ministry of
Northern Development
and Mines

Ministère du
Développement du Nord
et des mines

Statement of Costs
for Assessment Credit

État des coûts aux fins
du crédit d'évaluation

Mining Act/Loi sur les mines

Transaction No./N° de transaction

W9560.00453

SEE PAGE 2.

2.16313

Personal information collected on this form is obtained under the authority of the Mining Act. This information will be used to maintain a record and ongoing status of the mining claim(s). Questions about this collection should be directed to the Provincial Manager, Minings Lands, Ministry of Northern Development and Mines, 4th Floor, 159 Cedar Street, Sudbury, Ontario P3E 6A5, telephone (705) 670-7264.

Les renseignements personnels contenus dans la présente formule sont recueillis en vertu de la Loi sur les mines et serviront à tenir à jour un registre des concessions minières. Adresser toute question sur la collecte de ces renseignements au chef provincial des terrains miniers, ministère du Développement du Nord et des Mines, 159, rue Cedar, 4^e étage, Sudbury (Ontario) P3E 6A5, téléphone (705) 670-7264.

1. Direct Costs/Coûts directs

Type	Description	Amount Montant	Totals Total global
Wages Salaires	Labour Main-d'oeuvre		
	Field Supervision Supervision sur le terrain	1000.00	1000.00
Contractor's and Consultant's Fees Droits de l'entrepreneur et de l'expert- conseil	Type Excises Expl.	6406.50	
	Hillside Photo	80.00	
	E. Renaudat	1550.00	6641.50
Supplies Used Fournitures utilisées	Type Flagging	10.00	
	Hip Chain		
			10.00
Equipment Rental Location de matériel	Type TRUCK	41.90	
	ATV	41.25	
	Gas	5000	133.15
Total Direct Costs Total des coûts directs			7784

2. Indirect Costs/Coûts indirects

** Note: When claiming Rehabilitation work indirect costs are not allowable as assessment work.
Pour le remboursement des travaux de réhabilitation, les coûts indirects ne sont pas admissibles en tant que travaux d'évaluation.

Type	Description	Amount Montant	Totals Total global
Transportation Transport	Type		
	RECEIVED		
	DEC 20 1995		
Food and Lodging Nourriture et hébergement	MINING LANDS		
Mobilization and Demobilization Mobilisation et démobilisation			
Sub Total of Indirect Costs Total partiel des coûts indirects			
Amount Allowable (not greater than 20% of Direct Costs) Montant admissible (n'excédant pas 20 % des coûts directs)			
Total Value of Assessment Credit (Total of Direct and Allowable indirect costs)			
Valeur totale du crédit d'évaluation (Total des coûts directs et indirects admissibles)			

Note: The recorded holder will be required to verify expenditures claimed in this statement of costs within 30 days of a request for verification. If verification is not made, the Minister may reject for assessment work all or part of the assessment work submitted.

Note: Le titulaire enregistré sera tenu de vérifier les dépenses demandées dans le présent état des coûts dans les 30 jours suivant une demande à cet effet. Si la vérification n'est pas effectuée, le ministre peut rejeter tout ou une partie des travaux d'évaluation présentés.

Filing Discounts

1. Work filed within two years of completion is claimed at 100% of the above Total Value of Assessment Credit.

2. Work filed three, four or five years after completion is claimed at 50% of the above Total Value of Assessment Credit. See calculations below:

Total Value of Assessment Credit	Total Assessment Claimed
	x 0.50 =

Remises pour dépôt

1. Les travaux déposés dans les deux ans suivant leur achèvement sont remboursés à 100 % de la valeur totale susmentionnée du crédit d'évaluation.

2. Les travaux déposés trois, quatre ou cinq ans après leur achèvement sont remboursés à 50 % de la valeur totale du crédit d'évaluation susmentionné. Voir les calculs ci-dessous.


Valeur totale du crédit d'évaluation	Évaluation totale demandée
	x 0,50 =

Certification Verifying Statement of Costs

I hereby certify:
that the amounts shown are as accurate as possible and these costs were incurred while conducting assessment work on the lands shown on the accompanying Report of Work form.

that as _____ I am authorized
(Recorded Holder, Agent, Position in Company)

to make this certification

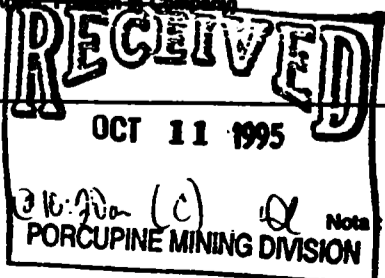

Attestation de l'état des coûts

J'atteste par la présente:
que les montants indiqués sont le plus exact possible et que ces dépenses ont été engagées pour effectuer les travaux d'évaluation sur les terrains indiqués dans la formule de rapport de travail ci-joint.

Et qu'à titre de _____ je suis autorisé
(titulaire enregistré, représentant, poste occupé dans la compagnie)

à faire cette attestation.

Signature: Paul Nagel Date: Oct 10 '95



Personal information collected on this form is obtained under the authority of the Mining Act. This information will be used to maintain a record and ongoing status of the mining claim(s). Questions about this collection should be directed to the Provincial Manager, Minings Lands, Ministry of Northern Development and Mines, 4th Floor, 159 Cedar Street, Sudbury, Ontario P3E 6A5, telephone (705) 670-7264.

Les renseignements personnels contenus dans la présente formule sont recueillis en vertu de la Loi sur les mines et serviront à tenir à jour un registre des concessions minières. Adresser toute question sur la collecte de ces renseignements au chef provincial des terrains miniers, ministère du Développement du Nord et des Mines, 159, rue Cedar, 4^e étage, Sudbury (Ontario) P3E 6A5, téléphone (705) 670-7264.

1. Direct Costs/Coûts directs

Type	Description	Amount Montant	Totals Total global
Wages Salaires	Labour Main-d'oeuvre		
	Field Supervision Supervision sur le terrain		
Contractor's and Consultant's Fees Droits de l'entrepreneur et de l'expert-conseil	Type		
	EXSICS EXP.LTD	445. ⁰⁰	
			445. ⁰⁰
Supplies Used Fournitures utilisées	Type		
Equipment Rental Location de matériel	Type		
Total Direct Costs Total des coûts directs			445

2. Indirect Costs/Coûts indirects

Note: When claiming Rehabilitation work indirect costs are not allowable as assessment work. Pour le remboursement des travaux de réhabilitation, les coûts indirects ne sont pas admissibles en tant que travaux d'évaluation.

Type	Description	Amount Montant	Totals Total global
Transportation Transport	Type		
RECEIVED			
DEC 20 1995			
Food and Lodging Nourriture et hébergement			
Mobilization and Demobilization Mobilisation et démoblisation			
Sub Total of Indirect Costs Total partiel des coûts indirects			
Amount Allowable (not greater than 20% of Direct Costs) Montant admissible (n'excédant pas 20 % des coûts directs)			
Total Value of Assessment Credit (Total of Direct and Allowable indirect costs) Valeur totale du crédit d'évaluation (Total des coûts directs et indirects admissibles)			445

Note: The recorded holder will be required to verify expenditures claimed in this statement of costs within 30 days of a request for verification. If verification is not made, the Minister may reject for assessment work all or part of the assessment work submitted.

Note: Le titulaire enregistré sera tenu de vérifier les dépenses demandées dans le présent état des coûts dans les 30 jours suivant une demande à cet effet. Si la vérification n'est pas effectuée, le ministre peut rejeter tout ou une partie des travaux d'évaluation présentés.

Filing Discounts

1. Work filed within two years of completion is claimed at 100% of the above Total Value of Assessment Credit.
2. Work filed three, four or five years after completion is claimed at 50% of the above Total Value of Assessment Credit. See calculations below:

Remises pour dépôt

1. Les travaux déposés dans les deux ans suivant leur achèvement sont remboursés à 100 % de la valeur totale susmentionnée du crédit d'évaluation.
2. Les travaux déposés trois, quatre ou cinq ans après leur achèvement sont remboursés à 50 % de la valeur totale du crédit d'évaluation susmentionné. Voir les calculs ci-dessous.

Total Value of Assessment Credit	Total Assessment Claimed
	x 0.50 =

Valeur totale du crédit d'évaluation	Évaluation
	x 0,50 =

Certification Verifying Statement of Costs

I hereby certify: that the amounts shown are as accurate as possible and these costs were incurred while conducting assessment work on the lands shown on the accompanying Report of Work form.

that as CHRISTINE PETCH I am authorized (Recorded Holder, Agent, Position in Company)

to make this certification

Attestation de l'état des coûts

J'atteste par la présente: que les montants indiqués sont le plus exact possible et que ces dépenses ont été engagées pour effectuer les travaux d'évaluation sur les terrains indiqués dans la formule de rapport de travail ci-joint.

Et qu'à titre de _____ je suis autorisé (titulaire enregistré, représentant, poste occupé dans la compagnie)

à faire cette attestation.

Signature Christine Petch Date Nov. 28/95



Ministry of
Northern Development
and Mines

Ministère du
Développement du Nord
et des Mines

Geoscience Approvals Office
933 Ramsey Lake Road
6th Floor
Sudbury, Ontario
P3E 6B5

Telephone: (705) 670-5853
Fax: (705) 670-5863

December 21, 1995

Our File: 2.16313
Transaction #: W9560.00453

Mining Recorder
Ministry of Northern Development & Mines
60 Wilson Avenue, 1st Floor
Timmins, Ontario
P4N 2S7

Dear Sir:

**Subject: APPROVAL OF ASSESSMENT WORK CREDITS ON MINING CLAIMS
P.1200998 ET AL IN MCCART & NEWMARKET TOWNSHIPS**

Assessment work credits have been approved as outlined on the original submission. The credits have been approved under Section 14, Geophysics (Mag, EM), Mining Act Regulations.

The approval date is December 21, 1995.

If you have any questions regarding this correspondence, please contact Lucille Jerome at (705) 670-5858.

Yours Sincerely,
ORIGINAL SIGNED BY:

A handwritten signature in cursive script, appearing to read "Ron C. Gashinski".

Ron C. Gashinski
Senior Manager, Mining Lands Section
Mining and Land Management Branch
Mines and Minerals Division

LJ/jl
Enclosure:

cc: Resident Geologist
Timmins, Ontario

✓ Assessment Files Library
Sudbury, Ontario

C-3248

MEMARKET TWP

C-3248


AREAS WITHDRAWN FROM DISPOSITION
 M.R.O. - MINING RIGHTS ONLY
 S.R.O. - SURFACE RIGHTS ONLY
 M+S. - MINING AND SURFACE RIGHTS

Description	Order No.	Date	Disposition	File
W 43/79 NR	16/5/79	S R O	33749	

Surface Rights Withdrawn under Sec. 36
 The Mining Act R.S.O. 1980, ORDER NO. W-43/79/ONT
 (Tram and Pipeline Right of Way and Luffar
 Zone periphery 40.23 meters or 132 ft. on
 either side of centre line of right of way)
 CANCELLED - MARCH 3/95

THE INFORMATION THAT
 APPEARS ON THIS MAP
 HAS BEEN COMPILED
 FROM VARIOUS SOURCES,
 AND ACCURACY IS NOT
 GUARANTEED. THOSE
 WISHING TO STAKE
 MINING CLAIMS SHOULD CON-
 SULT WITH THE MINING
 RECORDER, MINISTRY OF
 NORTHERN DEVELOP-
 MENT AND MINES, FOR AD-
 DITIONAL INFORMATION
 ON THE STATUS OF THE
 LANDS SHOWN HEREON

MAIN TOWNSHIP

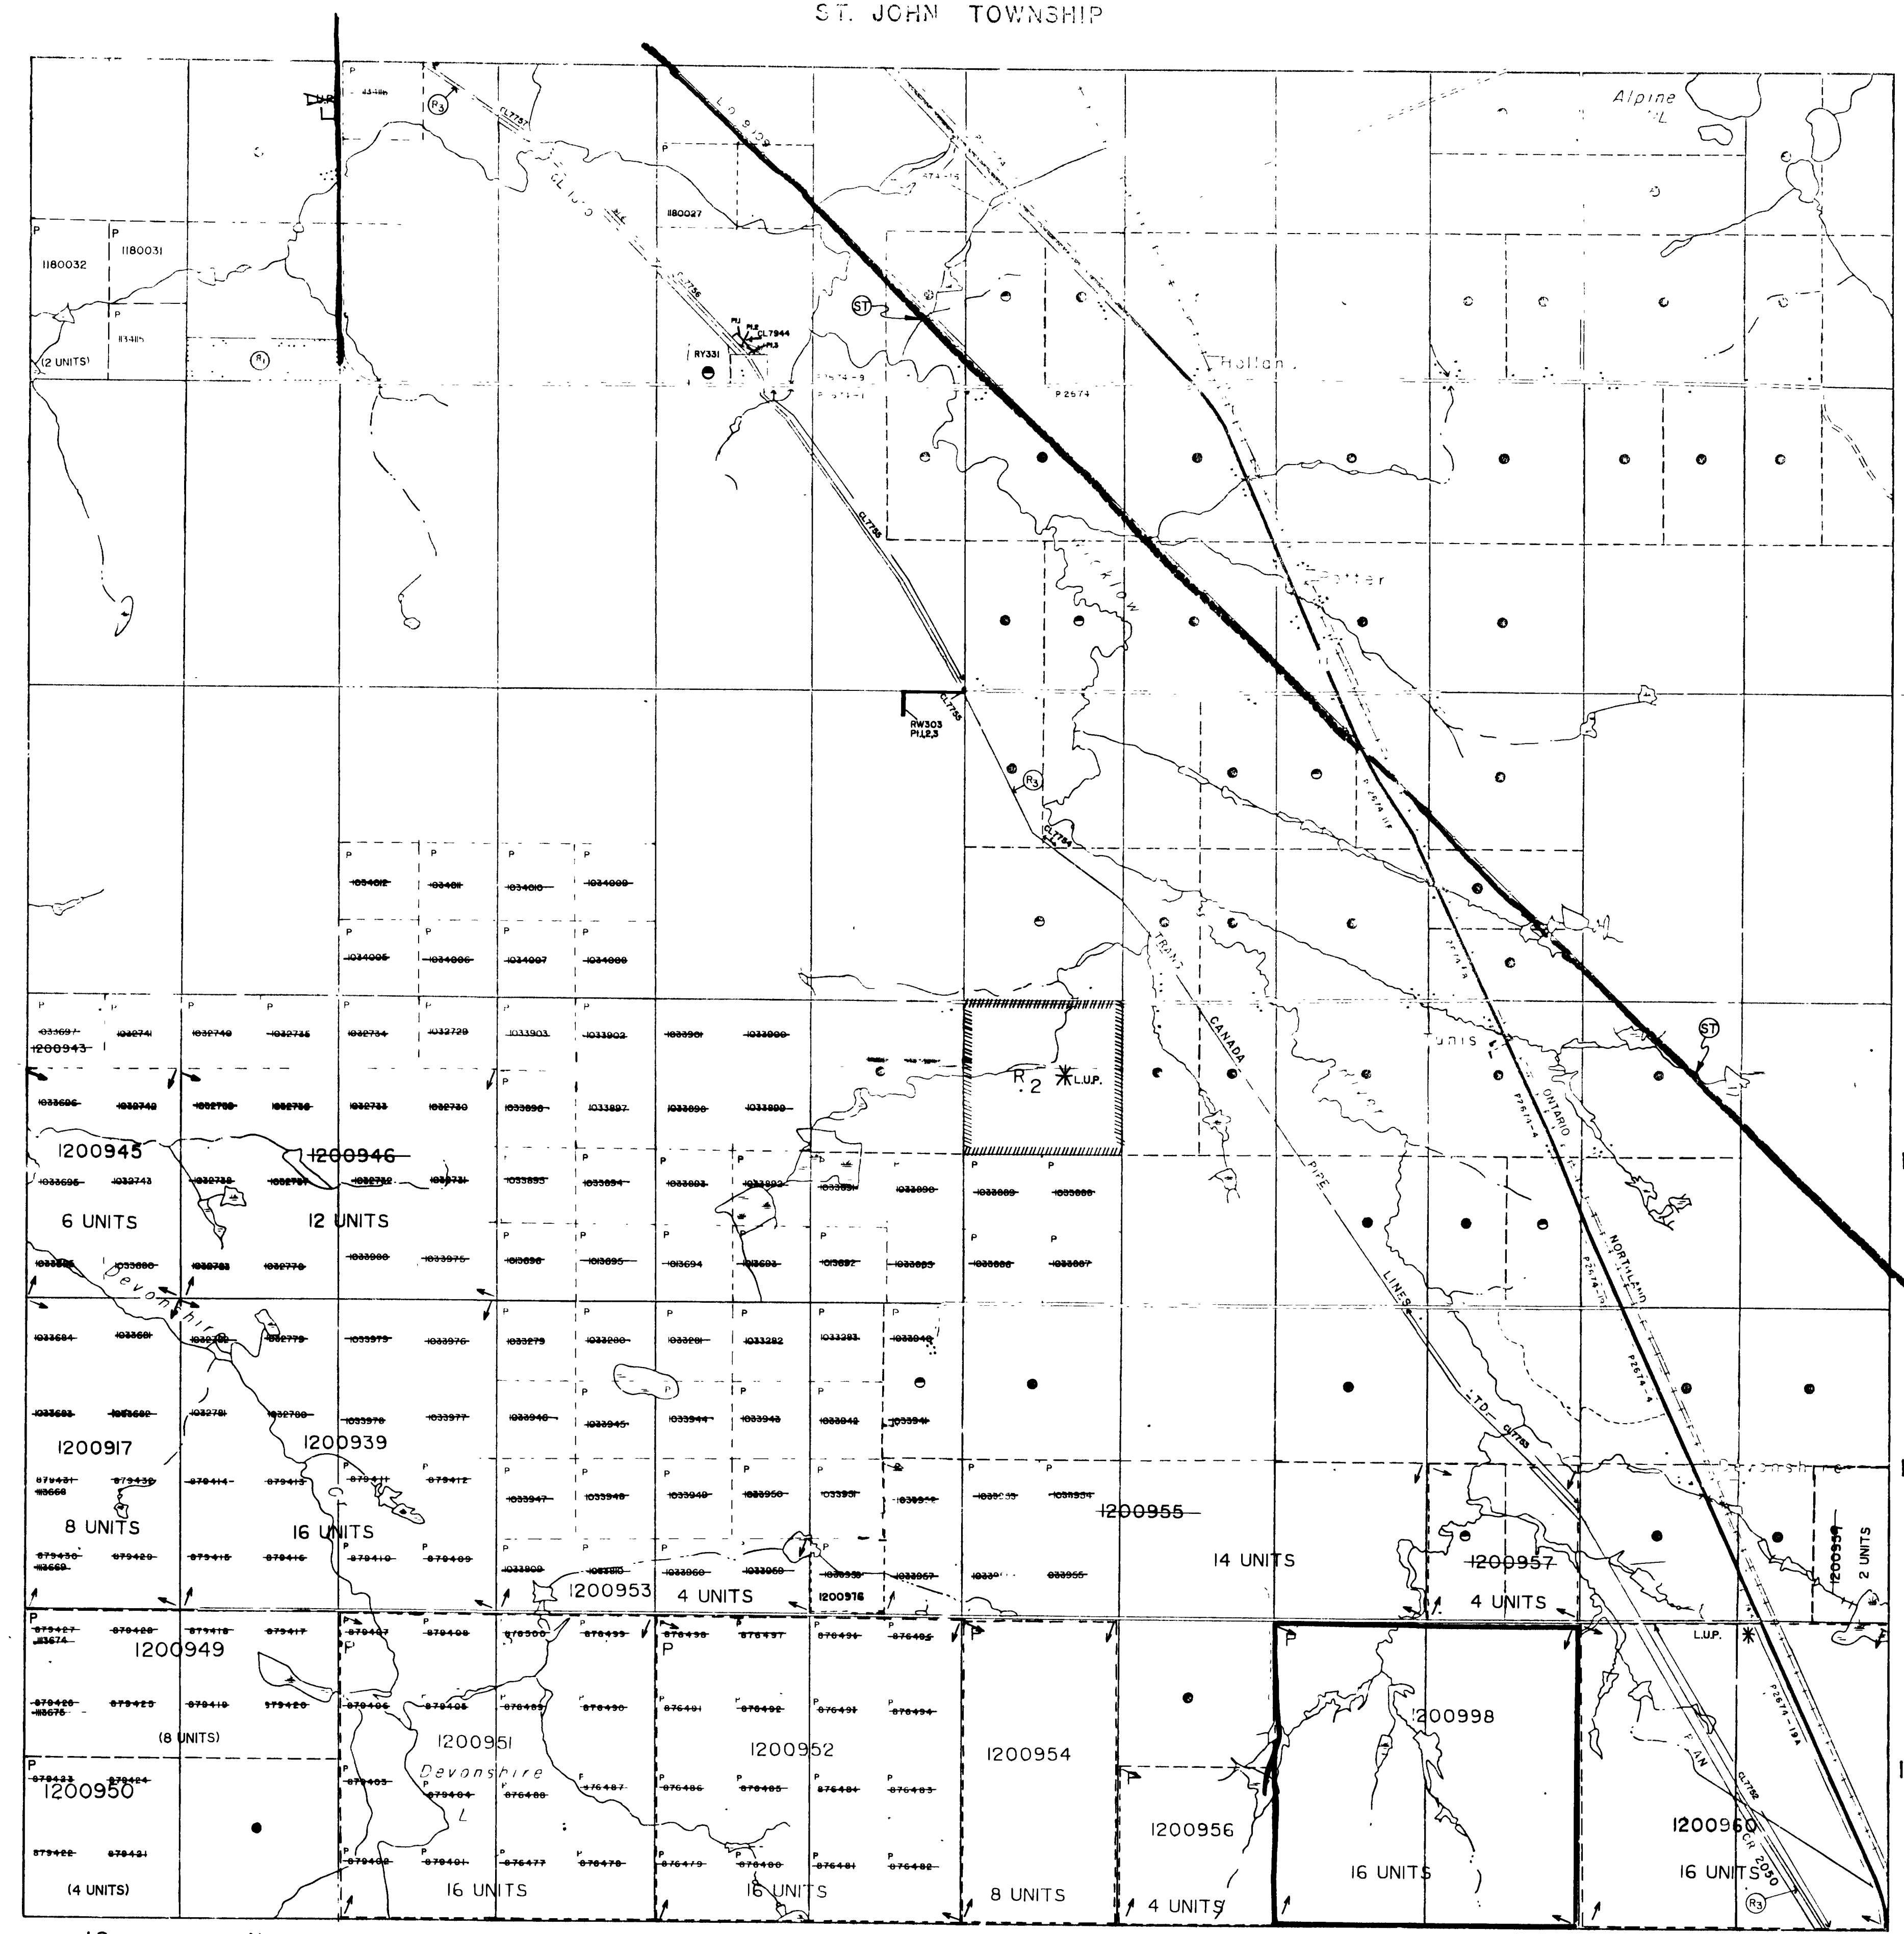

ST. JOHN TOWNSHIP

Mc CART TOWNSHIP

VI
V
IV
III
II
I

AURORA TOWNSHIP


LEGEND

HIGHWAY AND ROUTE No	
OTHER ROADS	
TRAILS	
SURFACE RIGHTS	
TOWNSHIP BASE LINES ETC	
LOTS, MINING CLAIMS PARCELS, ETC	
RAILROAD LINES	
RAILROAD BOUNDARY	
RAILROAD AND RIGHT OF WAY	
TITLE LINES	
PERMANENT STREAM	
PERMANENT FLOODING RIGHTS	
SEASONAL OR COMPOSITE PLAN RESERVATIONS	
ORIGINAL SHORELINE	
MARSH OR MUSKEG	
MINES	
TRAVELERS MONUMENT	

DISPOSITION OF CROWN LAND

TYPE OF DOCUMENT	SYMBOL
PATENT SURFACE & MINING RIGHTS	
SURFACE RIGHTS ONLY	
MINING RIGHTS ONLY	
LEASE SURFACE & MINING RIGHTS	
SURFACE RIGHTS ONLY	
MINING RIGHTS ONLY	
LICENCE OF OCCUPATION	
ORDER IN COUNCIL RESERVATION	
CANCELLED	
SAND & GRAVEL LUP (LAND USE PERMIT)	
LUP (LAND USE PERMIT)	

NOTE: MINING RIGHTS IN PARCELS PATENTED PRIOR TO MAY 1913, AND IN ORIGINAL PATENTS BY THE PUBLIC LANDS ACT R.S.O. 1970, CHAP. 380 SEC. 43 SUBSEC. 1.

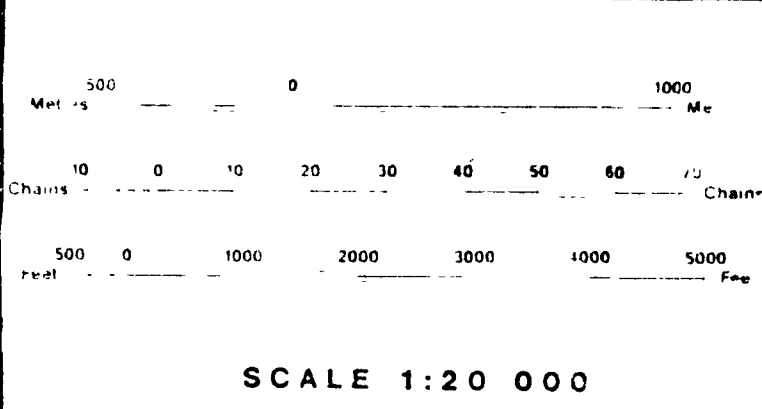

R₂ - AGRICULTURAL PERMIT
 SNOWMOBILE TRAIL NOTICE RECEIVED 92-DEC-09

16313
 RECEIVED
 DEC 20 1995
 MINING LANDS BRANCH
 ISSUED
 DEC 13 1995
 PORCUPINE MINING DIVISION

TOWNSHIP
NEWMARKET
 MNR ADMINISTRATIVE DISTRICT
 COCHRANE
 MINING DIVISION
 PORCUPINE
 LAND TITLES / REGISTRY DIVISION
 COCHRANE

Ministry of Natural Resources Ontario
 Ministry of Northern Development and Mines

Date: SEPTEMBER 1984
 Number: **G-3548**

2.16313
 mag, em.



C-3248

MEMARKET TWP

C-3248

TOWNSHIP OF NEWMARKET


2.16313 mag, em.

NOTE
 LOT AND SECTION LINES SHOWN HEREON ARE PROJECTED FROM THE BEST INFORMATION AVAILABLE, BUT THEIR TRUE POSITION IS NOT GUARANTEED.
 FOR LEGAL AND SURVEY PURPOSES CONSULT THE ORIGINAL SURVEY PLANS AND FIELD NOTES OF RECORD IN THE DEPARTMENT OF LANDS AND FORESTS, TORONTO.
 AREAS SHOWN IN RESPECT OF PATENTED LOTS ARE IN ACCORDANCE WITH AREA GRANTED.

AREAS WITHDRAWN FROM DISPOSITION
 M.S.O. - SURFACE RIGHTS ONLY
 S.S.O. - SURFACE RIGHTS ONLY
 M.S.E. - MINING AND SURFACE RIGHTS

AGGREGATE PERMIT

LITTLE TOWNSHIP OF

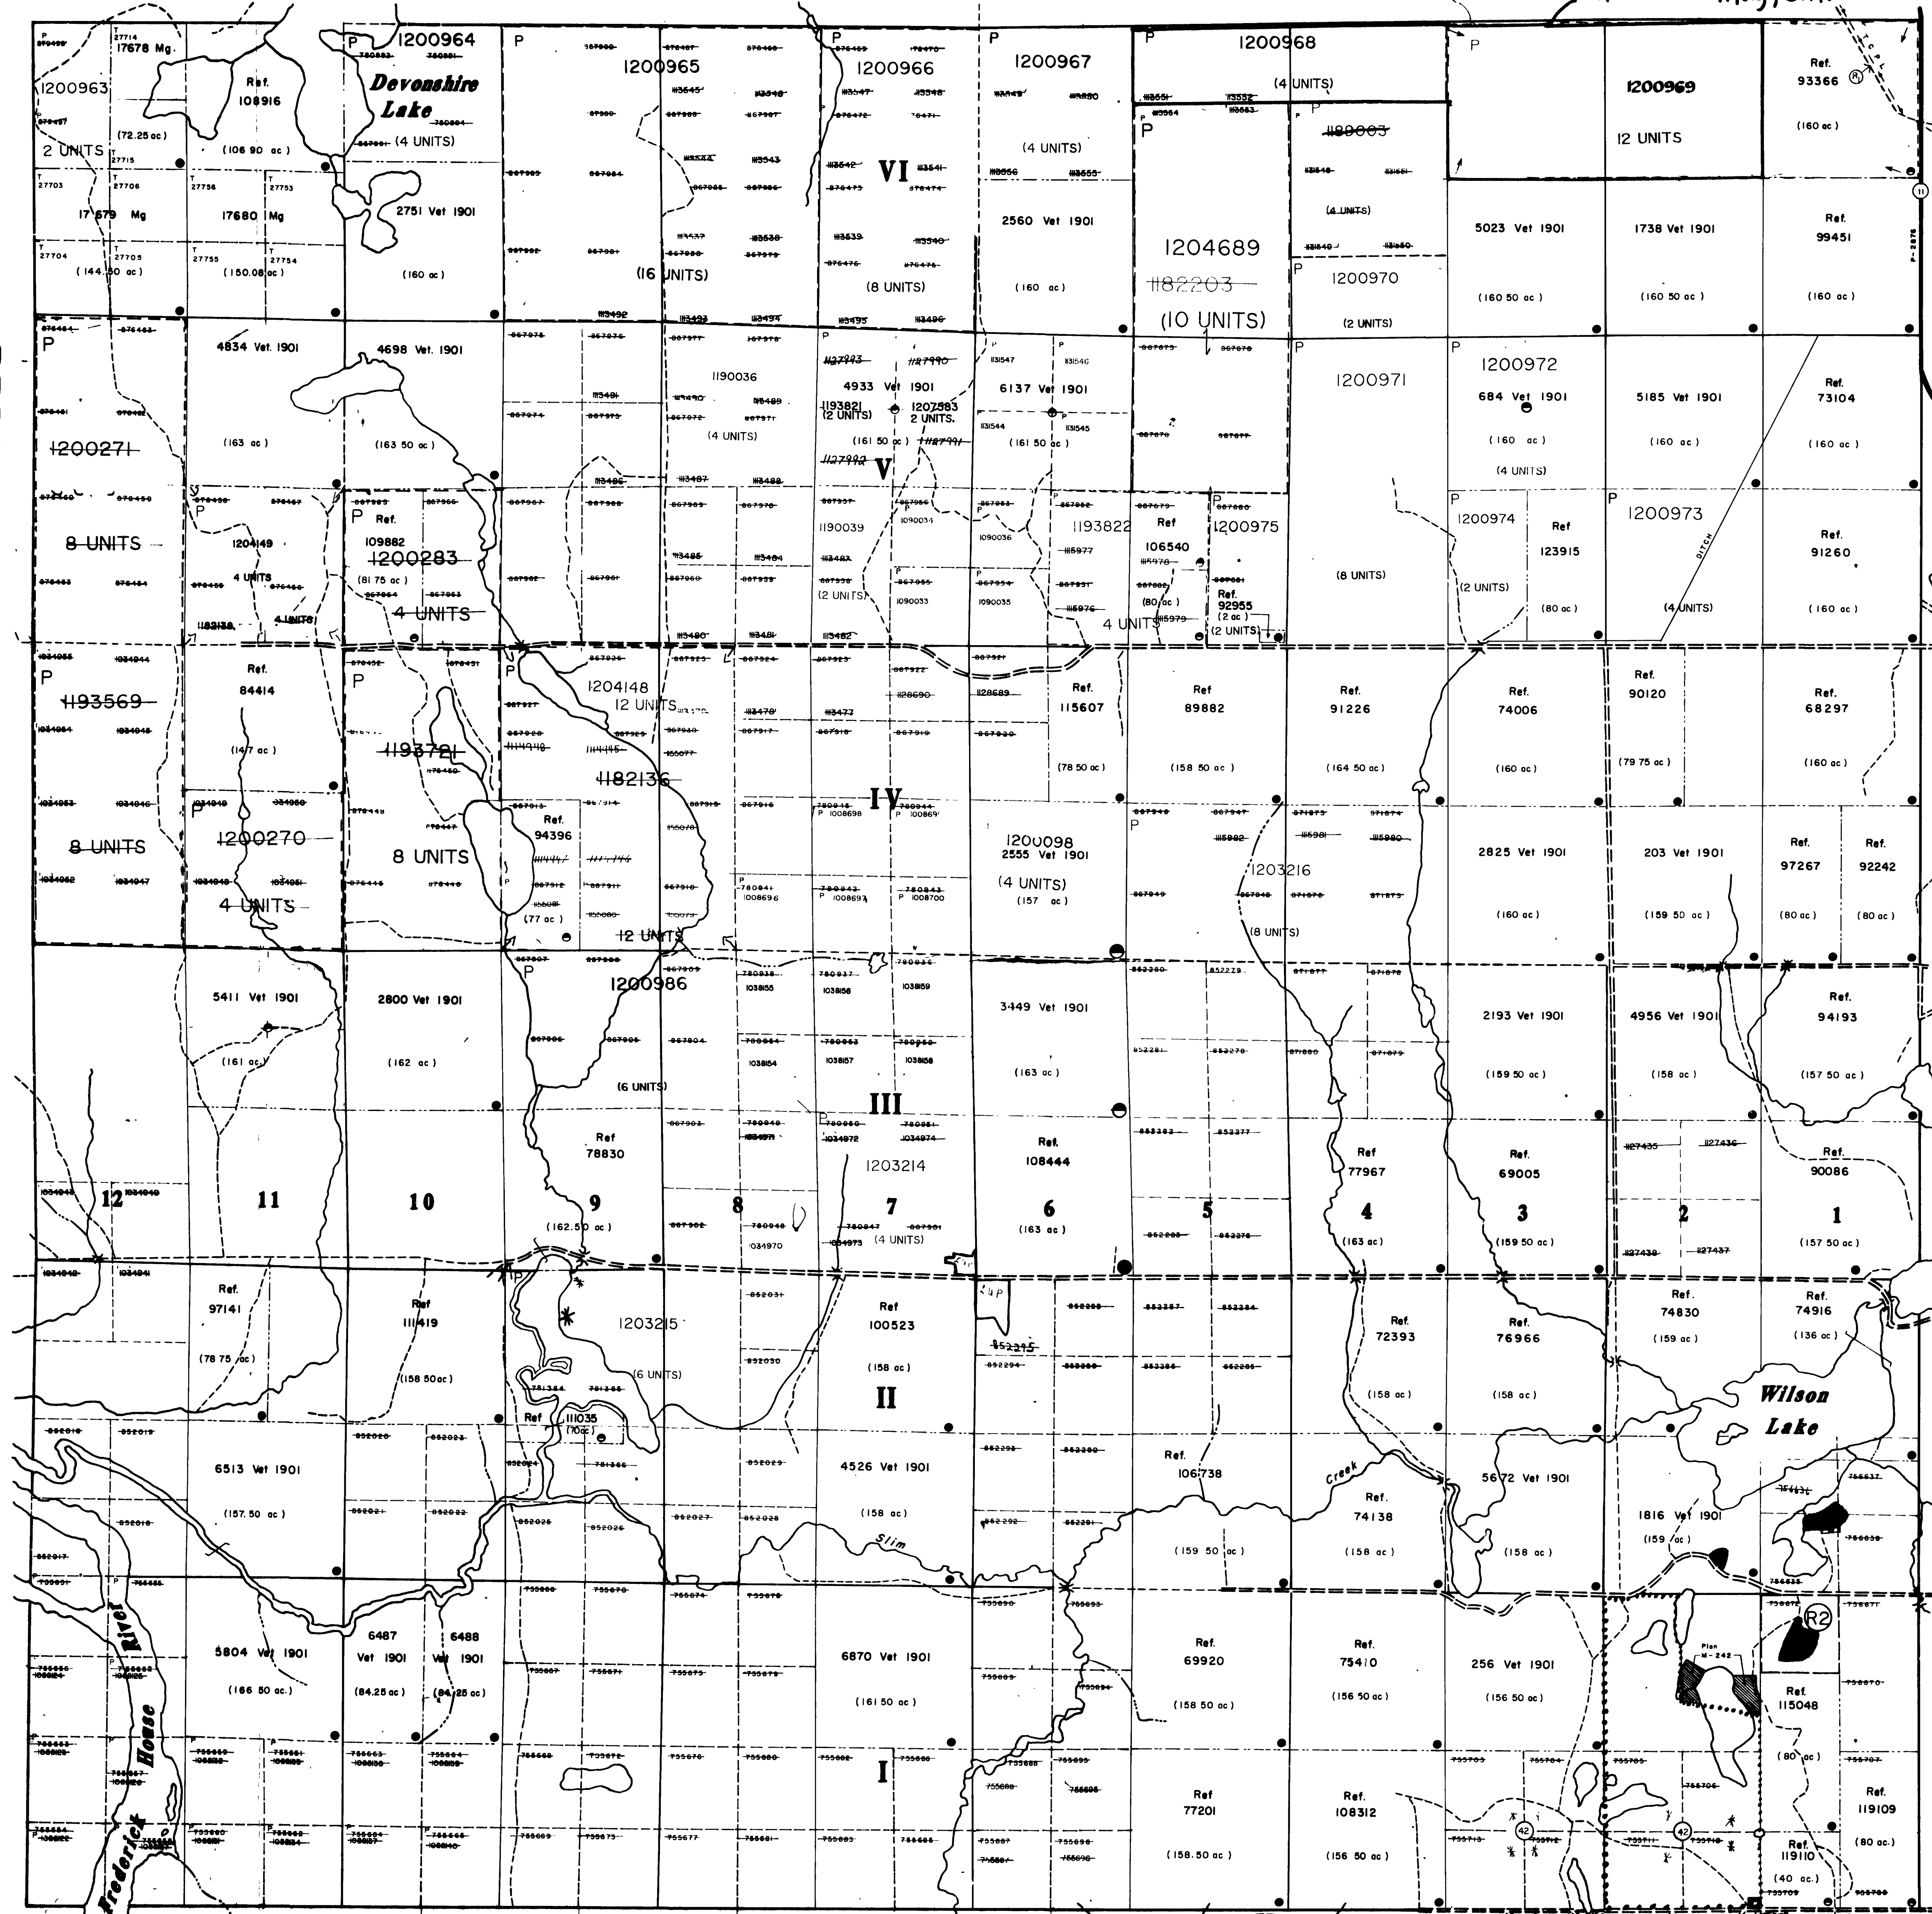

CALVERT TOWNSHIP OF

TOPOGRAPHY
 LAKES, RIVERS, ETC., FROM FOREST RESOURCES INVENTORY SHEETS 127804
ISSUED
 DEC 13 1995
SURVEYS
 TOWNSHIP OF McCART SUBDIVIDED BY A.D. GRIFFIN, O.L.S., 1904. FIELD NOTE BOOK 1533.
 WEST LIMIT OF McCART TOWNSHIP (SEE LITTLE TWP) SURVEY BY J.W. FITZGERALD, O.L.S., 1904. FIELD NOTE BOOK 1402.
 EAST LIMIT OF McCART TOWNSHIP (SEE CALVERT TWP) SURVEY BY ALEXANDER BAIRD, O.L.S., 1904. FIELD NOTE BOOK 1009.
 THIRD MERIDIAN (EAST LIMIT OF McCART TWP) BY WILLIAM GALBRAITH, O.L.S., 1904. FIELD NOTE BOOK 2363.
 BASE LINE (SOUTH LIMIT OF McCART TWP) BY T.J. PATTEN, O.L.S., 1903. FIELD NOTE BOOK 2460.

LEGEND

HIGHWAY AND ROUTE No	
OTHER ROADS	
TRAILS	
SURVEYED LINES	
TOWNSHIPS, BASE LINES, ETC	
LOTS, MINING CLAIMS, PARCELS, ETC	
UNSURVEYED LINES:	
LOT LINES	
PARCEL BOUNDARY	
MINING CLAIMS ETC	
RAILWAY AND RIGHT OF WAY	
UTILITY LINES	
NON-PERENNIAL STREAM	
FLOODING OR FLOODING RIGHTS	
SUBDIVISION OR COMPOSITE PLAN	
RESERVATIONS	
ORIGINAL SHORELINE	
MARSH OR MUSKEG	
MINES	
TRAVERSE MONUMENT	

DISPOSITION OF CROWN LANDS

TYPE OF DOCUMENT	SYMBOL
PATENT, SURFACE & MINING RIGHTS	
SURFACE RIGHTS ONLY	
MINING RIGHTS ONLY	
LEASE, SURFACE & MINING RIGHTS	
SURFACE RIGHTS ONLY	
MINING RIGHTS ONLY	
LICENCE OF OCCUPATION	
ORDER-IN-COUNCIL	
RESERVATION	
CANCELLED	
SAND & GRAVEL	
L. U. P.	

NOTE: MINING RIGHTS IN PARCELS PATENTED PRIOR TO MAY 1, 1912, VESTED IN ORIGINAL PATENTEE BY THE PUBLIC LANDS ACT, R.S.O. 1978, CHAP. 290 SEC. 63 SUBSEC. 1. SEE SKETCH WITHIN BOUNDARY.

SCALE: 1 INCH = 20 CHAINS

FEET 0 1000 2000 4000 6000 8000
 METRES 0 1000 2000 4000 6000 8000

TOWNSHIP
McCART
 M.N.R. ADMINISTRATIVE DISTRICT
COCHRANE
 MINING DIVISION
PORCUPINE
 LAND TITLES / REGISTRY DIVISION
COCHRANE

Ministry of Natural Resources and Mines
 Ministry of Northern Development and Mines

Date: JULY 1986
 Number: G-3541

THE INFORMATION THAT APPEARS ON THIS MAP HAS BEEN COMPILED FROM VARIOUS SOURCES, AND ACCURACY IS NOT GUARANTEED. THOSE WISHING TO STAKE MINING CLAIMS SHOULD CONSULT WITH THE MINING

TOWNSHIP OF DUNDONALD

800 NORTH

600 NORTH

400 NORTH

200 NORTH

1200968

0 4 Units

1100 WEST

1000 WEST

900 WEST

800 WEST

700 WEST

600 WEST

500 WEST

400 WEST

300 WEST

200 WEST

100 WEST

1200998

16 Units

800 NORTH

600 NORTH

400 NORTH

200 NORTH

1200969

12 Units

1100 WEST

1000 WEST

900 WEST

800 WEST

700 WEST

600 WEST

500 WEST


400 WEST

300 WEST

200 WEST

100 WEST

MAX-MIN 11

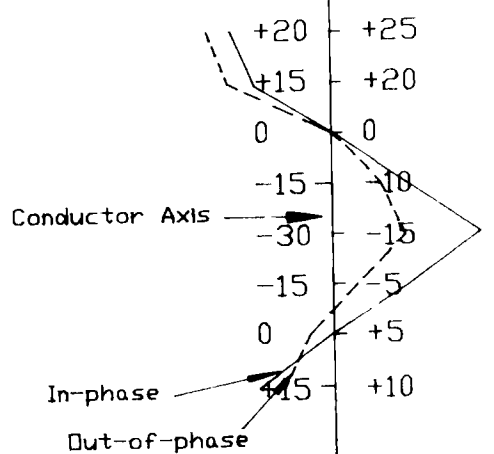

LEGEND

Instrument: Apex Parametrics Max-Min 11
 Mode: Maximum Coupled, Horizontal Loop Survey
 Parameters Measured: Inphase (%)
 Out of phase (%)
 Frequency: 444 Hz
 Coil Separation: 150m

42A15SW0018 2 16313 MCCART

CON I

NEWMARKET TWP

Mc CART TWP



RECEIVED

DEC 20 1995

2.16313

MINING LANDS BRANCH

CON VI

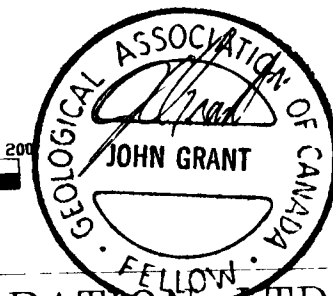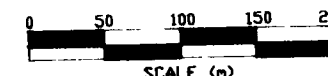

EXSICS EXPLORATION LTD.

P.O. Box 1880, P4N-7X1
 Suite 13, Hollinger Bldg, Timmins Ont
 Telephone 705-267-4151

CLIENT: FALCONBRIDGE LIMITED

PROPERTY: MANN BELT PN# 8269

TITLE: NEWMARKET TWP NEW95-02

MAX-MIN II 444 Hz

Date: Sept. 1995	Scale: 1:5000	NTS:
Drawn: P. Gauthier	Interp: J.C. Grant	Job No.: E-124



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LOT 5


LOT 4

LOT 3

1100 WEST 1000 WEST 900 WEST 800 WEST 700 WEST 600 WEST 500 WEST 400 WEST 300 WEST 200 WEST 100 WEST

800 NORTH
600 NORTH
400 NORTH
200 NORTH

1200998
16 Units

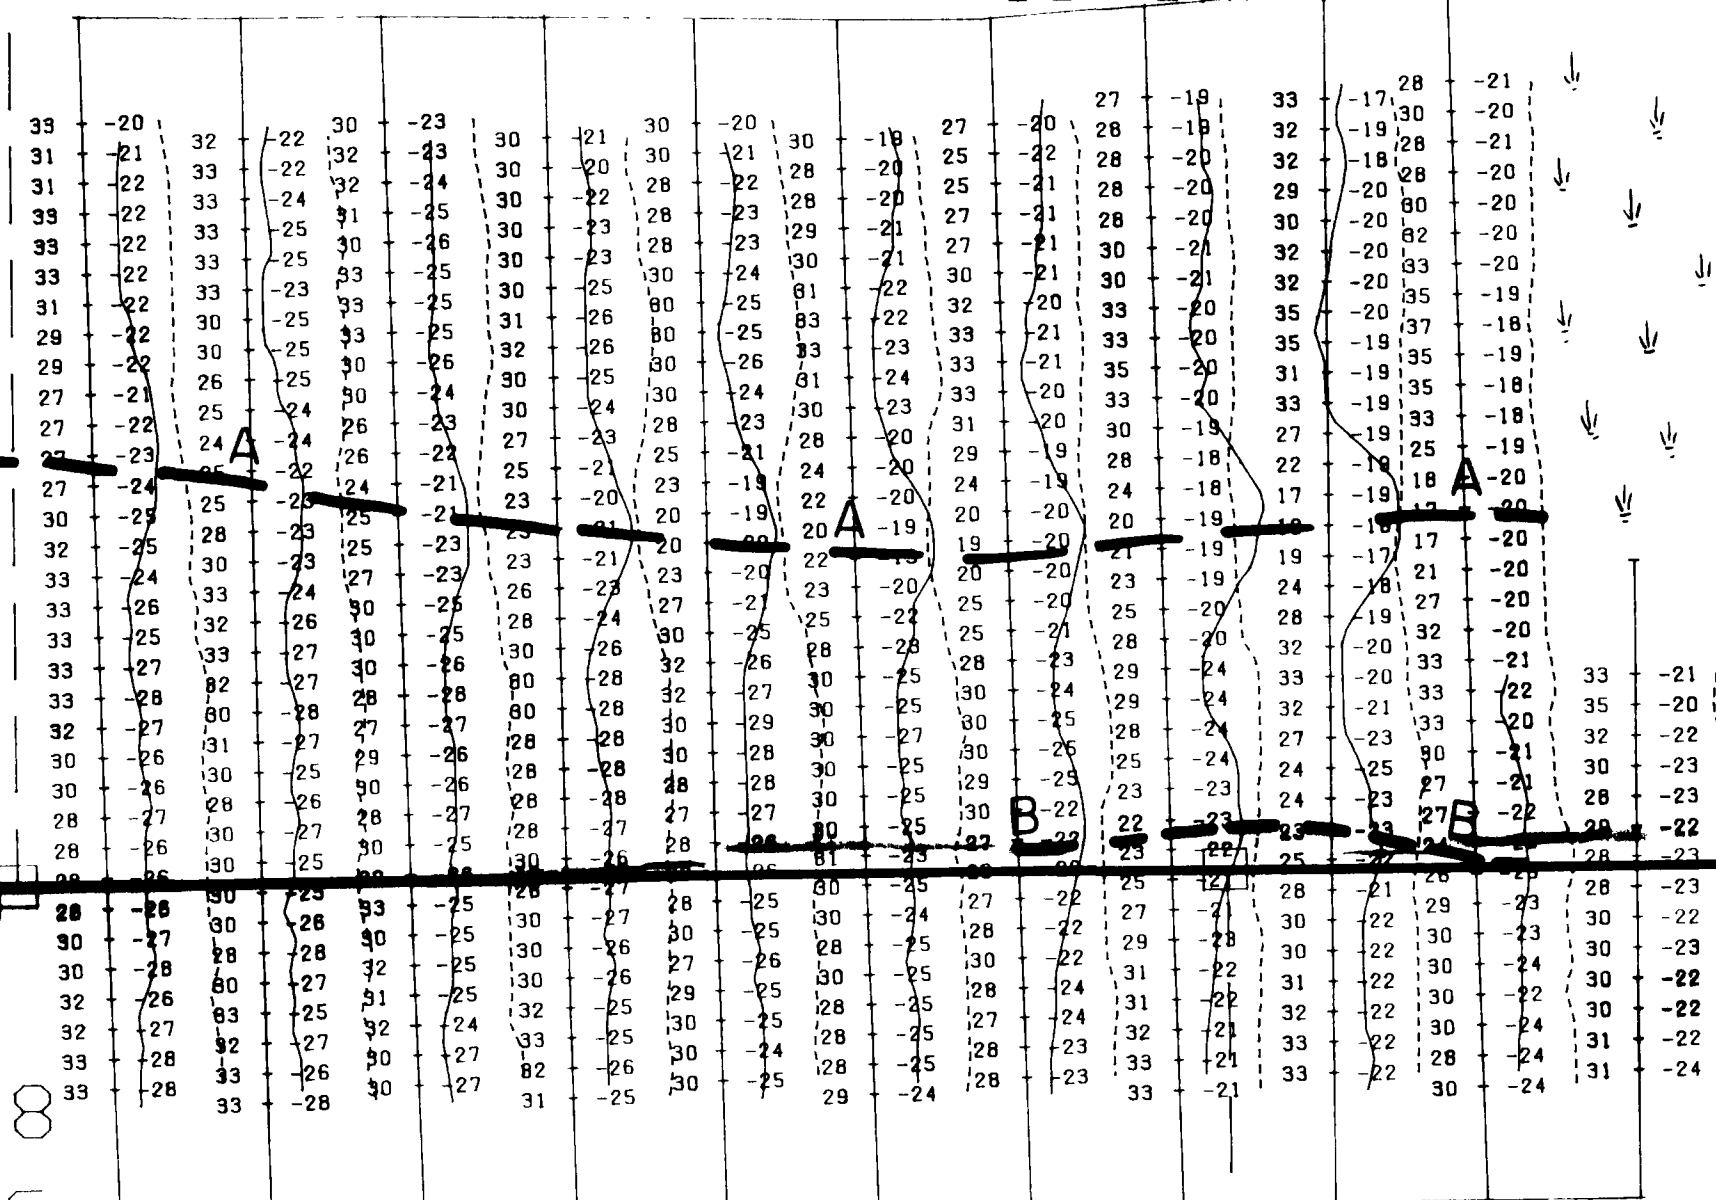

1200968
4 Units


NEWMARKET TWP
Mc CART TWP
2.16313 RECEIVED
DEC 20 1995
MINING LANDS BRANCH



230

1200969
12 Units

CON VI
GEOLOGICAL ASSOCIATION OF CANADA
JOHN GRANT
FELLOW

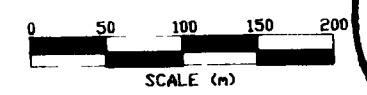

EXSICS EXPLORATION LTD.
P.O. Box 1880, P4N-7X1
Suite 13, Hollinger Bldg. Timmins Ont
Telephone 705-267-4151


CLIENT: FALCONBRIDGE LIMITED
PROPERTY: MANN BELT PN# 8269
TITLE: NEWMARKET TWP NEW95-02
MAX-MIN II 1777 Hz

Date: Sept 1995 Scale: 1:5000 NTS.
Drawn: P.Gauthier Interp: J.C.Grant Job No.: E-124

LEGEND

Instrument: Apex Parametrics Max-Min II
Mode: Maximum Coupled, Horizontal Loop Survey
Parameters Measured: In-phase (%)
Out of phase (%)

Frequency: 1777 Hz
Coil Separation: 150m

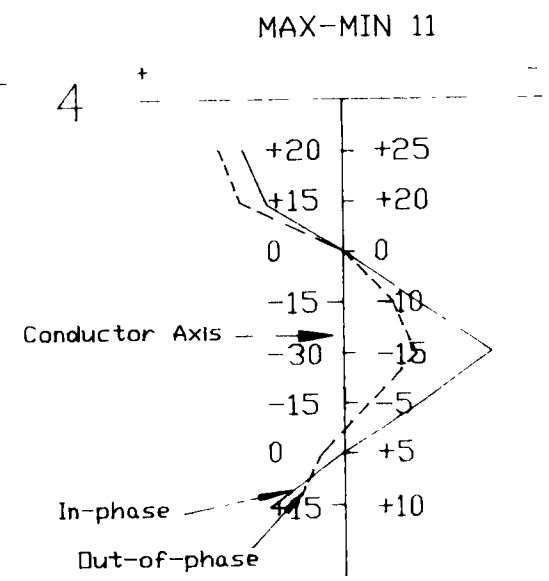

42A155W0018 2 16313 MCCART

1100 WEST 1000 WEST 900 WEST 800 WEST 700 WEST 600 WEST 500 WEST 400 WEST 300 WEST 200 WEST 100 WEST

1200998

16 Units

800 NORTH

800 NORTH

600 NORTH

600 NORTH

400 NORTH


400 NORTH

200 NORTH

200 NORTH

1200968

4 Units

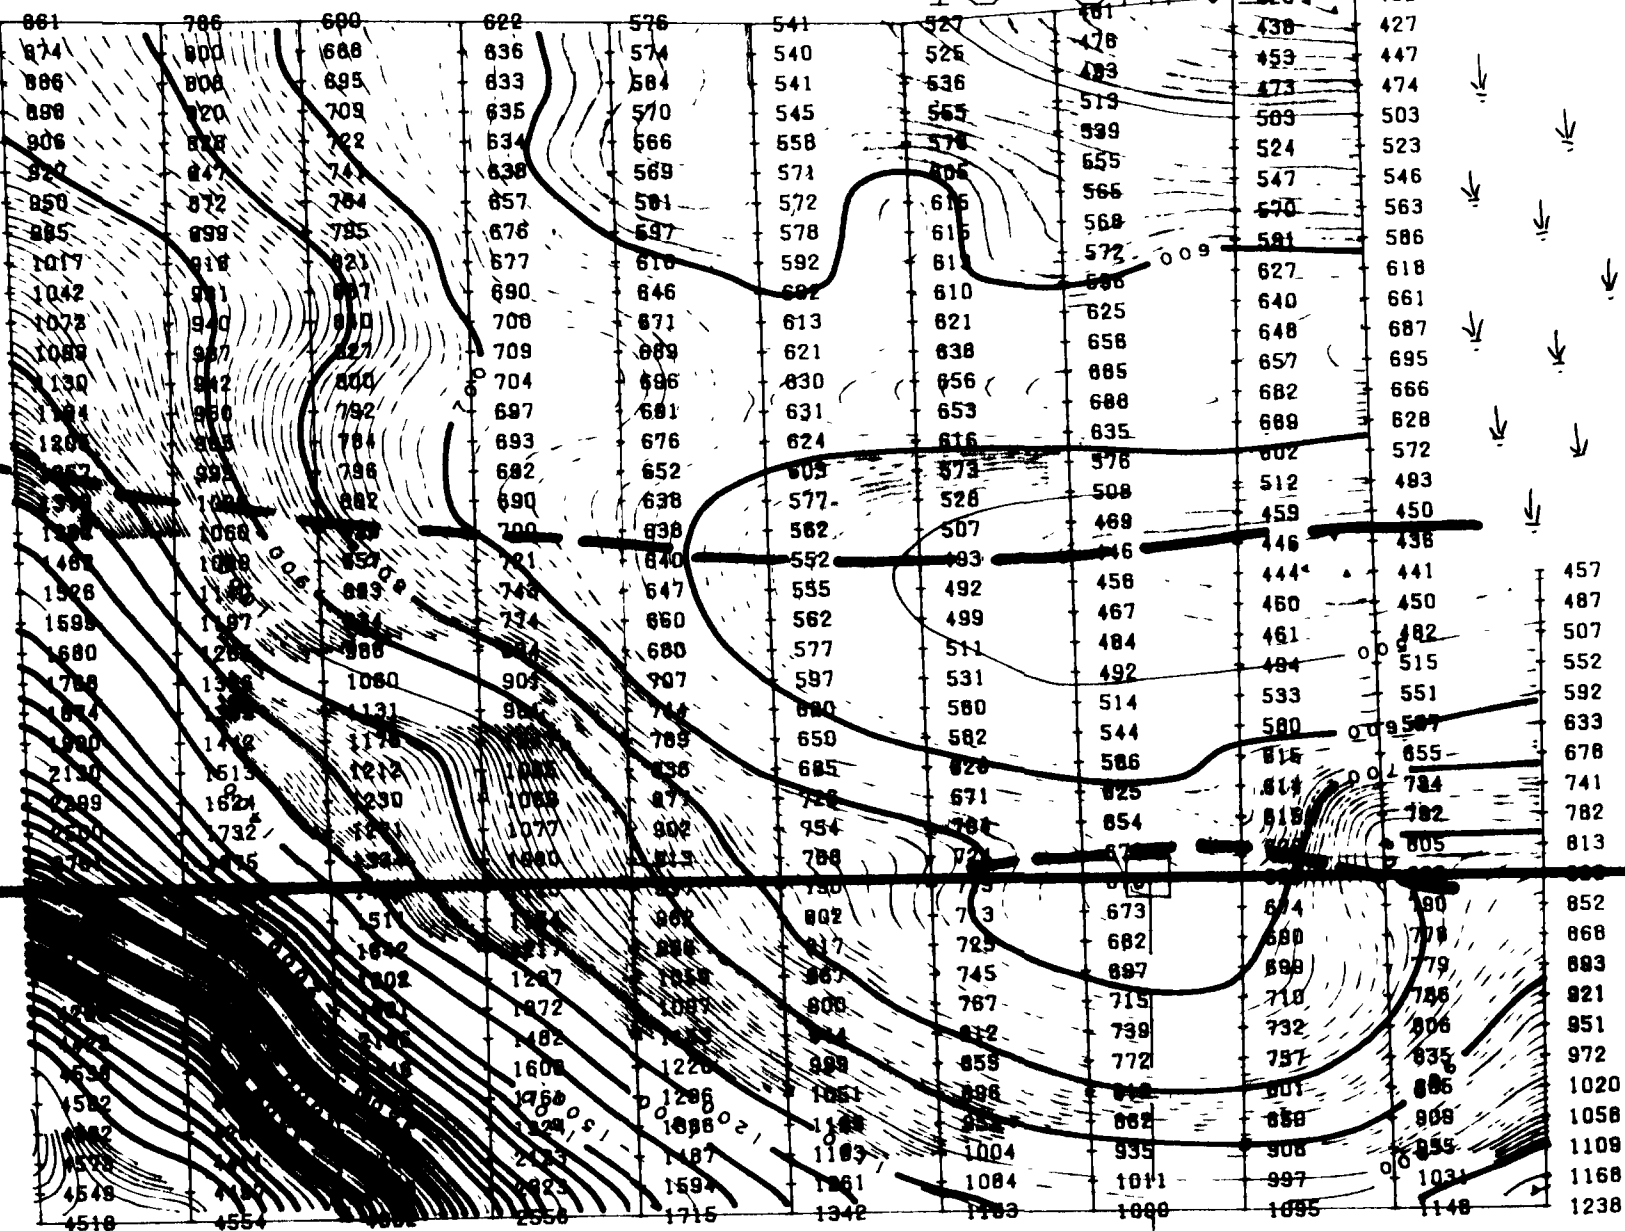

CON I

NEWMARKET TWP

Mc CART TWP

RECEIVED

216313

DEC 20 1995

MINING LANDS BRANCH

CON VI

1200969


12 Units

1100 WEST 1000 WEST 900 WEST 800 WEST 700 WEST 600 WEST 500 WEST 400 WEST 300 WEST 200 WEST 100 WEST

LOT 5

LOT 4

LOT 3

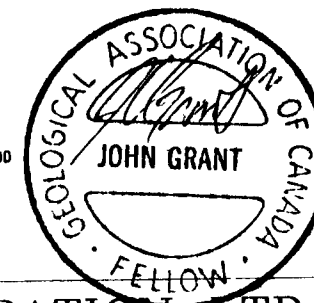

EXSICS EXPLORATION LTD.

P O Box 1880, P4N-7X1
Suite 13, Hollinger Bldg, Timmins Ont.
Telephone: 705-267-4151

CLIENT: FALCONBRIDGE LIMITED

PROPERTY: MANN BELT PN# 8269

TITLE: NEWMARKET TWP NEW95-02

MAGNETOMETER SURVEY

Date: Sept. 1995 Scale: 1:5000 NTS:
Drawn: P. Gauthier Interp: J.C. Grant Job No.: E-124

LEGEND

Instrument: EDA OMNI-1V
Parameters Measured: Earth's total magnetic field
Accuracy: +/- 1 nano-teslas
Diurnals: Corrected by base station recorder

42A155W0048 2 16313 NEWMARKET

240

42A155W0018 2 16313 MCCART