



42C16NE8231 24 HAWKINS

DIAMOND DRILLING

TOWNSHIP: HAWKINS TWP.

REPORT NO: 24

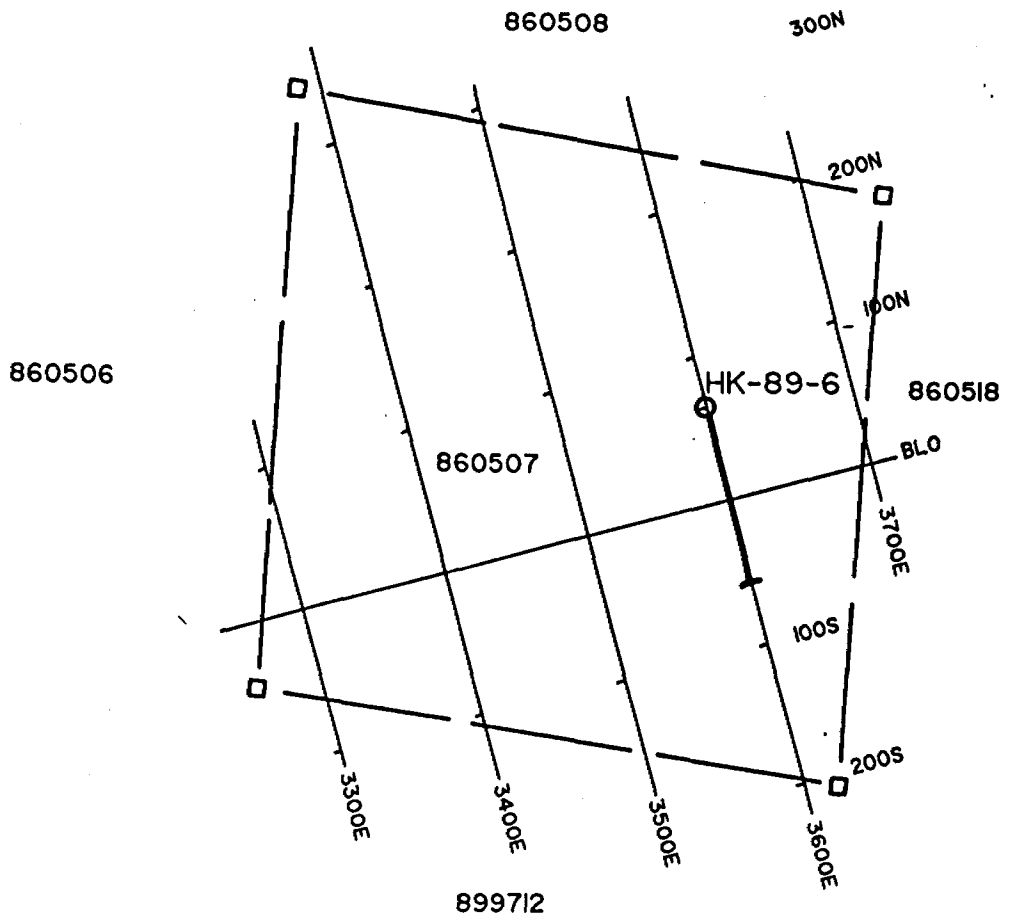
WORK PERFORMED FOR: Goldfields Canadian Mining Ltd.

RECORDED HOLDER: SAME AS ABOVE (xx)

: OTHER ()

<u>CLAIM NO.</u>	<u>HOLE NO.</u>	<u>FOOTAGE</u>	<u>DATE</u>	<u>NOTE</u>
P 860507	HK-89-6	506'	Sept/88	(1)(2)
P 899711	HK-89-7	356'	Sept/89	(1)(2)
P 860507	HK-89-8	356'	Sept/89	(1)(2)
P 888658/ P 888610	HK-89-9	506'	Sept/89	(1)(2)
P 888611	HK-89-10	256'	Sept/89	(1)(2)
	HK-89-11	336'	Sept/89	(1)(2)
P 888657	HK-89-12	505'	Sept/89	(1)(2)
P 889158	HK-89-13	256'	Sept/89	(1)(2)

NOTES: (1) # W8905.002, filed Jan/90
 (2) comparable to OMIP submission OM 89-10
 filed July 18/90.



ONTARIO GEOLOGICAL SURVEY
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DURHAM GEOLOGICAL SERVICES INC.		
For: AURLOT EXPLORATION LTD.		
Title: HK-89-6		
Date: SEPT 89	Drawn: C.G.	Scale: 1:5000
NTS: 42C,42F	Approved:	Fig.:

Durham Geological Services Inc.
P.O. Box 1330
Timmins, Ontario
P4N 7J8

DIAMOND DRILL HOLE LOG

PROJECT: Aurlot Exploration

AREA: Hawkins Township

CLAIM NUMBER: P 860507

CORE SIZE: BQ

DRILLED BY: Alexandre Drilling Inc.

LOGGED BY: H. Lahti

CORE STORED AT: Oba

OBJECTIVE: Test IP Anomaly and Geology

HOLE NUMBER: HK-89-6

LOCATION: L36E/0+65N

AZIMUTH: 165°

DIP: -45° S

DATES: Sept 9th - 12th

CASING: 1.2m

LENGTH: 154.3m

DIP TESTS: 0=45°, 45.7= 40°, 78.0=35°, 129=33°
154=31°

DURHAM
GEOLOGICAL
SERVICES INC.

DIAMOND DRILL HOLE LOG

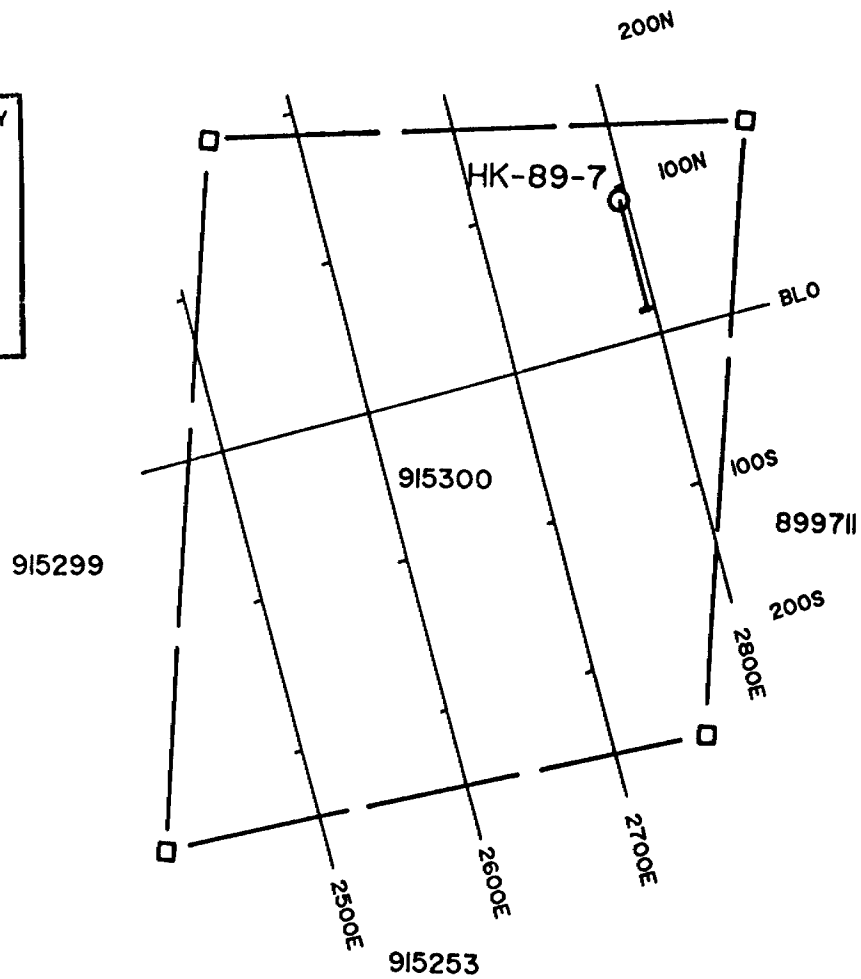
METERAGE		ROCK TYPE AND DESCRIPTION	Core Angle to Axis	% Sulphides	SAMPLE				ANALYTICAL RESULT					
From	To				Number	From	To	Length (m)	Au ppb	As ppm	Pb ppm	Zn ppm	Cu ppm	Ag ppm
		seams up to 10cm thick, pure white	55°											
16.70	16.90	MAFIC TUFF - silicified pyrite, 2-3% hornblende-biotite		2-3%	15983	16.70	16.90	0.20	4		2	75	26	0.6
16.90	17.65	FELSIC TUFF; cherty, pale grey, fine grained, grades into more mafic unit -minor fine grained sericite												
17.65	19.05	MAFIC TUFF -hornblende, biotite, disseminated pyrite - slightly magnetic (trace magnetite-pyrrhotite)		2-3% trace	15984 15991	17.65 19.05	19.05 20.5	1.4 1.45	3 3		2 7	59 40	77 33	1.0 1.4
19.05	44.80	QUARTZ SERICITE SCHIST -black to pale grey, sheared laminated -locally pyritic, averages 1-2% (locally 4-6%) some more mafic bands but minor -originally a felsic tuff - numerous quartz seams 2-6cm thick	60°	2-3% 2-3% 2-3% 1-2%	15985 15986 15987 15988	20.5 21.7 23.8 24.4	21.7 23.8 24.4 25.6	1.2 2.1 0.6 1.2	67 8 5 5		18 4 3 5	190 130 55 40	41 38 30 40	8.0 2.0 1.2 2.4

DIAMOND DRILL HOLE LOG

METERAGE		ROCK TYPE AND DESCRIPTION	Core Angle to Axis	% Sulphides	SAMPLE			ANALYTICAL RESULT						
From	To				Number	From	To	Length (m)	Au ppb	As ppm	Pb ppm	Zn ppm	Cu ppm	Ag ppm
144.9	145.1	PORPHYRY DYKE -feldspar crystals, some biotite												
145.1	146.95	FELSIC TUFF -parts cherty, fine grained subtle banding, minor muscovite												
146.95	148	MAFIC TUFF -hornblende, fine grained, thinly laminated												
148	148.8	FELSITE -fine grained, mainly quartz with fine grained muscovite (sericite)												
148.8	154.3	MAFIC TUFF -fine grained, finely laminated, mainly hornblende, erratic disseminated pyrite <1%		<1%	15997	148.8	149.8	1	<3		<1	50	120	<0.2
		porphyry dyke 149.8-150.2 grey with vauge feldspar crystals, altered, sheared some biotite		<1%	15998	150.2	151.2	1	<3		1	38	54	<0.2
		END OF HOLE Virtually 100% core recovery												

Howard Smith

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DURHAM GEOLOGICAL SERVICES INC.		
For: AURLOT EXPLORATION LTD.		
Title: HK-89-7		
Date: SEPT 89	Drawn: C.G.	Scale: 1:5000
NTS: 42C,42F	Approved:	Fig.:

Durham Geological Services Inc.
P.O. Box 1330
Timmins, Ontario
P4N 7J8

DIAMOND DRILL HOLE LOG

PROJECT: Aurlot Exploration

AREA: Hawkins Township

CLAIM NUMBER: P 899711

CORE SIZE: BQ

DRILLED BY: Alexandre Drilling

LOGGED BY: H. Lahti

CORE STORED AT: Oba

OBJECTIVE: Test IP Anomaly & Geology

HOLE NUMBER: HK-89-7

LOCATION: L28+95E/0+90N

AZIMUTH: 165°

DIP: -45° S

DATES: Sept 13 - 14

CASING: 1.2m

LENGTH: 108.5m

DIP TESTS: 0m =45°, 48m =37°, 78m=34°
109m =28°

DIAMOND DRILL HOLE LOG

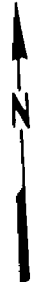
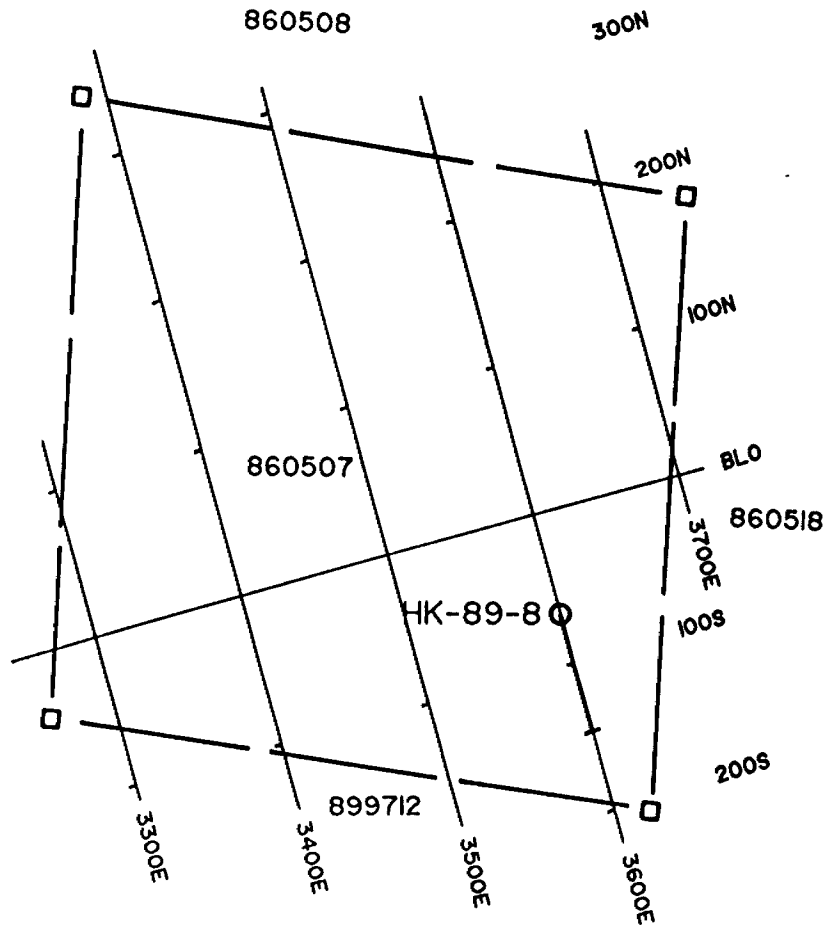
METERAGE		ROCK TYPE AND DESCRIPTION	Core Angle to Axis	% Sulphides	SAMPLE				ANALYTICAL RESULT					
From	To				Number	From	To	Length (m)	Au ppb	As ppm	Pb ppm	Zn ppm	Cu ppm	Ag ppm
71.4	93.3	QUARTZ SERICITE SCHIST		<1%	19190	73.3	75	1.7	7		2	92	40	0.8
		-some mafic bands (amphibolite)		1%	19191	75	76.6	1.6	3		4	70	35	0.8
		-highly altered felsic tuff and intermediate intrusive		1-2%	19192	76.6	78	1.4	<3		2	60	34	0.8
		-mafic alteration to brown biotite,		1%	19193	78	79.5	1.5	5		4	66	39	1.0
		-rare k-spar crystals 1-2% sulphides		1-2%	19194	79.5	81	1.5	4		2	104	40	1.6
		mainly along shear planes - pervasive		1-2%	19195	84.7	86.2	1.5	<3		2	102	35	0.8
		yellow-green alteration in thin bands		1-2%	19196	86.2	87.2	1	<3		4	106	40	0.8
		-fine grained		<1%	19197	87.2	88.7	1.5	10		2	50	36	0.8
		-erratic py, po 1% magnetic where po. found		1-2%	19198	88.7	90.2	1.5	<3		4	90	39	1.0
				1%	19199	90.2	91.7	1.5	12		4	54	45	1.8
				1%	19200	91.7	93.3	1.6	<3		2	94	45	0.6
		*Note - 71.4m onwards may be highly altered (sericitized) and silicified margin of the granodiorite intrusive with felsic bands												
93.3	108.5	QUARTZ SERICITE SCHIST	70°	1-7%	15001	93.3	94.8	1.5	5		4	66	42	0.8
		-parts derived from granodiorite intrusive with sericite, weakly pyritized		1-7%	15002	94.8	95.6	1	49		2	240	40	0.8
		felsic dykes 96.8-97.2, fine grained		1-7%	15003	95.6	96.8	1.2	11		2	50	42	0.8
		greenish, siliceous with sericite alteration		1-7%	15004	97.2	99.6	2.4	<3		2	88	38	0.6
				1-7%	15005	99.6	101.1	1.5	<3		2	64	34	0.4

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860506



DURHAM GEOLOGICAL SERVICES INC.

For: AURLOT EXPLORATION LTD.

Title: HK-89-8

Date: SEPT 89 Drawn: C.G. Scale: 1:5000

NTS: 42C,42F Approved: Flg:

Durham Geological Services Inc.
P.O. Box 1330
Timmins, Ontario
P4N 7J8

DIAMOND DRILL HOLE LOG

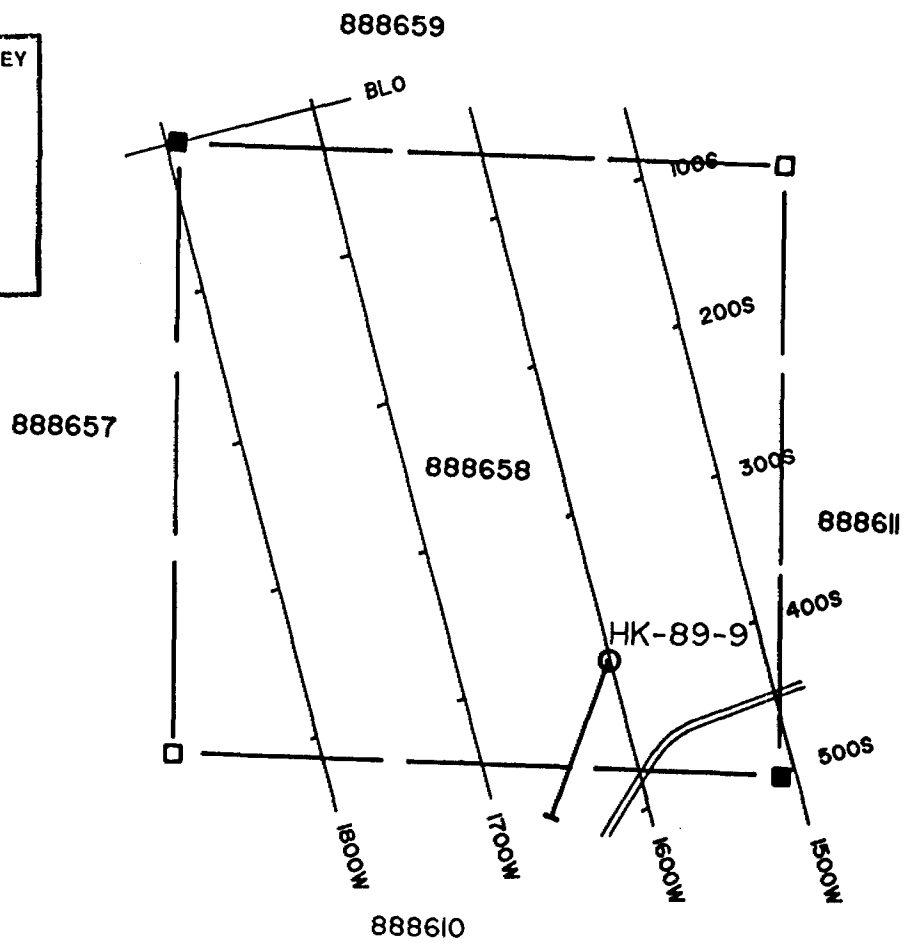
PROJECT: Aurlot Exploration
AREA: Hawkins Township
CLAIM NUMBER: P 860507
CORE SIZE: BQ
DRILLED BY: Alexandre Drilling Inc.
LOGGED BY: H. Lahti
CORE STORED AT: Oba
OBJECTIVE: Test IP Anomaly and Geology
(contact with Granodiorite)

HOLE NUMBER: HK-89-8
LOCATION: L36E/0+65S
AZIMUTH: 165°
DIP: -45°S
DATES: Start Sept 11 Stop Sept. 12
CASING: 1.2m
LENGTH: 108.5 m
DIP TESTS: 0=45°, 30m=40°, 62.8m=35°, 109m =30°

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DURHAM GEOLOGICAL SERVICES INC.

For: AURLOT EXPLORATION LTD.

Title: HK-89-9

Date: SEPT 89	Drawn: C.G.	Scale: 1:5000
NTS: 42C,42F	Approved:	Fig:

Durham Geological Services Inc.
P.O. Box 1330
Timmins, Ontario
P4N 7J8

DIAMOND DRILL HOLE LOG

PROJECT: Aurlot Exploration
AREA: Hawkins Township
CLAIM NUMBER: P 888658, P 888610
CORE SIZE: BQ
DRILLED BY: Alexandre Drilling
LOGGED BY: H. Lahti
CORE STORED AT: Oba
OBJECTIVE: Test IP, Geochem Anomaly
Au, Cu, Zn

HOLE NUMBER: HK-89-9
LOCATION: L16+00W/400S
AZIMUTH: 200°
DIP: -45° S
DATES: Sept 18 - 20
CASING: 3m
LENGTH: 154.3m
DIP TESTS: 0m = 45°, 62m=44°, 93m = 37°,
124m =30°, 154m = 27°

DIAMOND DRILL HOLE LOG

METERAGE		ROCK TYPE AND DESCRIPTION	Core Angle to Axis	% Sulphides	SAMPLE				ANALYTICAL RESULT					
From	To				Number	From	To	Length (m)	Au ppb	As ppm	Pb ppm	Zn ppm	Cu ppm	Ag ppm
24.1	33.8	MAFIC TUFF	45°											
		-highly sheared some silicification and epidotization especially at contact with above unit												
33.8	37.2	MAFIC FLOW	50°	trace	15008	34.4	35.2	.8	<3		4	132	81	<0.2
		-sheared, dark grey, fine to medium grained with silica rich bands -blebs, trace sulphides - sections rich in garnets e.g. 36.2-37.2m - coarse grained, -pink		1%	15009	35.2	37.2	2	<3		4	106	85	<0.2
				1%	15010	38.4	40.7	2.3	<3		2	80	72	<0.2
37.2	42.5	MAFIC FLOW		5%	15011	40.4	41.1	0.4	<3		280	260	260	<0.2
		-some brecciation - dark green, fine grained areas with more severe shearing -silicified with rare white quartz veinlets - galena (Pb) disseminated at 41.0m		1%	15012	41.1	42.5	1.4	<3		10	280	110	<0.2
				3%	15013	42.5	43.3	0.8	7		12	220	250	0.2
42.5	44.0	BRECCIA		5-10%	15014	43.3	44.0	0.7	3		32	1500	330	1.2
		-shear zone - silica, chlorite locally (2-5cm) semi-massive pyrite			15015	44.0	44.95	0.95	<3		6	178	70	<0.2
					15016	44.95	47.0	2.05	<3		2	100	71	<0.2

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GEOLOGICAL
SERVICES INC.

DIAMOND DRILL HOLE LOG

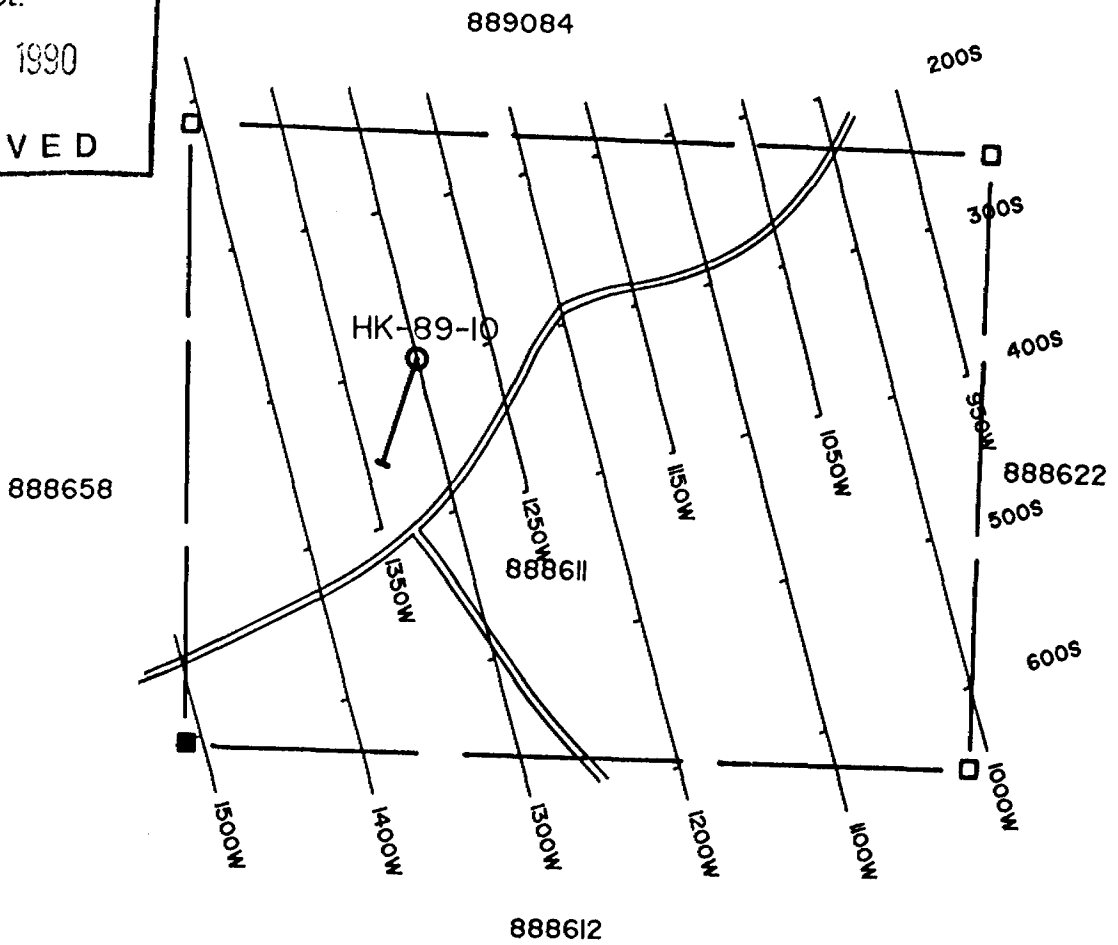
METERAGE		ROCK TYPE AND DESCRIPTION	Core Angle to Axis	% Sulphides	SAMPLE				ANALYTICAL RESULT				
From	To				Number	From	To	Length (m)	Au ppb	As ppm	Pb ppm	Zn ppm	Cu ppm
143.3	144.0	GRANODIORITE DYKE											
		-coarse grained, little shearing											
		-silicified -saueritized, some biotite											
144.0	154.3	MAFIC FLOW	70°										
		-fine grained massive dark green to											
		black, minor silica carbonate stringers											
		-minor brecciation											
		END OF HOLE											
		Virtually 100% Core Recovery											

Howard Latta

ONTARIO GEOLOGICAL SURVEY
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DURHAM GEOLOGICAL SERVICES INC.		
For:	AURLOT EXPLORATION LTD.	
Title:	HK-89-10	
Date: SEPT 89	Drawn: C.G.	Scale: 1:5000
NTS: 42C,42F	Approved:	Fig.:

Durham Geological Services Inc.
P.O. Box 1330
Timmins, Ontario
P4N 7J8

DIAMOND DRILL HOLE LOG

PROJECT: Aurlot Exploration

AREA: Hawkins Township

CLAIM NUMBER: P 888611

CORE SIZE: BQ

DRILLED BY: Alexandre Drilling Inc.

LOGGED BY: H. Lahti

CORE STORED AT: Oba

OBJECTIVE: Test IP & VLF Anomaly

HOLE NUMBER: HK-89-10

LOCATION: L13+00W 300S

AZIMUTH: 200°

DIP: -45°S

DATES: Sept. 21/89 (Set up Sept. 20th)

CASING: 3M

LENGTH: 78M

DIP TESTS: 0M=45°, 32M=38°, 78M=35°

DIAMOND DRILL HOLE LOG

METERAGE		ROCK TYPE AND DESCRIPTION	Core Angle to Axis	% Sulphides	SAMPLE			ANALYTICAL RESULT					
From	To				Number	From	To	Length (m)	Au ppb	As ppm	Pb ppm	Zn ppm	Cu ppm
59.8	67.5	ANDESITE											
		-pale green to medium grey											
		-some fragments totally altered to chlorite - very soft											
		-fault at 62.6 with pale green chlorite and quartz											
67.5	74.5	MASSIVE MAFIC FLOW											
		-fine grained to coarse grained possibly altered & sheared dyke											
74.5	78	ANDESITE											
		-medium greenish-grey fine grained massive											
		END OF HOLE											

Howard Latta

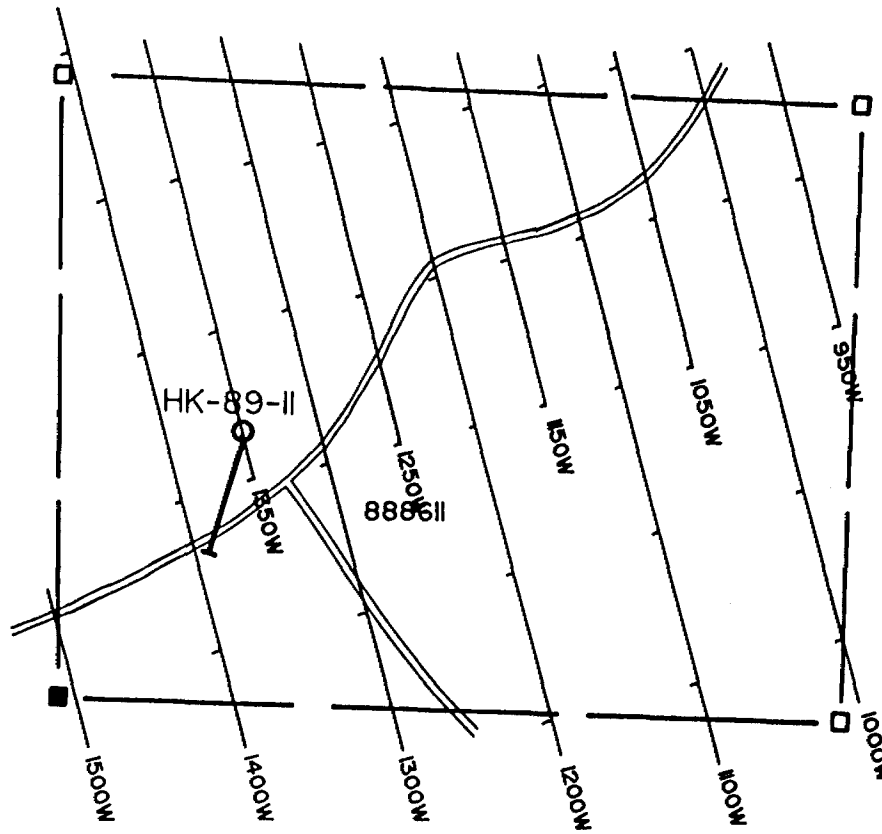
889084

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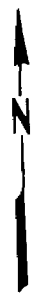
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888658



888622

888612



DURHAM GEOLOGICAL SERVICES INC.

For: AURLOT EXPLORATION LTD.

Title:
HK-89-II

Date: SEPT 89 Drawn: C.G. Scale: 1:5000

NTS: 42C,42F Approved: Fig:

Durham Geological Services Inc.
P.O. Box 1330
Timmins, Ontario
P4N 7J8

DIAMOND DRILL HOLE LOG

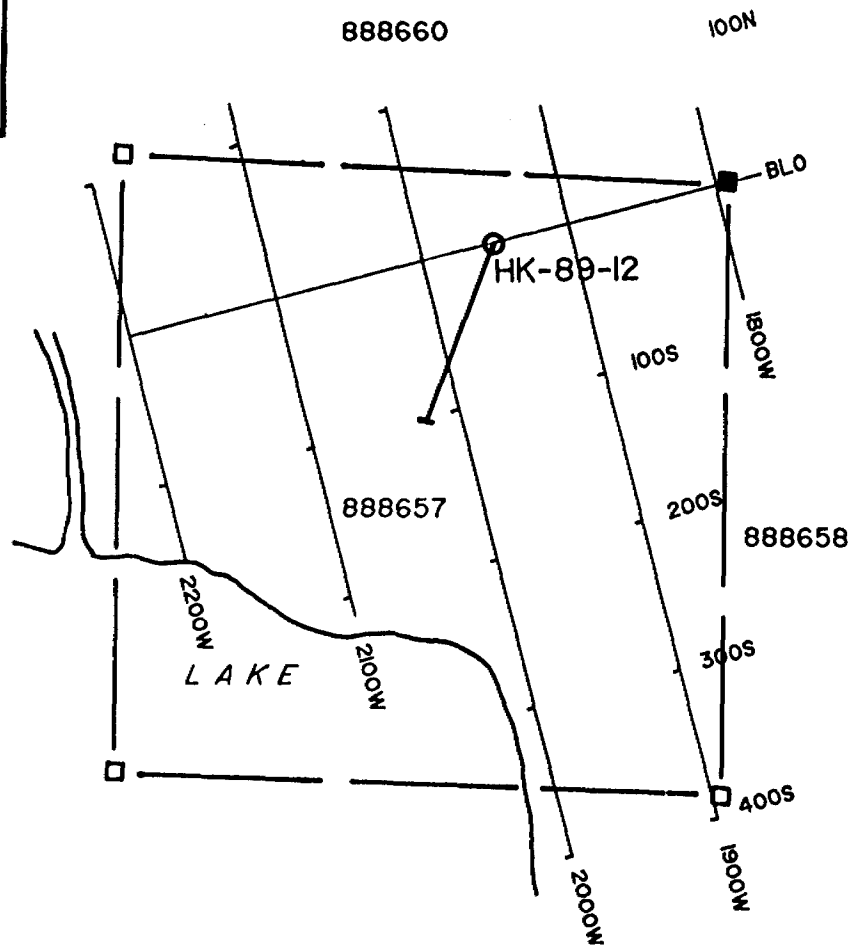
PROJECT: <u>Aurlot Exploration</u>	HOLE NUMBER: <u>HK-89-11</u>
AREA: <u>Hawkins Township</u>	LOCATION: <u>L13+50W/3+65N</u>
CLAIM NUMBER: <u>P 888611</u>	AZIMUTH: <u>200°</u>
CORE SIZE: <u>BQ</u>	DIP: <u>-45°S</u>
DRILLED BY: <u>Alexandre Drilling Inc.</u>	DATES: <u>Sept. 22-23</u>
LOGGED BY: <u>H. Lahti</u>	CASING: <u>7.3M</u>
CORE STORED AT: <u>Oba</u>	LENGTH: <u>102.4M</u>
OBJECTIVE: <u>Test IP, VLF, MAG & Geochem</u> <u>Anomalies</u>	DIP TESTS: <u>0M=45°, 32M=49°, 63M=41°, 102M=36°</u>

DIAMOND DRILL HOLE LOG

METERAGE		ROCK TYPE AND DESCRIPTION	Core Angle to Axis	% Sulphides	SAMPLE			ANALYTICAL RESULT						
From	To				Number	From	To	Length (m)	Au ppb	As ppm	Pb ppm	Zn ppm	Cu ppm	Ag ppm
86.0	90.2	MAFIC TUFF & FLOW												
		-areas with alteration, brown biotite												
		-porphyry dyke, highly sheared, altered, some silica - quartz carbonate stringers												
90.2	93.0	MAFIC FLOW												
		-fine grained grey-green, few quartz carbonate stringers												
93.0	94.5	MAFIC TUFF		1-2%py	15053	93.6	94.3	0.7	21		2	162	680	0.2
		-altered, brown biotite 1% sulphides												
94.5	102.4	MAFIC FLOW												
		-fine grained, parts porphyritic, dark grey green, minor quartz-carbonate stringers - locally brown biotite alteration												
		END OF HOLE												

Howard Latta

ONTARIO GEOLOGICAL SURVEY
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DURHAM GEOLOGICAL SERVICES INC.		
For: AURLOT EXPLORATION LTD.		
Title:		
HK-89-12		
Date: SEPT 89	Drawn: C.G.	Scale: 1:5000
NTS: 42C,42F	Approved	Fig:

Durham Geological Services Inc.
P.O. Box 1330
Timmins, Ontario
P4N 7J8

DIAMOND DRILL HOLE LOG

PROJECT: Aurlot Exploration

AREA: Hawkins Township

CLAIM NUMBER: P 888657

CORE SIZE: BQ

DRILLED BY: Alexandre Drilling Inc.

LOGGED BY: H. Lahti

CORE STORED AT: Oba

OBJECTIVE: Test IP & VLF conductors

HOLE NUMBER: HK-89-12

LOCATION: L19+50W/0+00 BL

AZIMUTH: 200°

DIP: -45° S

DATES: Sept. 25- Sept. 26

CASING: 12.2 m

LENGTH: 154m

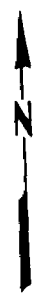
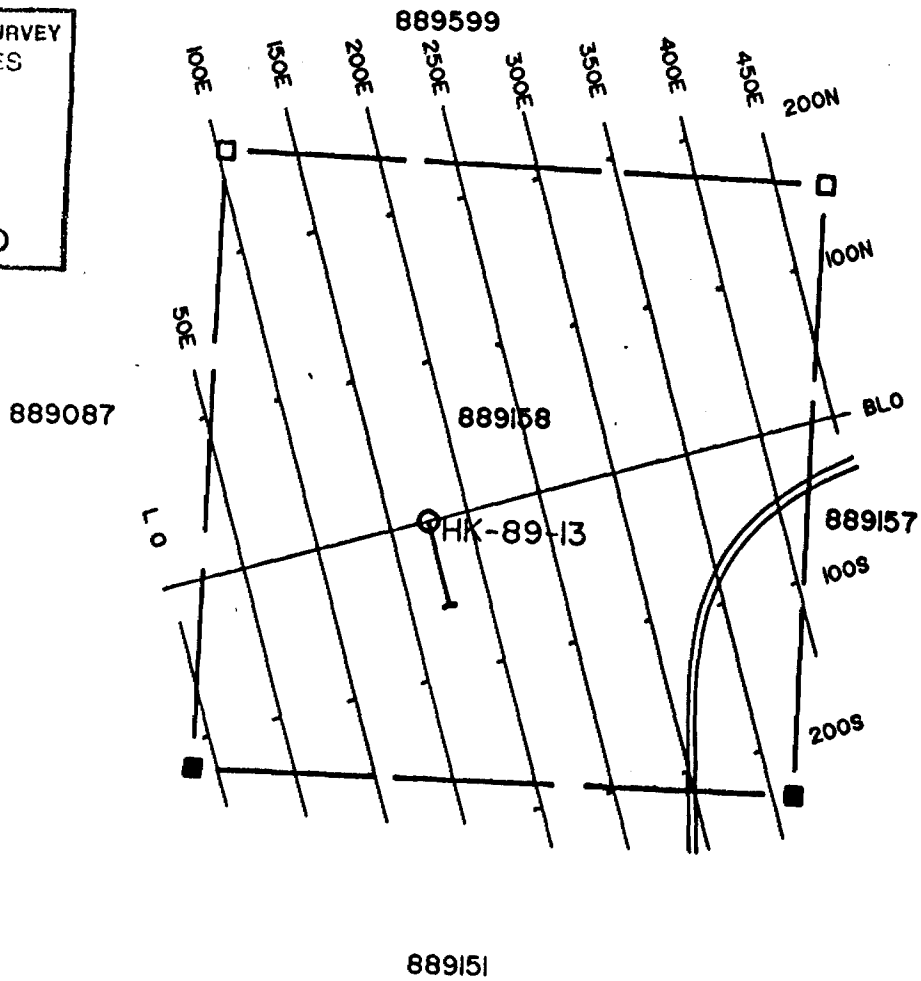
DIP TESTS: 0M=45°, 32M=40°, 63M=40°, 93M=37°
124M=36°, 154M=30°

DIAMOND DRILL HOLE LOG

METERAGE		ROCK TYPE AND DESCRIPTION	Core Angle to Axis	% Sulphides	SAMPLE			ANALYTICAL RESULT					
From	To				Number	From	To	Length (m)	Au ppb	As ppm	Pb ppm	Zn ppm	Cu ppm
145.7	151.8	MAFIC FLOW											
		-sheared alteration, some brown biotite, 70°											
		-quartz-carbonate stringers											
151.8	152.8	FAULT ZONE											
		-(mafic flow) shallow angle 15° to											
		core axis to sub-parallel filled with											
		quartz-carbonate and fragments of mafic											
		volcanic											
152.8	154.3	MAFIC FLOW											
		-fine grained, some alteration,											
		quartz carbonate, trace pyrite on											
		shallow planes											
		END OF HOLE											

Thomson

ONTARIO GEOLOGICAL SURVEY
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DURHAM GEOLOGICAL SERVICES INC.		
For: AURLOT EXPLORATION LTD.		
Title: HK-89-13		
Date: SEPT 89	Drawn: C.O.	Scale: 1:5000
NTS: 42C,42F	Approved:	Fig.:

Durham Geological Services Inc.
P.O. Box 1330
Timmins, Ontario
P4N 7J8

DIAMOND DRILL HOLE LOG

PROJECT: Aurlot Exploration

HOLE NUMBER: HK-89-13

AREA: Hawkins Township

LOCATION: L 1+75E/0+00 BL

CLAIM NUMBER: P 889158

AZIMUTH: 165°

CORE SIZE: BQ

DIP: -45° S

DRILLED BY: Alexandre Drilling Inc.

DATES: Sept. 27th

LOGGED BY: H. Lahti

CASING: 6m

CORE STORED AT: Oba

LENGTH: 78.0m

OBJECTIVE: Test IP Anomaly, Extensions of
Main Zone

DIP TESTS: 0M= 45°, 32M=43° 63M=37°

DURHAM
GEOLOGICAL
SERVICES INC.

DIAMOND DRILL HOLE LOG

METERAGE		ROCK TYPE AND DESCRIPTION	Core Angle to Axis	% Sulphides	SAMPLE				ANALYTICAL RESULT					
From	To				Number	From	To	Length (m)	Au ppb	As ppm	Pb ppm	Zn ppm	Cu ppm	Ag ppm
71.9	73.8	MAFIC FLOW												
		-fine grained, epidotization												
		-some pyrite, moderately hornblende												
73.8	75	FRACTURE-SHEAR ZONE												
		-core broken in mafic flow as above,												
		-numerous quartz epidote veinlets												
		-some hematite staining												
75	78	MAFIC FLOW												
		-fine grained, much less quartz-epidote												
		-fewer fractures												
		END OF HOLE												
		Virtually 100% core recovery												

Howard Lath

DOCUMENT No.
W9005-002



900
AK

Mining Act Report of Work

Name and Address of Recorded Holder GOLDFIELDS CANADIAN MINING LTD. C/O AURLOT EXPLORATION 1404-141 ADELAIDE W. TORONTO, ONTARIO M5H 3M7	Prospector's Licence No. T-1195
	Telephone No. 416-366-2098

Summary of Distribution of Credits and Work Performance

Mining Division SAULT STE MARIE	Mining Claim			Mining Claim			Mining Claim		
	Prefix	Number	Work Days Cr.	Prefix	Number	Work Days Cr.	Prefix	Number	Work Days Cr.
Township or Area HAWKINS (Wawa)									
Total Assessment Credits Claimed 0									
Type of Work Performed (Check one only)									
<input type="checkbox"/> Manual Work									
<input type="checkbox"/> Shaft Sinking Drifting or other Lateral Work									
<input type="checkbox"/> Mechanical equipment									
<input type="checkbox"/> Power Stripping other than Manual (maximum credit allowed - 100 days per claim)									
<input checked="" type="checkbox"/> Diamond or other Core drilling									
<input type="checkbox"/> Core Specimens									

Dates when work was performed From: SEPT 9 To: SEPT 27/89	Total No. of Days Performed 3077	Total No. of Days Claimed 0	Total No. of Days to be Claimed at a Future Date 3077
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All the work was performed on Mining Claim(s): Indicate no. of days performed on each claim. * (See note No. 1 on reverse side)				Mining Claim	No. of Days	Mining Claim	No. of Days	Mining Claim	No. of Days	Mining Claim	No. of Days
						P 915300	356	P 860507	862	P 888658	337
Mining Claim	No. of Days	Mining Claim	No. of Days	Mining Claim	No. of Days	Mining Claim	No. of Days	Mining Claim	No. of Days	Mining Claim	No. of Days
P888610	169	P888611	592	P888657	505	P889158	256				

Required information eg. type of equipment, Names, Addresses, etc. (See Table on reverse side)
If space below is insufficient, attach schedules with required information and location sketches

DRILLING COMPANY	DRILL HOLE	FOOTAGE	
FORAGE ALEXANDRE INC. VAL D'OR, QUEBEC	HK-89-6	506'	
	HK-89-7	356'	
	HK-89-8	356'	
	HK-89-9	506'	
	HK-89-10	256'	
	HK-89-11	336'	
	HK-89-12	505'	
	HK-89-13	256'	
	TOTAL = 3077'		FOOTAGE

ONTARIO GEOLOGICAL SURVEY
ASSESSMENT FILES OFFICE
JAN 19 1990
RECEIVED

RECORDED
NOV 20 1990
Receipt No. _____

Certification of Beneficial Interest * (See Note No. 2 on reverse side)

I hereby certify that, at the time the work was performed, the claims covered in this report of work were recorded in the current recorded holder's name or held under a beneficial interest by the current recorded holder.	Date Nov 13 / 89	Recorded Holder or Agent (Signature) Randy Mass
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Certification Verifying Report of Work

I hereby certify that I have a personal and intimate knowledge of the facts set forth in the Report of Work annexed hereto, having performed the work or witnessed same during and/or after its completion and the annexed report is true.

Name and Address of Person Certifying RANDY MASS C/O DURHAM GEOLOGICAL BOX 1330 TIMMINS, ONT. P4N 7J8	Telephone No. 268-6644	Date Nov 13 / 89	Certified By (Signature) Randy Mass
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For Office Use Only

Work Assignments	Received Stamp SAULT STE MARIE MINING DIV RECEIVED NOV 20 1989 A.M. 7 8 9 10 11 12 1 2 3 4 5 6 P.M.
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G-5316

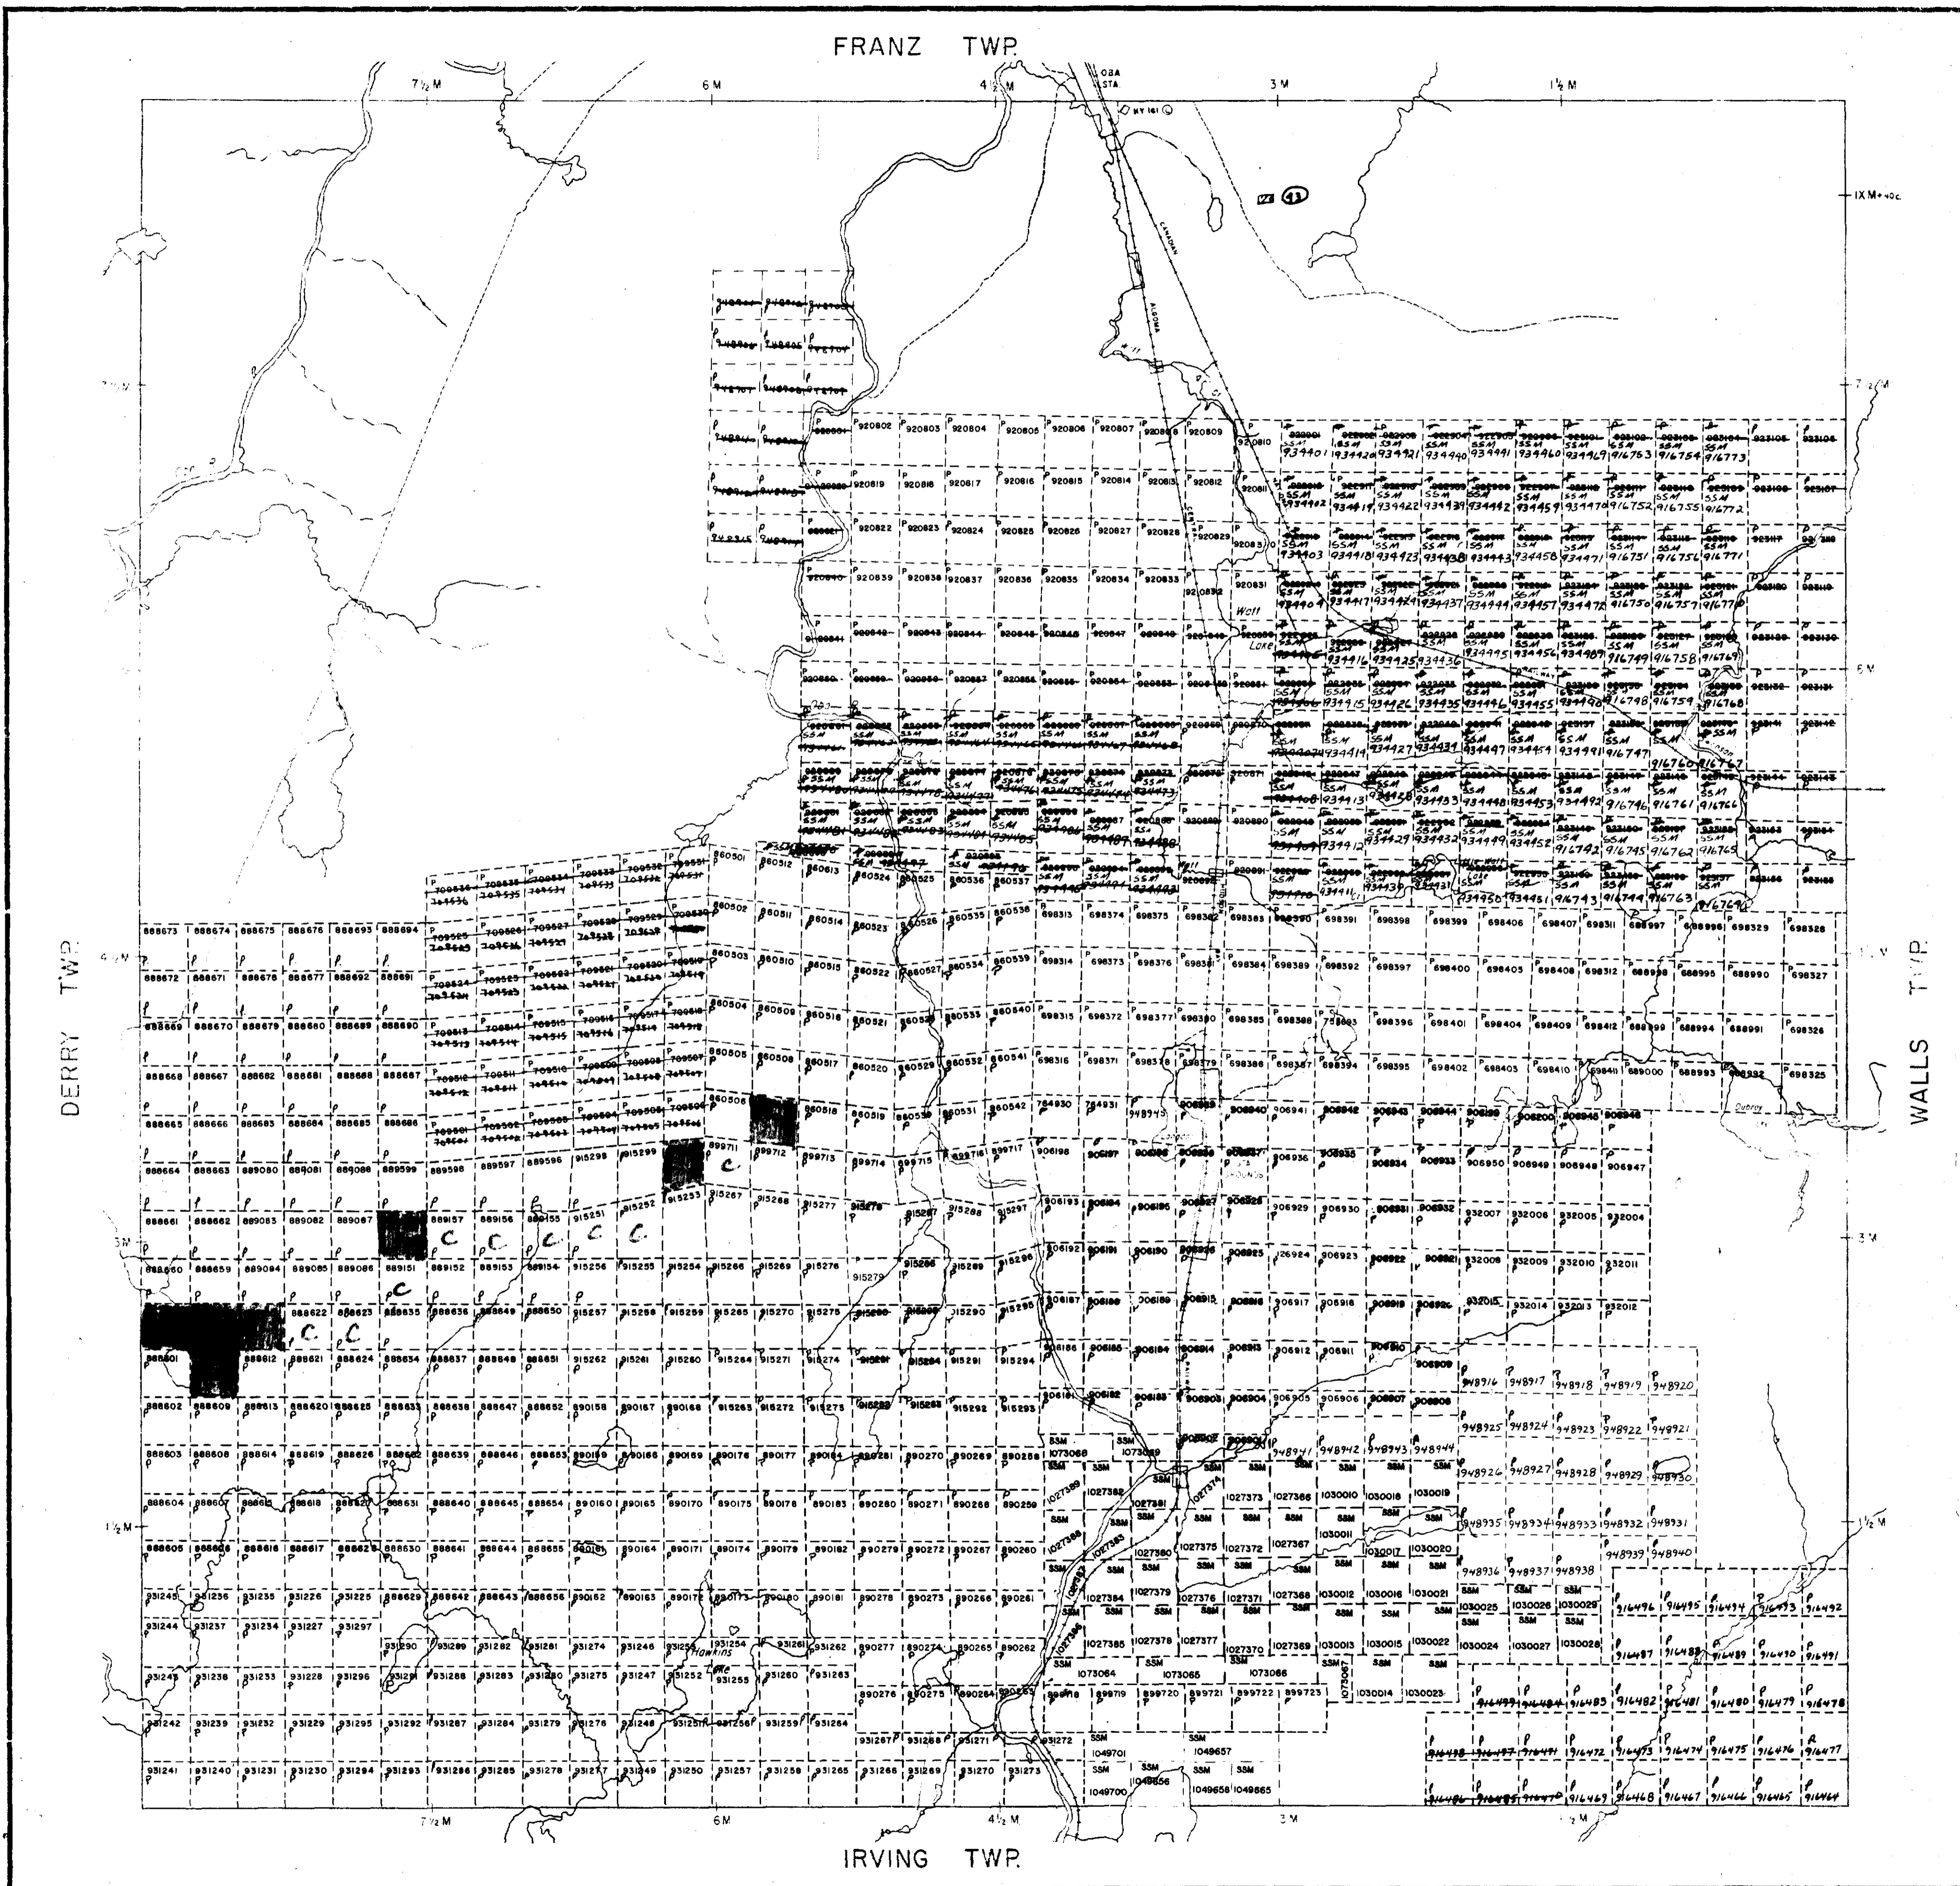
HAWKINS TWP

5316

G-5316

PWT 211KWAH

G-5316



REFERENCES

AREAS WITHDRAWN FROM DISPOSITION

M.R.O. - MINING RIGHTS ONLY
 S.R.Q. - SURFACE RIGHTS ONLY
 M + S. - MINING AND SURFACE RIGHTS

Description	Order No.	Date	Disposition	File
41		4/10/73		69585

Proposed Forestry Work in Township 1988/89 Work schedule available for viewing upon request.

LEGEND

- HIGHWAY AND ROUTE No.
- OTHER ROADS
- TRAILS
- SURVEYED LINES - TOWNSHIPS, BASE LINES, ETC.
- LOTS, MINING CLAIMS, PARCELS, ETC.
- UNSURVEYED LINES
- LOT LINES
- PARCEL BOUNDARY
- MINING CLAIMS ETC.
- RAILWAY AND HIGHWAY
- UTILITY LINES
- NON PERENNIAL STREAM
- FLOODING OR FLOODING RIGHTS
- SUBDIVISION OR COMPOSITE PLAN
- RESERVATIONS
- ORIGINAL SHORELINE
- MARSH OR MUSKEG
- MINES
- TRAVERSE MONUMENT

DISPOSITION OF CROWN LANDS

TYPE OF DOCUMENT	SYMBOL
PATENT SURFACE & MINING RIGHTS	●
SURFACE RIGHTS ONLY	○
MINING RIGHTS ONLY	○
LEASE SURFACE & MINING RIGHTS	○
SURFACE RIGHTS ONLY	○
MINING RIGHTS ONLY	○
LICENSE OF OCCUPATION	○
DEVELOPMENT COUNCIL	○
DEVELOPMENT	○
CARTELS	○
SAND & GRAVEL	○

NOTE: MINING RIGHTS IN PARCELS 1913 VESTED IN FEDERAL PATENTS BY THE MINING ACT, R.S.O. 1960, CHAP. 380, S. 42 SUBJECT TO LANDS ACT, R.S.O. 1960, CHAP. 380, S. 42 SUBJECT TO

SCALE: 1 INCH = 40 CHAINS

FEET: 0 1000 2000 4000 6000 8000
 METERS: 0 300 600 1200 2400

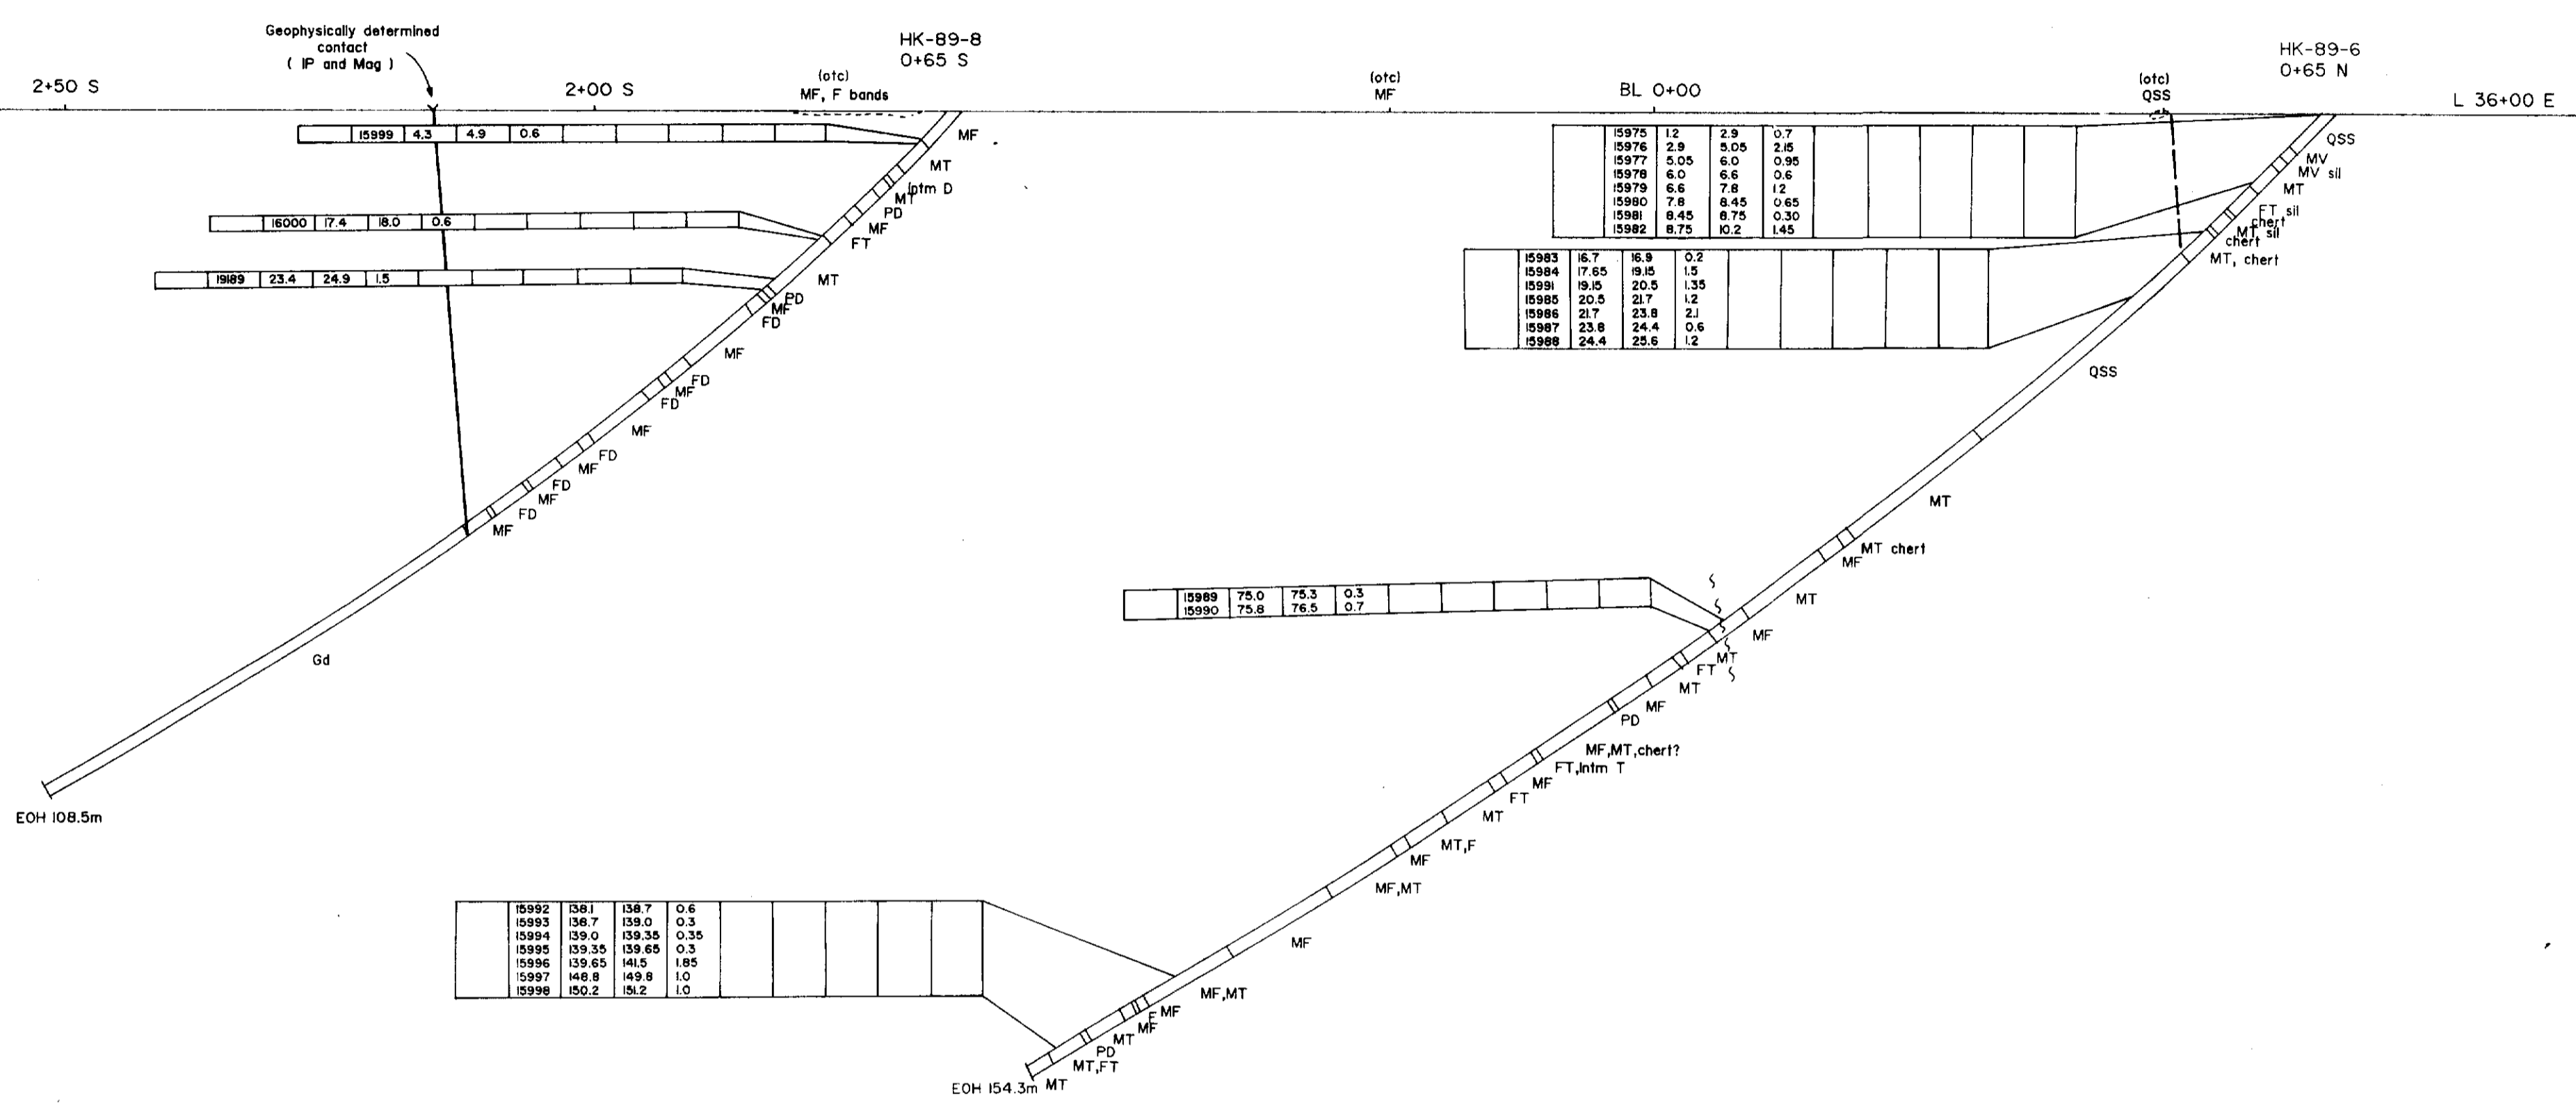
TOWNSHIP

HAWKINS

M.N.R. ADMINISTRATIVE DISTRICT
 HEARST
 MINING DIVISION
SAULT STE. MARIE
 LAND TITLES / REGISTRY DIVISION
ALGOMA

Ministry of Natural Resources
 Land Management Branch
 Ontario

Date: MARCH 3, 1985
 Checked by: LP
G-2316



15999	4.3	4.9	0.6						
16000	17.4	18.0	0.6						
1989	23.4	24.9	1.5						

15975	12	2.9	0.7						
15976	2.9	3.05	2.5						
15977	5.05	6.0	0.95						
15978	6.0	6.6	0.6						
15979	6.6	7.8	1.2						
15980	7.8	8.45	0.65						
15981	8.45	8.75	0.30						
15982	8.75	10.2	1.45						

15989	75.0	75.3	0.3						
15990	75.8	76.5	0.7						

15992	138.1	138.7	0.6						
15993	138.7	139.0	0.3						
15994	139.0	139.35	0.35						
15995	139.35	139.65	0.3						
15996	139.65	141.5	1.85						
15997	146.8	149.8	1.0						
15998	150.2	151.2	1.0						

VOLCANIC ROCKS		MINERALS	
MV	Mafic Volcanic	qu	quartz vein
MT	Mafic Tuff	ep	epidote
MF	Mafic Flow	st	staurolite
Fa	Felsic	gph	garnet
FT	Felsic Tuff	omph	omphacite
ch	Chert	bn	biotite
QSS	Quartz Sericite Schist	g	garnet
V	Volcanic	ch	chlorite
T	Tuff	car	carsonite
int V	Intermediate Volcanic	mus	muscovite
		tepa	tephroite
		py	pyrite
		pr	pyrrhotite
		coy	chalcocite
		sp	sphalerite
		mag	magnetite
		gal	galena
		hem	hematite
		peg	perthite
		phog	phosphite
		br	breccia

INTRUSIVE ROCKS		SEDIMENTARY ROCKS	
gr	granite	MS	metasandstone
Dd	Diorite	MPS	meta-siltstone
FP	Felsic Porphyry	db	dark chert
PD	Porphyry Dyke	gph	garnetiferous schist
D	Dyke	mag	magnetite
Gd	Gneiss	S	Schist
int D	Intermediate Dyke	F	Formation
		P	pelitic
		sed	sediments

ALTERATION		DESCRIPTIONS	
alt	alteration	fr	fault breccia
ss	silicification	str	stratified
sp	sericitization	tr	truncated
ter	terrestrialization	sd	sanding
Amph	amphibolitization	lg	coarse grained
		mg	medium grained
		lf	fine grained
		m	massive
		dev	deformed
		dis	dissimulated
		hd	hard
		st	streaked
		hom	homotaxial
		inv	inverted
		f	flow
		pl	planned
		ren	renowned

OMP 89-10
Hawkins Twp DDR #24

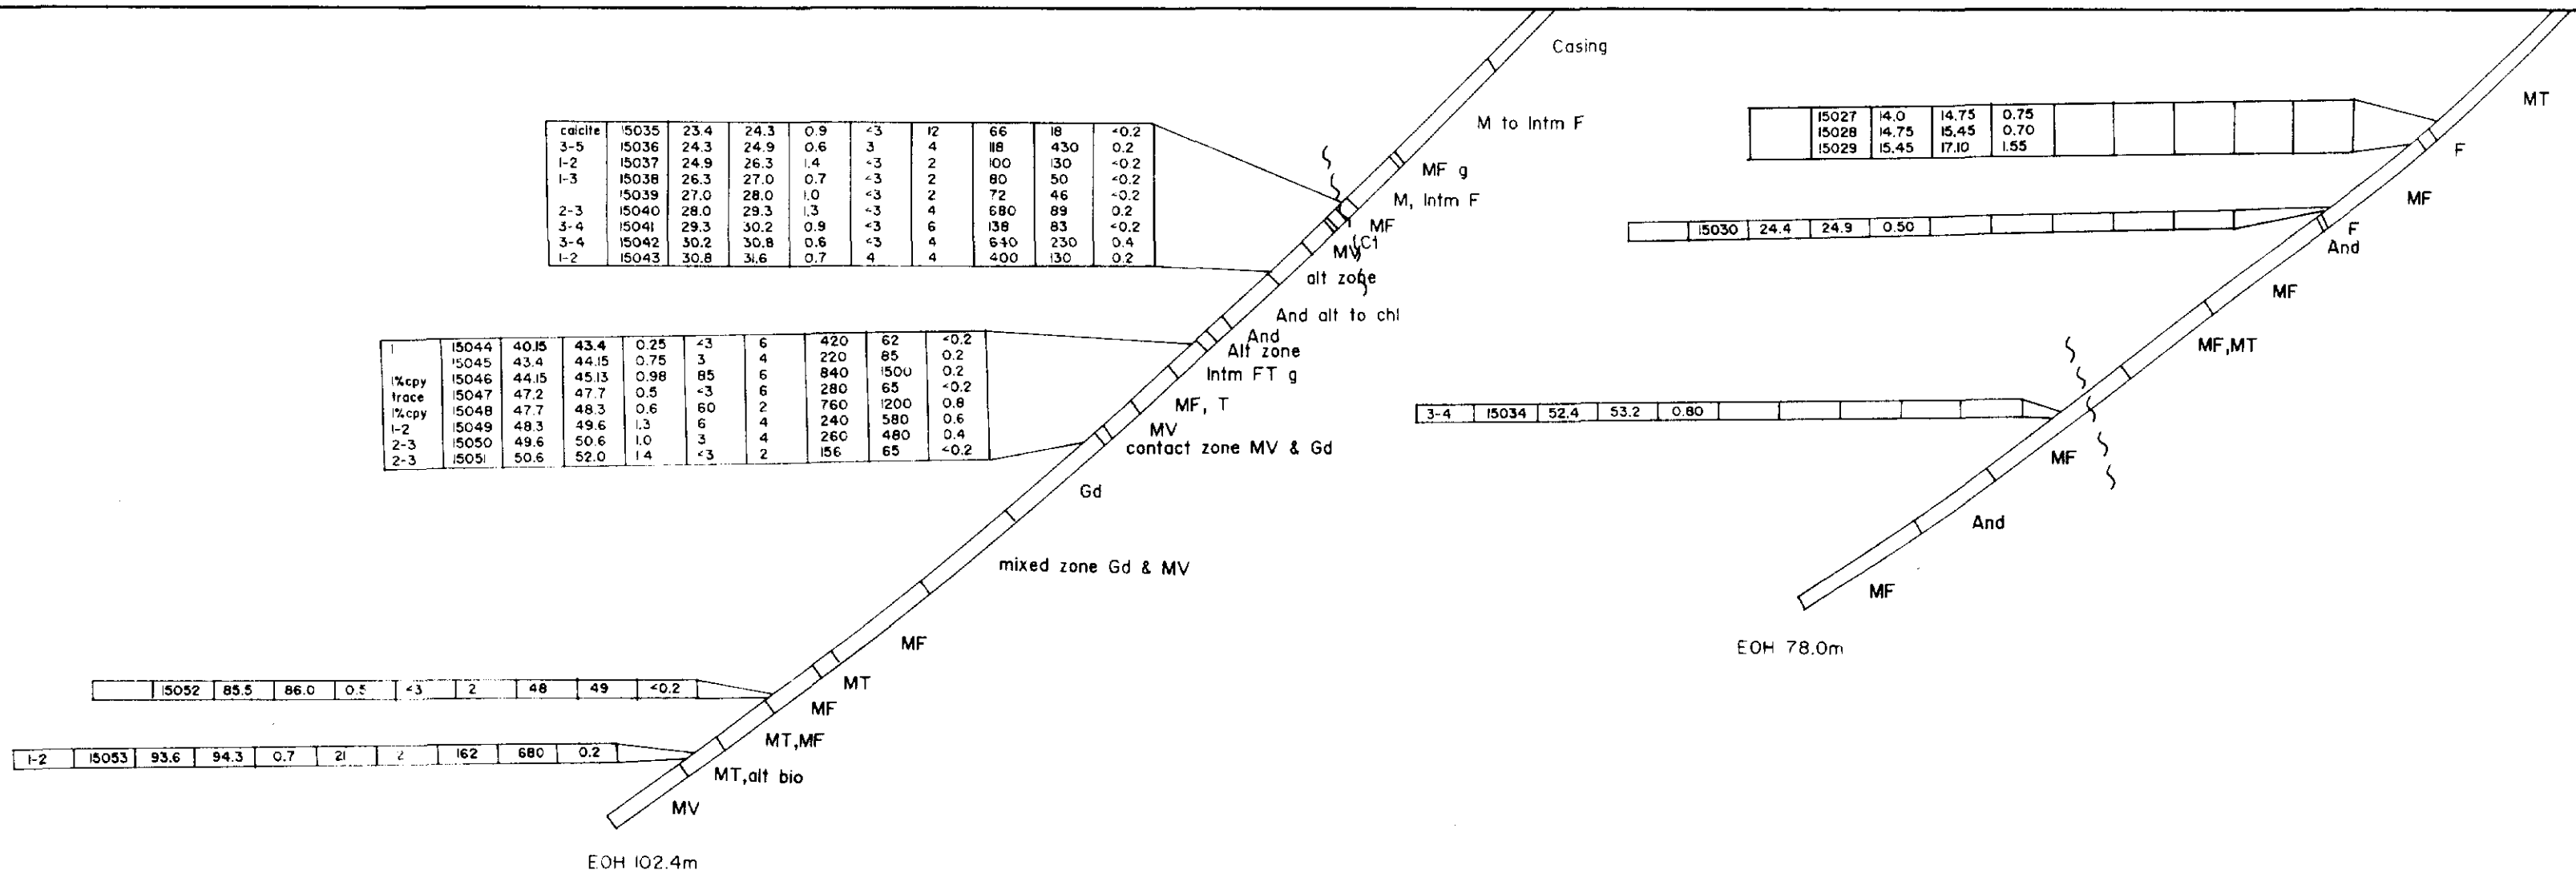
REVISED	DURHAM GEOLOGICAL SERVICES INC.
For	AURLOT EXPLORATIONS LTD.
Title	HAWKINS TOWNSHIP L 36+00 E
	Diamond Drill Hole Section
	HK-89-6 and HK-89-8

%S	Sample No.	From	To	Length	Au	Pb	Zn	Cu	Ag



HK-89-11
L 13+50 W
3+65 S

HK-89-10
L 13+00 W
3+00 S



core	5035	23.4	24.3	0.9	+3	12	66	18	+0.2
1-2	5036	24.3	24.9	0.6	3	4	88	430	0.2
1-3	5037	24.9	26.3	1.4	+3	2	100	130	-0.2
2-3	5038	26.3	27.0	0.7	+3	2	80	50	-0.2
3-4	5039	27.0	28.0	1.0	+3	2	72	46	-0.2
1-2	5040	28.0	29.3	1.3	+3	4	680	89	0.2
3-4	5041	29.3	30.2	0.9	+3	6	138	83	+0.2
3-4	5042	30.2	30.8	0.6	+3	4	610	230	0.4
1-2	5043	30.8	31.6	0.7	4	4	400	130	0.2

1	5044	40.8	43.4	0.25	+3	6	420	62	+0.2
1	5045	43.4	44.15	0.75	3	4	220	85	0.2
1	5046	44.15	45.13	0.98	85	6	840	150	0.2
1	5047	47.2	47.7	0.5	+3	6	280	55	-0.2
1-2	5048	47.7	48.3	0.6	60	2	760	1200	0.8
1-2	5049	48.3	49.6	1.3	6	4	240	580	0.6
2-3	5050	49.6	50.6	1.0	3	4	260	480	0.4
2-3	5051	50.6	52.0	1.4	+3	2	156	65	-0.2

15027	14.0	14.75	0.75						
15028	14.75	15.45	0.70						
15029	15.45	17.10	1.65						

15030	24.4	24.9	0.50						
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15034	52.4	53.2	0.80						
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15032	85.5	86.0	0.5	+3	2	48	49	<0.2
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15053	93.6	94.3	0.7	2	2	162	680	0.2
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VOLCANIC ROCKS		METALS	
MV	Mafic volcanic	OV	ovartz vein
MT	Mafic Tuff	ES	esphale
MF	Mafic Flow	SI	silica
F	Felsic	SP	spangite
FT	Felsic Tuff	OP	ophite
QSS	Quartzitic Sandstone	OH	ohioite
V	volcanic	BO	boelite
T	Tuff	C	corundum
IA	intermediate volcanic	CH	chlorite
ROB	robertsonite	REB	reberite
MUS	muscovite	MUS	muscovite
ASBP	actinolite	ASBP	actinolite
TR	trichite	TR	trichite
GR	garnet	GR	garnet
DI	diopside	DI	diopside
EP	epidote	EP	epidote
SG	serpentine	SG	serpentine
MG	magnetite	MG	magnetite
IL	ilmenite	IL	ilmenite
GR	garnet	GR	garnet
HA	hematite	HA	hematite
HE	hercynite	HE	hercynite
PI	pyroxene	PI	pyroxene
CR	corundum	CR	corundum
BR	breccia	BR	breccia
SEDIMENTARY ROCKS		TEXTURES	
MS	metasandstone	MS	metasandstone
MPS	metapelite	MPS	metapelite
BS	basalt	BS	basalt
BE	basaltic andesite	BE	basaltic andesite
SP	serpentine	SP	serpentine
MP	magnetite	MP	magnetite
S	silica	S	silica
P	pyroxene	P	pyroxene
PL	plagioclase	PL	plagioclase
TR	trichite	TR	trichite
GR	garnet	GR	garnet
HA	hematite	HA	hematite
HE	hercynite	HE	hercynite
PI	pyroxene	PI	pyroxene
CR	corundum	CR	corundum
BR	breccia	BR	breccia
ALTERATION		ALTERATION	
OP	oxidation	OP	oxidation
SI	silicification	SI	silicification
EP	epithermal	EP	epithermal
AS	arsenization	AS	arsenization
AM	amphibolization	AM	amphibolization

OMIP 89-10
Hawkins Twp DD.R.#24

REVISIONS	DURHAM GEOLOGICAL SERVICES INC.		
For:	AURLOT EXPLORATIONS LTD.		
Title:	HAWKINS TOWNSHIP Diamond Drill Hole Section HK-89-10 and HK-89-11		
Date:	Oct. 1989	Drawn:	C.G.
NTS:	42C/42F	Approved:	Fig.

%S	Sample No.	From	To	Length	Au	Pb	Zn	Cu	Ag
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