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PROGRESS REPORT
ON A
SURFACE DIAMOND DRILL EXPLORATION PROGRAM
ON
WINDFALL OILS & MINES LIMITED PROPERTY
ECHO & McAREE TOWNSHIPS
NORTHWESTERN ONTARIO

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General Geology

The rocks of the Windfall Oils and Mines area consist of a series of Precambrian volcanic rocks in a formation about 2 miles wide in plan. The volcanic rocks are composed of massive pillowed amygdaloidal lava flows interlayered with andesitic tuffs, lapilli tuffs and agglomerate. On the Goldlund property, these trend about North 60° E and dip 75° to 80° southwards. The faulted and folded formations trend N-80°-E across the Windfall ground and then curve southwesterly at the West boundary of Windfall. A multiple sill intrusion of grey granodiorite, 100' to 300' thick follows the contact of andesitic tuff and andesitic pillow lavas at the Goldlund and Windfall shafts. The granodiorite extends over at least 10 miles of strike length. The granodiorite forms a competent rock in the andesitic tuff environment and it was fractured and silicified, varying amounts of carbonization and pyritization occurred at different periods.

At Goldlund, the main granodiorite is composed of a multiple of sill intrusions each with chilled contacts. Progression along the granodiorite westward onto the Windfall ground has its component sills separated by ever widening intersill layers of tuffs and andesitic pillow lava formed by the slightly diverging trends of the individual granodiorite sill intrusions.

Faulting

Widely spaced, strong faults cross the main trend of the granodiorite. These faults are commonly marked by the intrusions of waxy, sericitic, quartz-porphry. The picture of the

faulting pattern is still in the process of discovery and evolution at Windfall. Major faults divide up the granodiorite trend from the east as follows;

- The Goldlund Far East Block
- The Goldlund 1-27 East Block
- The Goldlund East Block
- The Goldlund West Block
- The Windfall Subsurface West Block Extention
- The Windfall East Block
- The Windfall Shaft Block

There is a remarkable consistency in the attitude of the gold bearing tension fractures in the granodiorite on all the Goldlund and Windfall blocks. These all trend N to N-15°-E and dip 45 - 55 degrees westwards.

The gold bearing structures - Windfall

Gold bearing quartz veins at Windfall occur as quartz filled fractures contained between the walls of the N-80°-E trend of the granodiorites in Area 2. Three parallel granodiorite dykes that dip 85 - 87 degrees southwards and are 30' to 50' thick, are each fractured, silicified and mineralized with gold. The Area 2 (Windfall Shaft Block) is limited by a waxy quartz-porphyry dyke intruded along the fault which trends northerly and dips about 45 degrees westwards. The fault projects to surface about 250' east of the Windfall shaft.

The tension fractures in the granodiorite are commonly filled with quartz to form a veinlet from a fraction of an inch up to a foot wide. Visible gold is commonly associated with later grey or white quartz introduced into the refractured veins

and adjacent wallrock. The concentration of visible gold occurs along the vein wallrock contact. The total amount of visible gold does not differ recognizably with the thickness of the veinlet, since it is the contacts that contain the visible gold concentrations.

Minerals associated with gold enrichment are most commonly altaite (a lead telluride) and occasionally sphalerite. Pyrite is ubiquitous to all periods of mineralization. One type of pyrite mineralization that occurs as massive veinlets 1" to 4" thick invariably has visible gold mineralization.

The drilling to date in Area 2 shows a remarkable continuity and consistency in the order of magnitude of gold content and continuity down rake westwards, of fracture veinlets, from drill section to drill section.

Current Program Evaluation

During the winter of 1980, this writer made an evaluation of the Windfall property. All available data from underground sampling, mapping, surface and underground drill holes were compiled on a plan and on a longitudinal section, each at a scale of 1" = 20'.

This writer then applied his concept of the pattern and distribution of gold bearing structures developed at the adjoining Goldlund Mine in 1979. A favourable potential for the discovery of a multiple pattern of gold bearing structures was postulated as being worthy of exploration and required testing by surface diamond drilling. A program of 12,000 feet of such surface diamond drilling in 5 areas was recommended as a first phase, the total estimated cost of that first phase was \$300,000.00. Preparations on road improvements and camp construction was started in May, 1980.

The preliminary evaluation of the Windfall property indicated that an area of granodiorite near the Windfall shaft was the site of three uncorrelated rich, narrow intersections of visible gold from old surface drill holes. It was planned to test this area within the granodiorite to determine if the postulated pattern of a number of gold bearing structures occurs.

History

During the period 1949 - 1951, exploration work was carried out on the Windfall property. During that period a shaft was sunk to a depth of 200 feet and a 200 foot cross-cut connected the shaft to the 200 ft. level from the Newlund shaft (now the Goldlund Mine). This 200 ft. level was extended as an exploratory drift that followed along the northern or footwall side of the granodiorite, at a distance of $\frac{1}{2}$ mile across the Windfall property then continued across its western boundary into the Conecho claim (now Riocanex Ltd.). Much of the 7 ft. X $7\frac{1}{2}$ ft. drift lies 120 ft. to 160 ft. below surface with 100 to 130 feet of rock to ledge.

Underground drilling consisted of 16 flat holes drilled from the E-W trending drift for a total footage of 2,850 feet.

Surface diamond drilling consisted of 17 inclined holes that crossed the trend of the granodiorite at 200 to 300 ft. intervals. Surface drilling totaled about 7,755 feet.

The general results of the past work must have proved disappointing at that time due to the scarcity of good drill hole intersections or underground sampling results. The few widely spaced values could not be correlated.

Preparations

During May and June of 1980, under the supervision of Adrian J. Kuryliw, the Goldlund-Windfall road was extended across the Windfall property to Crossecho lake. The single lane gravel road provides easy access to the camp and drill sites. The initial cost of the road was returned in good measure by a lower drilling contract rate. Tent camps were erected near Crossecho lake. A 16 by 24 ft. office-core shack was erected using wood frame construction and plywood sheeting.

Surveyors were contracted to carry a survey across the property to Areas 1, 2, 3, 4 using the old Windfall Mine coordinates. This work was completed and the survey points are now being used to spot and survey drill holes.

A 50 foot pole tower was erected for a radio phone.

RESULTS TO DATE

The structural picture is being developed and is still in a state of discovery and evolution. A complete pre-feasibility report on Windfall has been started and it is expected to be completed in March 1981. That report will incorporate the Geologic report with ore reserve calculations, Mine exploration and development planning, planned approaches to mining, metallurgical tests, and mill design for Windfall. Studies will also be made on incorporating a parallel custom milling operation in the milling plant. The draughting of mine plans and sections has been started to form the base maps for the complete pre-feasibility report.

AREA 1

Two holes were drilled to cross the westward extension of the Goldlund West Zone granodiorite ore structures down its rake below a fault that limited its crest which rakes at 20° to 25° degrees westwards.

Two holes were drilled 80-1 and 80-2. Hole 80-1 was successful in intersecting the projected extension of the Goldlund 103 - 104 West Zone structures as postulated by this writer, the mineralization, fracturing and quartz were typical of that structure. The section also carried significant continuous gold values from 1135.3 - 1156.4.

| | | | |
|-----------------|-----|-----|-----|
| 1135.3 - 1137.0 | .02 | oz. | Au. |
| 1137.0 - 1139.0 | .01 | " | " |
| 1139.0 - 1140.6 | .04 | " | " |
| 1140.6 - 1142.3 | .03 | " | " |
| 1142.3 - 1143.0 | .07 | " | " |
| 1143.0 - 1144.2 | .02 | " | " |
| 1144.2 - 1145.5 | .11 | " | " |
| 1145.5 - 1147.0 | .02 | " | " |
| 1147.0 - 1148.6 | .03 | " | " |
| 1148.6 - 1150.1 | .10 | " | " |
| 1150.1 - 1152.0 | .02 | " | " |
| 1152.0 - 1153.7 | Tr | " | " |
| 1153.7 - 1154.7 | .05 | " | " |
| 1154.7 - 1156.4 | .04 | " | " |

Hole 80-2 was drilled in an attempt to cross the projected extensions of the 1-09 to 1-11 structures of the Goldlund West Zone structures, but this long hole flattened too much and overshot the target.

A total of 2,448 feet were drilled in Area 1.

AREA 2

A pattern of gold bearing quartz filled fractures that strike north to north 15 degrees east and dips 45 to 55 degrees westwards extend across each of three parallel granodiorite dykes. These three dykes are 35 to 55 feet wide and are separated by 2 to 10 feet of greyish andesitic tuff. The total width of dykes averages about 120 feet. The dykes trend about N-80°- E and dip nearly vertical. A concentration of drill holes in a pattern of drill holes from 11,100 E to 11,700 E along the dykes and across the gold bearing structures indicates that the gold bearing fractures form a mineralized zone across the three dykes that plunges westwards at about 30° - 40°. This zone was tested to a depth of 500 feet but the drill holes tend to bend off their intended direction and wander out of the granodiorite dykes so that depth extensions are difficult to obtain by long drill holes.

A total of 26 drill holes all of AXT core size (except Hole 30 which is BQ core size) were drilled, these holes totalled 10,600.5 feet.

11-10-60
11-10-60

The following diamond drill intersections were obtained in Area 2. Only V.G. intersections or intersections with gold values over 0.20 ounce gold per ton are listed below. More details can be obtained from the drill logs.

| Hole | Footage | oz's Au. Assay | In feet Width |
|---------------|---------------|-------------------|------------------|
| 80- 4 | 184.1 - 184.7 | .48 V.G. | 0.6' |
| | 229.1 - 229.8 | .32 | 0.7' |
| 80- 5 | 143.2 - 143.7 | 1.53 | 0.5' |
| 80- 6 | 90.0 - 91.0 | .063 V.G. | 1.0' |
| | 113.6 - 114.6 | .64 V.G. | 1.0' |
| | 106.0 - 106.8 | .04 V.G. | 0.8' |
| | 134.0 - 135.0 | 2.12 V.G. | 1.0' |
| | 199.0 - 199.8 | .86 | 0.8' |
| | 268.0 - 268.7 | .336 | 0.7' |
| | 294.8 - 295.6 | .73 V.G. | 0.8' |
| | 308.2 - 309.8 | .20 | 1.6' |
| | 343.4 - 344.1 | .597 V.G. | 0.7' |
| | 383.8 - 385.1 | .16 V.G. | 1.3' |
| | 401.4 - 402.8 | .023 V.G. | 1.4' |
| 80- 7 | 107.0 - 108.2 | .36 | 1.2' |
| | 114.6 - 115.2 | .32 | 0.6' |
| | 132.5 - 133.5 | .27 | 1.0' |
| | 206.5 - 207.2 | 1.54 V.G. | 0.7' |
| | 223.0 - 223.9 | .16 | 0.9' |
| | 251.8 - 282.8 | 12.25 V.G. | 1.0' |
| | 290.1 - 290.8 | .20 | 0.7' |
| | 334.2 - 335.5 | .287 V.G. | 1.3' |
| | 335.5 - 336.5 | .319 V.G. | 1.0' |
| | 337.5 - 339.0 | .31 | 1.5' |
| | 385.5 - 386.5 | .026 V.G. | 1.0' |
| | 390.5 - 391.9 | .01 V.G. | 1.4' |
| | 80- 8 | 143.0 - 144.7 | .083 V.G. |
| 165.0 - 165.6 | | 8.123 V.G. | 0.6' |
| 236.0 - 236.6 | | .726 V.G. | 0.6' |
| 250.5 - 251.1 | | .036 V.G. | 0.6' |
| 333.3 - 333.9 | | .82 V.G. | 0.6' |
| 80- 9 | 80.3 - 80.9 | .22 V.G. | 0.6' |
| | 117.0 - 117.6 | .14 V.G. | 0.6' |
| | 119.3 - 120.3 | .04 V.G. | 1.0' |
| | 124.3 - 125.0 | .13 V.G. | 0.7' |
| | 128.0 - 128.5 | .60 V.G. | 0.5' |
| | 175.0 - 175.6 | 1.50 V.G. | 0.6' |
| | 225.6 - 226.2 | .04 V.G. | 0.6' |
| | 302.8 - 303.3 | 1.59 V.G. | 0.5' |
| | 303.9 - 305.6 | .36 | 0.6' |
| | 331.0 - 331.9 | Tr V.G. | 0.9' |
| | 361.2 - 361.8 | .02 V.G. | 0.6' |

| <u>Hole</u> | <u>Footage</u> | <u>oz's Au. Assay</u> | <u>In feet Width</u> |
|---------------|----------------|---------------------------|--------------------------|
| 80-11 | 209.0 - 210.0 | .42 | 1.0' |
| | 249.0 - 250.0 | .20 V.G. | 1.0' |
| 80-12 | 33.0 - 34.0 | .02 V.G. | 1.0' |
| | 47.0 - 47.8 | .45 V.G. | 0.8' |
| | 178.0 - 178.8 | .323 | 0.8' |
| | 212.5 - 213.2 | .26 | 0.7' |
| 80-13 | 172.5 - 173.0 | .81 | 0.5' |
| | 214.3 - 215.0 | .82 V.G. | 0.7' |
| | 265.0 - 265.7 | .40 V.G. | 0.7' |
| | 295.7 - 296.5 | 1.10 | 0.8' |
| | 329.7 - 330.6 | 1.33 V.G. | 0.9' |
| | 348.0 - 349.2 | 5.83 V.G. | 1.2' |
| | 455.0 - 456.0 | 2.16 V.G. | 1.0' |
| 495.0 - 495.9 | 2.45 V.G. | 0.9' | |
| 80-14 | 313.0 - 313.8 | .55 | 0.8' |
| | 337.2 - 337.7 | .85 | 0.5' |
| | 365.7 - 366.7 | .10 V.G. | 1.0' |
| | 340.0 - 340.6 | Tr V.G. | 0.6' |
| | 451.7 - 454.0 | .30 | 2.3' |
| | 619.3 - 620.0 | -.1 | 0.7' |
| 80-15 | 50.0 - 51.0 | .26 | 1.0' |
| | 188.4 - 188.9 | .02 V.G. | 0.5' |
| | 200.5 - 201.0 | .22 | 0.5' |
| | 332.4 - 333.3 | .20 V.G. | 0.9' |
| 80-17 | 87.5 - 88.8 | .02 V.G. | 1.3' |
| 80-18 | 26.0 - 26.7 | 3.25 V.G. | 0.7' |
| | 37.5 - 40.0 | 1.44 | 2.5' |
| 80-19 | 367.0 - 368.0 | .01 V.G. | 1.0' |
| | 380.0 - 381.4 | .25 V.G. | 1.4' |
| | 395.4 - 396.3 | .44 | 0.9' |
| 80-25 | 159.0 - 159.8 | .72 | 0.8' |
| | 191.2 - 192.2 | .69 V.G. | 1.0' |
| | 269.0 - 269.7 | .18 V.G. | 0.7' |
| | 276.3 - 277.3 | .18 | 1.0' |
| | 408.4 - 409.6 | .13 V.G. | 1.2' |
| 80-26 | 73.4 - 74.5 | 1.11 | 1.1' |
| | 79.3 - 80.3 | 1.29 V.G. | 1.0' |
| | 91.4 - 92.7 | .33 V.G. | 1.3' |
| | 100.0 - 101.4 | .25 | 1.4' |
| | 240.0 - 240.8 | 3.17 V.G. | 0.8' |
| | 382.0 - 383.3 | .62 V.G. | 1.3' |
| | 386.6 - 388.6 | 1.23 | 2.0' |
| | 388.6 - 389.7 | .78 | 1.1' |
| | 389.7 - 390.7 | .84 V.G. | 1.0' |
| | 390.7 - 391.8 | .47 V.G. | 1.1' |

| <u>Hole</u> | <u>Footage</u> | <u>oz's Au.</u> <u>Assay</u> | <u>In feet</u> <u>Width</u> |
|-------------|----------------|---------------------------------|--------------------------------|
| 80-27 | 278.1 - 278.7 | .20 V.G. | 0.6' |
| | 321.0 - 321.5 | .63 | 0.5' |
| 80-28 | 26.0 - 26.9 | .21 | 0.9' |
| | 74.0 - 74.7 | .81 | 0.7' |
| | 242.8 - 243.5 | .18 V.G. | 0.7' |
| | 255.0 - 256.4 | .21 | 1.4' |
| | 288.0 - 288.5 | .20 | 0.5' |
| | 312.6 - 314.2 | .24 | 1.6' |
| | 422.0 - 422.6 | 1.16 | 0.6' |
| 80-29 | 339.4 - 340.4 | 3.56 V.G. | 1.0' |
| 80-30 | 128.3 - 129.5 | .03 V.G. | 1.2' |
| | 177.6 - 178.2 | .15 | 0.6' |
| | 193.5 - 194.2 | 6.83 V.G. | 0.7' |
| | 201.0 - 201.6 | 1.57 | 0.6' |
| | 212.0 - 212.5 | .12 | 0.5' |
| | 265.7 - 266.3 | .26 | 0.6' |
| | 443.0 - 444.2 | 3.23 V.G. | 1.2' |

AREA 3

A pattern of gold bearing quartz filled fractures that strike north to N-15° degrees East and dips 45 to 55 degrees westwards, are well developed in the north and central dykes but not in the southernmost of the same three granodiorite dykes that were tested in Area 2. The three dykes change their strike trend from N-80-E in Area 2 south westerly across the RioCanex boundary to the west. The dip of the dykes also flattens to about 60° southwards. The granodiorite dykes in Area 3 also tend to widen westwards, the northerly and central dykes are 40 to 60 feet thick each and are separated by about 10 feet of tuff. In Area 3 the southerly granodiorite dyke is separated from the central dyke by 30 to 40 feet of andesitic pillow lava and it is relatively unfractured and unmineralized, probably due to the fact that it was too thick and competent to be fractured by the stresses prevalent in that Geologic period.

A concentration of drill holes were drilled largely on the northerly dyke from 9850 E to 10500 E and these indicate a concentration of gold bearing fractures that form a zone that plunges southwestwards at about 30 to 50 degrees. This zone was tested to a depth of 400 feet down the plunge of the zone.

A total of 17 drill holes of B-Q core were drilled that totalled 6,472.9 feet.

The following drill hole intersections were obtained in Area 3. Only V.G. intersections or intersections with gold values over 0.20 ounce gold per ton ore listed below. More details can be obtained from the drill logs.

| <u>Hole</u> | <u>Footage</u> | <u>oz's Au.</u> <u>Assay</u> | <u>In feet</u> <u>Width</u> |
|-------------|----------------|---------------------------------|--------------------------------|
| 80-23 | 289.6 - 290.6 | .96 V.G. | 1.0' |
| 80-31 | 70.0 - 71.4 | .23 | 1.4' |
| | 173.3 - 174.1 | .03 V.G. | 0.8' |
| | 228.0 - 228.8 | .29 V.G. | 0.8' |
| | 379.5 - 380.3 | .08 V.G. | 0.8' |
| | 424.0 - 424.6 | .09 V.G. | 0.6' |
| | 446.5 - 447.5 | 1.43 V.G. | 1.0' |
| | 518.2 - 519.4 | .07 V.G. | 1.2' |
| 80-32 | 350.5 - 351.0 | .60 | 0.5' |
| 80-33A | 65.0 - 66.0 | 1.79 | 1.0' |
| | 115.0 - 115.8 | .82 V.G. | 0.8' |
| | 136.0 - 137.2 | 6.25 V.G. | 1.2' |
| | 150.3 - 151.1 | .63 | 0.8' |
| | 163.0 - 163.8 | 12.63 V.G. | 0.8' |
| | 182.0 - 183.0 | 2.24 V.G. | 1.0' |
| | 183.9 - 185.2 | .14 V.G. | 1.3' |
| | 231.8 - 232.7 | .09 V.G. | 0.9' |
| | 245.5 - 247.0 | .41 | 1.5' |
| | 409.2 - 410.2 | .08 V.G. | 1.0' |
| | 415.5 - 416.4 | Tr V.G. | 0.9' |
| | 421.5 - 422.8 | .45 V.G. | 1.3' |
| 80-34 | 54.5 - 56.0 | .23 | 1.5' |
| | 98.9 - 99.8 | .13 V.G. | 0.9' |
| | 174.2 - 174.8 | .31 | 0.6' |
| | 199.0 - 199.8 | 3.43 V.G. | 0.8' |
| | 230.0 - 231.0 | .36 V.G. | 1.0' |
| | 336.2 - 337.2 | .83 V.G. | 1.0' |
| | 421.0 - 442.0 | .40 | 1.0' |
| 80-35 | 31.3 - 31.8 | .70 V.G. | 0.5' |
| | 115.3 - 116.1 | .07 V.G. | 0.8' |
| | 116.8 - 117.6 | .15 V.G. | 0.8' |
| | 135.1 - 135.9 | .18 V.G. | 0.8' |
| | 158.6 - 159.5 | .98 V.G. | 0.9' |
| | 175.6 - 176.8 | .07 V.G. | 1.2' |
| | 222.8 - 224.2 | .05 V.G. | 1.4' |
| | 248.5 - 249.0 | .83 | 0.5' |
| | 250.0 - 250.5 | .77 | 0.5' |
| | 252.4 - 253.3 | .25 | 0.9' |
| | 263.4 - 264.0 | .66 V.G. | 0.6' |
| | 360.0 - 360.5 | .25 | 0.5' |
| | 364.0 - 364.5 | 1.12 | 0.5' |

| <u>Hole</u> | <u>Footage</u> | <u>oz's Au. Assay</u> | <u>In feet Width</u> |
|---------------|----------------|---------------------------|--------------------------|
| 80-36 | 59.6 - 60.3 | 6.30 | 0.7' |
| | 77.4 - 78.4 | 1.89 V.G. | 1.0' |
| | 78.4 - 79.5 | .66 V.G. | 1.1' |
| | 82.0 - 82.9 | .29 | 0.9' |
| | 82.9 - 83.6 | .29 | 0.7' |
| | 89.0 - 90.8 | .19 | 1.8' |
| | 134.5 - 135.3 | .04 V.G. | 0.8' |
| | 155.5 - 156.2 | 1.59 V.G. | 0.7' |
| | 205.8 - 206.5 | .77 | 0.7' |
| | 315.4 - 316.2 | .02 V.G. | 0.8' |
| | 328.2 - 328.9 | .02 V.G. | 0.7' |
| | 372.0 - 372.9 | .15 V.G. | 0.9' |
| | 466.5 - 467.5 | 2.00 V.G. | 1.0' |
| | 470.5 - 471.8 | .27 | 1.3' |
| | 80-37 | 184.0 - 184.7 | 1.59 V.G. |
| 233.0 - 233.7 | | 9.49 | 0.7' |
| 238.7 - 239.3 | | 1.26 | 0.6' |
| 257.1 - 258.0 | | .21 | 0.9' |
| 279.1 - 279.6 | | .20 | 0.5' |
| 285.0 - 285.5 | | .18 | 0.5' |
| 370.0 - 370.8 | | .20 | 0.8' |
| 478.0 - 478.5 | | .38 | 0.5' |
| 80-38 | | 119.9 - 120.8 | .88 |
| | 134.6 - 135.6 | .28 V.G. | 1.0' |
| | 221.0 - 221.6 | 2.12 V.G. | 0.6' |
| | 259.5 - 260.2 | .19 | 0.7' |
| 80-39 | 28.0 - 29.3 | .11 V.G. | 1.3' |
| | 91.3 - 92.7 | .26 V.G. | 1.4' |
| | 94.0 - 95.7 | .18 | 1.7' |
| | 128.0 - 129.2 | .13 V.G. | 1.2' |
| | 137.3 - 138.0 | .54 V.G. | 0.7' |
| | 144.2 - 144.7 | .19 | 0.5' |
| | 149.5 - 150.5 | .17 | 1.0' |
| | 152.1 - 153.1 | .14 V.G. | 1.0' |
| | 236.0 - 237.0 | .07 V.G. | 1.0' |
| | 288.5 - 289.5 | .12 V.G. | 1.0' |
| | 367.5 - 368.0 | .38 | 0.5' |
| | 508.3 - 510.3 | .56 | 2.0' |
| | 80-40 | 54.3 - 54.9 | .77 V.G. |
| 67.2 - 67.9 | | .64 | 0.7' |
| 173.9 - 175.1 | | .09 V.G. | 1.2' |
| 198.9 - 200.0 | | .21 V.G. | 1.1' |
| 202.7 - 204.5 | | .34 V.G. | 1.8' |
| 285.0 - 285.5 | | .37 | 0.5' |
| 288.3 - 289.0 | | .19 | 0.7' |

| <u>Hole</u> | <u>Footage</u> | <u>oz's Au.</u> <u>Assay</u> | <u>In feet</u> <u>Width</u> |
|-------------|----------------|---------------------------------|--------------------------------|
| 80-43 | 214.5 - 215.9 | 5.52 V.G. | 1.4' |
| | 271.7 - 272.5 | .87 | 0.8' |
| | 408.3 - 409.0 | .30 V.G. | 0.7' |
| 80-44 | 33.0 - 34.3 | .17 V.G. | 1.3' |
| | 187.3 - 187.8 | .36 | 0.5' |
| | 206.6 - 207.2 | .33 | 0.6' |
| | 289.8 - 290.4 | 1.65 V.G. | 0.6' |
| | 491.3 - 492.5 | .10 V.G. | 1.2' |

AREA 4


One drill hole No. 80-41 was drilled flatly southwards 882 feet from a point $\frac{1}{2}$ mile north of the Area 2. This cross section hole was drilled to explore for a mineralized extension of the Goldlund No. 2 and No. 3 Zone granodiorites.

The granodiorite was crossed but the intrusion manifested itself as a globular infiltration and impregnation of the epidotized lapilli tuffs. No significant gold mineralization or quartz filled fracturing was located except for a narrow low grade gold intersection in a feldspar porphyry dyke.

AREA 5

This area was not drilled, it covers a claim wedge caught between Riocanex claims about $\frac{1}{4}$ mile southwards of Area 3 and it is an extension of the Area 3 granodiorites. It was not considered the right time to explore that area without some independent or joint activity with Riocanex.

The total diamond drill footage drilled during the 1980 program on Wir fall is 20,353.5 feet.

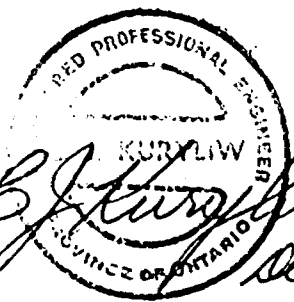 A circular seal for a Professional Engineer in the Province of Ontario. The seal contains the text "PROFESSIONAL ENGINEER" at the top, "KURYLIV" in the center, and "PROVINCE OF ONTARIO" at the bottom. A signature, "B. J. Kuryliw", is written across the seal, and the date "Dec 31/80" is written to the right of the seal.

Dec 31/80

63.3934

OM15 PE12 - C-80

4000 Yonge Street
Apartment 411
Toronto, Ontario
M4N 2N9

August 5th, 1982

Ministry of Natural Resources
Ontario Mineral Exploration Program
Room 4649, Whitney Block
99 Wellesley Street West
TORONTO, Ontario
M7A 1W3

Ministry of Natural Resources
RECEIVED

AUG 05 1982

THE DIRECTOR
MINING TAXATION AND
OMEP OFFICE

Attention Mr. F.W. Pooley


Dear Sir:

RE: TARBUSH LODGE MINING LIMITED

Please find enclosed technical data as requested
for Program OM15-12-C-80:

- 1) Diamond Drilling Logs T-80-1, 2 and 3 inclusive;
- 2) Report on Magnetic Survey by C.J. Kuryliw, P.Eng.;
- 3) Report on Magnetic Survey by Robert L.V. Ekstrom, P.Eng.;
- 4) Plan of Magnetic Survey by C.J. Kuryliw, P.Eng.;
- 5) Plans of Magnetic Survey Sheets 1, 2 and 3W and
1E by R.L.V. Ekstrom, P.Eng.

Yours very truly,

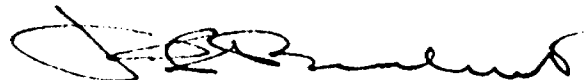

P.S. Broadhurst, P.Eng.

PSB*smh
Enclosures

* AUTO POSITIVES FILED IN TOP DRAWER OF MAP CABINET



Ontario

Ministry of
Natural
Resources

Your file:

Our file:

NOTE : a) TWO (2)

MAGNETOMETER SURVEYS
WERE EXTRACTED FROM THIS
O.M.E.P. SUBMITTAL. THEY (2.3879,
2.3930) WERE PREVIOUSLY FILED
FOR ASSESSMENT CREDIT.

b) THREE (3) DRILL HOLE
LOGS WERE ALSO EXTRACTED, SINCE THEY
HAD BEEN GRANTED CREDITS - SEE D.D.
McAREE 19, REPORT OF WORK 34-81 AND
41-81. (HOLES T-80-1, T-80-2, T-80-3)

The Property

The Windfall Oils and Mines Ltd. property is located in Echo and McAree Twps., in the Sioux Lookout Mining Division of Northwestern Ontario. It consists of a contiguous group of patented claims; 13 in Echo Twp., and 6 in McAree Twp. as listed below:

In Echo Twp.

| | | |
|-----------|-----------|-----------|
| KRL 21448 | KRL 21453 | KRL 22678 |
| KRL 21449 | KRL 21454 | KRL 22679 |
| KRL 21450 | KRL 21455 | KRL 22680 |
| KRL 21451 | KRL 21456 | |
| KRL 21452 | KRL 21457 | |

In McAree Twp.

| | |
|-----------|-----------|
| KRL 22781 | KRL 22684 |
| KRL 22682 | KRL 22685 |
| KRL 22683 | KRL 22686 |

1/3

Diamond Drilling

Area

Report No

Work performed by:

| Claim No | Hole No | Footage | Date | Note |
|----------|---------|------------|------------|------|
| 21456 | 80-1 | 1460.0 | June 9/80 | |
| 21448 | 80-2 | 988.0 | Aug 11/80 | |
| 21447 | 80-3 | 271.0 | Aug 27/80 | |
| | 80-4 | 284.0 | June 25/80 | |
| | 80-5 | 209.0 | June 30/80 | |
| | 80-6 | 510.0 | July 9/80 | |
| | 80-7 | 486.0 | July 14/80 | |
| | 80-8 | 418.0 | July 15/80 | |
| | 80-9 | 474.0 | July 29/80 | |
| | 80-10 | 91.0 | July 31/80 | |
| | 80-11 | 380.0 | Aug 6/80 | |
| | 80-12 | 343.0 | Aug 7/80 | |
| | 80-13 | 622.0 | Aug 22/80 | |
| | 80-14 | 646.0 | Sept 3/80 | |
| | 80-15 | 357.0 | Sept 18/80 | |
| | 80-15A | 460.5 | Sept 24/80 | |
| <hr/> | | | | |
| | 16 DH | 7,999.5 FT | | |
| <hr/> | | | | |

Notes:

2/3

Diamond Drilling

Area

Report No

Work performed by:

| Claim No | Hole No | Footage | Date | Note |
|----------|---------|------------|------------|------|
| 21456 | 80-16 | 75.0 | Aug 13/80 | |
| 21448 | 80-17 | 161.0 | Aug 19/80 | |
| 21447 | 80-18 | 140.0 | Aug 22/80 | |
| | 80-19 | 580.0 | Aug 12/80 | |
| | 80-20 | 343.0 | Sept 24/80 | |
| | 80-21 | 395.0 | Aug 17/80 | |
| | 80-22 | 292.0 | Aug 26/80 | |
| | 80-23 | 465.0 | Aug 23/80 | |
| | 80-24 | 684.0 | Oct 22/80 | |
| | 80-25 | 554.0 | Oct 12/80 | |
| | 80-26 | 395.0 | Oct 31/80 | |
| | 80-27 | 384.0 | Nov 10/80 | |
| | 80-28 | 488.0 | Nov 22/80 | |
| | 80-29 | 562.0 | Nov 6/80 | |
| | 80-30 | 464.0 | Nov 16/80 | |
| | 80-31 | 700.0 | Aug 30/80 | |
| | 80-32 | 458.0 | Sept 4/80 | |
| <hr/> | | | | |
| | 17 D.H | 7,140.0 Ft | | |
| <hr/> | | | | |

Notes:

3/3

Diamond Drilling

Area

Report NQ

Work performed by:

| Claim NQ | Hole NQ | Footage | Date | Note |
|----------|--------------|-------------------|------------|------|
| 21456 | 80 - 33 | 74.0 | Sept 7/80 | |
| 21448 | 80 - 33A | 488.0 | Sept 18/80 | |
| 21447 | 80 - 34 | 448.0 | Sept 25/80 | |
| | 80 - 35 | 428.0 | Oct 4/80 | |
| | 80 - 36 | 577.5 | Oct 13/80 | |
| | 80 - 37 | 488.0 | Oct 13/80 | |
| | 80 - 38 | 298.0 | Oct 8/80 | |
| | 80 - 39 | 519.5 | Nov 2/80 | |
| | 80 - 40 | 298.0 | Oct 18/80 | |
| | 80 - 41 | 882.0 | Aug 10/80 | |
| | 80 - 42 | 248.0 | Oct 22/80 | |
| | 80 - 43 | 458.0 | Oct 23/80 | |
| | 80 - 44 | 503.0 | Nov 6/80 | |
| | <u>13 DH</u> | <u>5,710.0 FT</u> | | |

TOTALS - 46 DH 20,849.5 FT

Notes:

DIAMOND DRILL RECORD

WINDFALL OILS & MINES LTD.

HOLE NO. 80 - 1 SHEET NO. 1

LATITUDE _____ DATUM _____ STARTED _____
 DEPARTURE _____ BEARING (see next page for info.) COMPLETED _____
 ELEVATION _____ DIP _____ ULTIMATE DEPTH _____

| DEPTH FEET | FORMATION | SAMPLE NO. | FROM | TO | WIDTH | OZ Au |
|--------------|--|------------|------|----|-------|-------|
| 0 - 41 | Casing, mostly fine clay | | | | | |
| 41.0 - 87.3 | Andesite, amphibolized, dark greenish fine grained, some pillowed lava rims, and amygdules minor fine specs of PO and traces of Chalco-PY, some minor epidote alt'n at 73.0', the rock is dense and fine grained at 87.3', the gabbro contact is sharp and runs at 27 degrees to the core axis. From 72.5 - 73.0 | | | | | |
| 72.5 - 73.0 | Sample | 1 | | | .5 | Trace |
| | Anticite strongly epidotized, minor PY, PO, traces chalco, the three 1/2" QTZ stringers run perpendicular to the core. | | | | | |
| 87.2 - 445.0 | Gabbro, with a chilled contact at 87.3' which runs 27 degrees to core axis becomes progressively coarser grained over a 3' core section till it becomes med. grained, the main body of the gabbro is massive equigranular, it is composed of 50 - 60 % amphiboles and about 40% feldspar. The gabbro becomes progressively finer grained with magnetite and becomes similar to andicite. | | | | | |

CRK

DIAMOND DRILL RECORD

WINDFALL OILS & MINES LTD.

HOLE NO. 80 - 1 SHEET NO. 2

LATITUDE _____ DATUM _____ STARTED _____
 DEPARTURE _____ BEARING _____ COMPLETED _____
 ELEVATION _____ DIP _____ ULTIMATE DEPTH _____

| DEPTH FEET | FORMATION | SAMPLE NO | FROM | TO | WIDTH | OZS Au |
|---------------|--|-----------|------|----|-------|--------|
| 72.6 - 78.2 | Gabbro 2" glassy QTZ vien running 35 degrees to the core axis, traces of PY PO and chalco. | 2 | | | .6 | Trace |
| 135.0 - 135.5 | Gabbro, 1" glassy QTZ vien runs 30 degrees to core, minor PY PO. | 3 | | | .5 | tr |
| 138.5 - 139.5 | Gabbro, two 1/2" glassy QTZ stringers, minor PY PO. | 4 | | | 1.5 | tr |
| 143.0 - 144.5 | Gabbro, slightly sheared, 5% QTZ in stringers, trace PY PO. | 5 | | | 1.5 | tr |
| 153.2 - 154.0 | Gabbro, 30% glassy QTZ, running to 35 degrees core axis. | 6 | | | .8 | tr |
| 245.1 - 246.0 | Gabbro, 10% QTZ stringers, some epidote, minor PY in QTZ. | 7 | | | .9 | tr |
| Note: | At 238' and 245' there are slicken-sided fractures running at 10 degrees to core axis, this caused loss of water and required heavy cementing. | | | | | |
| 251.9 - 252.4 | Gabbro, 3" QTZ vienlet at 40 degrees to core looks barren. | 44 | | | .6 | tr |

P 11

DIAMOND DRILL RECORD

WINDFALL OILS & MINES LTD.

HOLE NO. 80 - 1 SHEET NO. 3

LATITUDE DATUM STARTED

DEPARTURE BEARING COMPLETED

ELEVATION DIP ULTIMATE DEPTH

| DEPTH FEET | FORMATION | SAMPLE NO | FROM | TO | WIDTH | OZS Au |
|---------------|--|-----------|------|----|-------|--------|
| 255.7 - 256.1 | Gabbro, 1/2" QTZ vienlet at 60 degrees to core, 2% PO. | 45 | | | .4 | tr |
| 262.7 - 263.2 | Gabbro, 1" QTZ vienlet at 50 degrees to core, minor PO | 46 | | | .5 | tr |
| 265.0 - 265.5 | Gabbro, 1" QTZ filled fracture at 45 degrees to core. 1/2% PO. | 47 | | | .5 | tr |
| 268.0 - 268.4 | Gabbro, 1" QTZ epidote vien. minor PO. | 48 | | | .4 | tr |
| 281.5 - 282.0 | Gabbro, 2" QTZ vien. glassy at 45 degrees to core, looks barren. | 49 | | | .5 | tr |
| 293.4 - 294.0 | Gabbro, two 1/2" QTZ vienlets epidote, minor PO | 50 | | | .6 | tr |
| 328.0 - 328.5 | Gabbro, two inch QTZ vienlet, 1% PO | 51 | | | .5 | tr |
| 335.0 - 335.6 | Gabbro, 1" QTZ chlorite vienlet, 2% PO, 1% PY trace chalco. | 52 | | | .6 | tr |
| 366.2 - 367.8 | Gabbro, two 1" QTZ vienlets at 45 degrees to core, looks barren | 53 | | | .6 | tr |
| 375.7 - 376.2 | Gabbro, 1" QTZ vienlet at 45 degrees to core, 1% PO, minor PY. | 54 | | | .5 | tr |
| 445.0 - 482.5 | QTZ- por'y dyke with 10% opalescent blue QTZ pheno's, the rock is brownish-grey with 1 - 2% PO and 10% fine biotite. The QTZ pheno's are up to 5mm in diameter. | | | | | |

DRILLED BY

Robert L. ...

SIGNED

[Signature]

DIAMOND DRILL RECORD

WINDFALL OILS & MINES LTD.

HOLE NO. 80 - 1 SHEET NO. 4

LATITUDE _____ DATUM _____ STARTED _____
 DEPARTURE _____ BEARING _____ COMPLETED _____
 ELEVATION _____ DIP _____ ULTIMATE DEPTH _____

| DEPTH FEET | FORMATION | SAMPLE NO | FROM | TO | WIDTH | OZS Au |
|---------------|---|-----------|------|----|-------|--------|
| 509.0 - 510.8 | QTZ por'y, sheared sericitic 4% dissem. PY minor sil'n. | 127 | | | 1.8 | tr |
| 512.7 - 516.0 | QTZ Por'y 3% dissem. PY | 128 | | | 3.3 | tr |
| 516.0 - 521.5 | QTZ Por'y, slightly sheared 2% dissem. PY, 1/2" QTZ, Stringer at 30 degrees to core | 129 | | | 5.5 | tr |
| 528.7 - 531.5 | QTZ Por'y, 3% dissem. PY, blue QTZ pheno's up to 5mm diam. | 130 | | | 2.8 | tr |
| 538.0 - 538.7 | QTZ Por'y, 1/2 " QTZ vienlet at 50 degrees to core, trace of chalco in QTZ, minor PY. | 131 | | | .7 | tr |
| 540.3 - 540.8 | QTZ Por'y, a 1/4" QTZ vienlet at 35 degrees to core, minor PY | 132 | | | .5 | tr |
| 542.3 - 543.5 | QTZ Por'y, a 1" barren QTZ vienlet at 39 degrees to core, minor PY | 133 | | | 1.2 | tr |
| 561.0 - 563.1 | QTZ Por'y, 3% dissem. PY | 134 | | | 2.1 | tr |
| 563.1 - 563.9 | QTZ por'y, slightly sheared, 7% dissem. PY | 135 | | | .8 | tr |
| 565.5 - 567.4 | QTZ Pot'y, slightly sheared, 1% dissem. PY | 136 | | | 1.9 | tr |
| 571.1 - 573.1 | QTZ Por'y, 3% dissem. PY | 137 | | | 2.0 | tr |
| 575.2 - 577.0 | QTZ Por'y, 3% dissem PY | 138 | | | 1.8 | tr |
| | | | | | | |
| | | | | | | |

DRILLED BY *Kenneth J. ...*

SIGNED *CKK*

DIAMOND DRILL RECORD

WINDFALL OILS & MINES LTD.

HOLE NO. 80 - 1 SHEET NO. 6

LATITUDE _____ DATUM _____ STARTED _____
 DEPARTURE _____ BEARING _____ COMPLETED _____
 ELEVATION _____ DIP _____ ULTIMATE DEPTH _____

| DEPTH FEET | FORMATION | SAMPLE NO. | FROM | TO | WIDTH | OZS. Au |
|---------------|---|------------|------|----|-------|---------|
| 653.0 - 656.2 | QTZ-por'y, partly sheared, 4% dissem. PY, 2% PY in fractures. | 164 | | | 3.2 | TR. |
| 657.0 - 659.2 | QTZ-por'y, slight sol'n, 3% dissem. PY | 165 | | | 2.2 | TR. |
| 670.7 - 672.3 | QTZ por'y, minor sol'n, 2% dissem. PY | 166 | | | 1.6 | TR. |
| 678.5 - 679.2 | QTZ-por'y, minor sol'n, 5% dissem. PY, minor PO and traces of chalco-pyrite and ZNS | 167 | | | .7 | TR. |
| 679.2 - 682.0 | QTZ-por'y, minor sol'n, partly bleached, 2% dissem. PY, 1/2% PO | 168 | | | 2.8 | TR. |
| 682.0 - 683.1 | QTZ-por'y, partly sil'd, 4% PY, 2% PO, traces ZNS | 169 | | | 1.1 | TR. |
| 687.3 - 689.0 | QTZ-por'y, minor sol'n, 4% dissem. PY, 1% PO | 170 | | | 1.7 | TR. |
| 694.7 - 696.7 | QTZ-por'y, partly sheared, 3% dissem. PY | 171 | | | 2.0 | TR. |
| 708.0 - 709.3 | QTZ-por'y, partly sheared, 2% dissem. PY | 172 | | | 1.3 | TR. |
| 713.0 - 715.8 | QTZ-por'y, partly sheared, slightly sol'd, 1% dissem. PY | 173 | | | 2.8 | TR. |
| 716.8 - 718.0 | QTZ-por'y, 1/2" glassy QTZ vienlet at 30 degrees to core axis, 1% PY, minor PO | 174 | | | 1.2 | TR. |
| 726.0 - 728.0 | QTZ-por'y, numerous hairline fractures filled with QTZ-carb. The QTZ-carb. is pink in part and carries 2% PY. | 175 | | | 2.0 | TR. |
| 736.3 - 738.4 | QTZ-por'y, numerous hairline fractures filled with QTZ-carb, 2% PY. | 176 | | | 2.1 | TR. |

DRILLED BY _____

SIGNED *CJK*

DIAMOND DRILL RECORD

WINDFALL OILS & SERVICES LTD.

HOLE NO. 80 - 1 SHEET NO. 2

LATITUDE _____ DATUM _____ STARTED _____
 DEPARTURE _____ BEARING _____ COMPLETED _____
 ELEVATION _____ DIP _____ ULTIMATE DEPTH _____

| DEPTH FEET | FORMATION | SAMPLE NO | FROM | TO | WIDTH | OZS. Au |
|---------------|--|-----------|------|----|-------|---------|
| NOTE: | To 739.0 the QTZ-por'y is greyish to buff in colour with 10% coarse bluish QTZ pheno's with some sericitization and some dissem. PY in sections, from 739.0 to the gabbro contact the QTZ-por'y becomes greyish, less sericitic but still contains about 5% coarse pheno's up to 6mm. in diameter. | | | | | |
| 749.0 - 750.0 | QTZ-por'y, partly sheared at 35 degrees to core, $\frac{1}{4}$ " QTZ-carb. stringer, 1% PY and 1/4% ZNS. | 177 | | | 1.0 | Tr. |
| 750.0 - 753.0 | QTZ-por'y, partly sheared, several 1/4" QTZ-carb. vienlets, 1/2% PY, traces ZNS. | 178 | | | 3.0 | Tr. |
| 766.8 - 825.7 | Gabbro, magnetic type, dark, greenish, med. g grained, 7% magnetite in grains, 1/2mm in diameter., It forms a sharp contact with QTZ-por'y at 766.8 which runs at 35 degrees to core axis. | | | | | |
| 819.6 - 820.7 | Gabbro, with 3 tongues of grano'd, cutting across gabbro the dykelets run at 65 degrees to the core axis, 1% dissem. PY | 179 | | | 1.1 | Tr. |
| 825.7 - 829.5 | Grano'd, partly fractured and sol'd, brownish, with contacts at 65 degrees to core axis. | | | | | |

DRILLED BY _____

SIGNED _____

[Handwritten Signature]

DIAMOND DRILL RECORD

WINDFALL OILS & MINES LTD.

HOLE NO. 80 - 1 SHEET NO. 8

LATITUDE _____ DATUM _____ STARTED _____
 DEPARTURE _____ BEARING _____ COMPLETED _____
 ELEVATION _____ DIP _____ ULTIMATE DEPTH _____

| DEPTH FEET | FORMATION | SAMPLE NO | FROM | TO | WIDTH | OZM Au |
|---------------|--|-----------|------|----|-------|--------|
| 829.5 - 839.5 | Magnetic gabbro, dk. greenish, medium grained, 5% magnetite partly sheared. | | | | | |
| 839.5 - 844.0 | Grano'd, greyish to brownish grey, with sol'd and alt'd sections, mineralized with PY, typical Goldlund #1 Zone grano'd. Probably represents the Windfall shaft grano'd block. | | | | | |
| 825.5 - 827.6 | Grano'd, pinkish, partly solificied, 2 1/4" QTZ vienlets at 40 degrees to the core, 3% dissem. PY | 180 | | | 2.1 | Tr. |
| 827.6 - 829.7 | Grano'd, some pinkish QTZ-carb alt'n, 2% dissem. PY. | 181 | | | 1.1 | Tr. |
| 834.2 - 836.6 | Gabbro, 5% QTZ in fractures, 3% dissem. PY, minor PO | 182 | | | 2.4 | Tr. |
| 839.6 - 843.1 | Grano'd, brownish grey, med. grained, 1% PY | 183 | | | 3.5 | Tr. |
| 843.1 - 844.3 | Grano'd, 3 1/4" QTZ vienlets in fractures running at 60 degrees to the core axis. Some minor wall rock sol'n, 3% dissem PY. | 184 | | | 1.2 | Tr. |
| 844.3 - 845.3 | Grano'd, strong QTZ-carb. alt'n, pinkish, 7% dissem. PY, looks good. | 185 | | | 1.0 | Tr. |
| 845.3 - 848.0 | Grano'd, greyish, med. grained, 2 1/4" QTZ fractures at 60 degrees to core, 1% dissem. PY | 186 | | | 2.7 | Tr. |
| 848.0 - 849.2 | Grano'd, slightly alt'd, 3% dissem. PY. | 187 | | | 1.2 | Tr. |

DRILLED BY

W. H. ...

SIGNED

W. H. ...

DIAMOND DRILL RECORD

WINDFALL OILS & MINES LTD.

HOLE NO. 80 - 1 SHEET NO. 9

LATITUDE _____ DATUM _____ STARTED _____
 DEPARTURE _____ BEARING _____ COMPLETED _____
 ELEVATION _____ DIP _____ ULTIMATE DEPTH _____

| DEPTH FEET' | FORMATION | SAMPLE NO | FROM | TO | WIDTH | OZS Au |
|---------------|--|-----------|------|----|-------|--------|
| 849.2 - 851.0 | Grano'd, greyish, 1/2% disse. PY | 188 | | | 1.8 | TR. |
| 851.0 - 851.8 | Grano'd, med. QTZ-carb. alt'n, 3% disse. PY, 2 1/4" QTZ filled fractures, | 189 | | | .1 | TR. |
| 851.8 - 853.5 | Grano'd, Grano'd, greyish, minor PY | 190 | | | 1.7 | TR. |
| 853.5 - 854.6 | Grano'd, strong QTZ-carb. alt'n, 4% disse. PY, looks good. | 191 | | | 1.1 | TR. |
| 854.6 - 856.6 | Grano'd, weak to med. QTZ-carb. alt'n, 2% dissem PY | 192 | | | 2.0 | TR. |
| 856.6 - 859.3 | Grano'd, greyish, looks barren | 193 | | | 2.7 | TR. |
| 859.3 - 860.7 | Grano'd, med. QTZ-carb alt'n, 3% disse. PY | 194 | | | 1.4 | TR. |
| 860.7 - 862.4 | Grano'd, greyish, weak QTZ-carb alt'n, 1% disse. PY | 195 | | | 1.7 | TR. |
| 862.4 - 864.9 | Grano'd, greyish, minor QTZ-carb. alt'n, 1% PY | 196 | | | 2.5 | TR. |
| 864.9 - 866.5 | Grano'd, greyish, 2 1/4" QTZ filled fractures with disseminated PY | 247 | | | 1.6 | TR. |
| 866.5 - 870.2 | Grano'd, greyish, med. grained, looks barren. | 248 | | | 3.7 | TR. |
| 870.2 - 873.0 | QTZ-por'y, lge blue QTZ pheno's, sharp contact at 50 degrees to core axis, minor sol'n, 2% PY | 249 | | | 2.8 | TR. |
| 873.0 - 873.7 | Grano'd, greyish, med. grained, looks barren. | 250 | | | .7 | TR. |
| 873.7 - 876.2 | QTZ-por'y dyke, lrg blue QTZ pheno's, looks barren | 251 | | | 2.5 | TR. |

DRILLED BY _____

SIGNED _____

CJK

DIAMOND DRILL RECORD

WINDFALL OILS & MINES LTD.

HOLE NO. ... 80 - 1 ... SHEET NO. ... 10 ...

LATITUDE _____ DATUM _____ STARTED _____
 DEPARTURE _____ BEARING _____ COMPLETED _____
 ELEVATION _____ DIP _____ ULTIMATE DEPTH _____

| DEPTH FEET | FORMATION | SAMPLE NO. | FROM | TO | WIDTH | OZS. Au |
|-------------------------|---|------------|------|----|-------|---------|
| 876.2 - 877.3 | Grano'd, greyish, med grained, looks barren | 252 | | | 1.1' | tr |
| 877.3 - 878.6 | QTZ-por'y dyke, large blue QTZ pheno's, looks barren. | 253 | | | 1.3' | tr |
| 878.6 - 879.4 | QTZ-pory, strong QTZ-carb. alt'n, 3% dissem. PY | 254 | | | 0.8' | tr |
| 879.4 - 882.0 | Grano'd, greyish, looks barren | 255 | | | 2.6' | tr |
| 882.0 - 882.5 | Grano'd, 1/4" QTZ stringer at 55 degrees to core | 256 | | | 0.5' | tr |
| <i>sample 257 below</i> | with 2" of wall rock alt'n, carries 5% dissem. PY | | | | | |
| * 886.0 - 888.8 | Grano'd, greyish, minor QTZ, minor PY | 258 * | | | 2.8' | tr |
| 888.8 - 891.5 | QTZ-por'y, 20% large white pheno's, 5% QTZ infractions | 259 | | | 2.7' | tr |
| 891.5 - 895.5 | QTZ-por'y, 20% white QTZ pheno, minor QTZ, minor PY | 260 | | | 4.0' | tr |
| 895.5 - 899.0 | Grano'd, greyish, med. grained, looks barren | 261 | | | 3.5' | tr |
| 899.0 - 903.5 | Grano'd, greyish, med. grained, minor QTZ, minor PY | 262 | | | 3.5' | tr |
| 903.5 - 920.3 | Andesitic tuff greyish to brownish grey, finely banded with white calcitic amygdule-like flecks, the banding undulates along the core, minor QTZ, mineralization. | | | | | |
| * 882.5 - 886.0 | Grano'd, greyish, minor QTZ, minor PY | 257 | | | 3.5' | tr |

DRILLED BY *Handwritten Name*

SIGNED *[Signature]*

DIAMOND DRILL RECORD

WINDFALL OILS & MINES LTD.

HOLE NO. 80 - 1 SHEET NO. 11

LATITUDE _____ DATUM _____ STARTED _____
 DEPARTURE _____ BEARING _____ COMPLETED _____
 ELEVATION _____ DIP _____ ULTIMATE DEPTH _____

| DEPTH FEET | FORMATION | SAMPLE NO. | FROM | TO | WIDTH | OZS Au |
|---------------|---|------------|------|----|-------|--------|
| 903.5 - 905.8 | Largely andesite, with 3 1"QTZ vienlets, minor PY | 263 | | | 2.8' | tr |
| 905.8 - 911.0 | Andesitic tuff, minor QTZ, minor PY | 264 | | | 6.8' | tr |
| 911.0 - 916.0 | Andesitic tuff, minor QTZ, minor PY | 265 | | | 5.0' | .01 |
| 916.0 - 917.5 | 80% andesite, 20% grano'd, several irregular QTZ stringers, minor PY | 266 | | | 1.5' | .01 |
| 917.5 - 920.5 | 10% andesitic tuff, 90% grano'd with contacts at 35 degrees to core, looks barren | 267 | | | 3.0' | tr |
| 920.5 - 922.5 | Grano'd, greyish, med. grained, minor QTZ, minor PY | 268 | | | 2.0' | tr |
| 922.5 - 928.0 | Grano'd, med. grained, greyish, looks barren | 269 | | | 6.0' | Tr |
| 928.0 - 933.0 | Grano'd, greyish, med. grained, minor QTZ. | 270 | | | 5.0' | Tr |
| 933.0 - 935.4 | Andesitic tuff, finely banded. 10% irregular QTZ contacts at 30 degrees to core, 1% PY | 271 | | | 2.4' | Tr |
| 935.4 - 938.0 | Grano'd, greyish, med. grained, looks barren | 272 | | | 2.6' | Tr |
| 938.0 - 941.4 | Grano'd, greyish, med grained, minor QTZ, minor PY | 273 | | | 3.4' | Tr |
| 941.4 - 943.5 | Grano'd, greyish, several 1/8" QTZ fractures at 65 degrees to core, 2% fine PY, lots of faults | 274 | | | 2.1' | Tr |
| 943.5 - 944.5 | Grano'd, 10% QTZ stringers, 1/2% PY at 944.3 | 275 | | | 1.0' | Tr |
| NOTE: | 944.3 - 944.5 A fault with 2" of waxy sericitic | | | | | |

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DIAMOND DRILL RECORD WINDFALL OILS & MINES LTD.

HOLE NO. 80 - 1 SHEET NO. 12

LATITUDE _____ DATUM _____ STARTED _____
 DEPARTURE _____ BEARING _____ COMPLETED _____
 ELEVATION _____ DIP _____ ULTIMATE DEPTH _____

| DEPTH FEET | FORMATION | SAMPLE NO. | FROM | TO | WIDTH | OZS Au |
|---------------|--|------------|------|----|-------|--------|
| | alt'n. The fault runs at 65 degrees to the core | | | | | |
| 944.5 - 948.0 | Grano'd, dk greyish, fine to med. grained, minor QTZ, minor PY. | 276 | | | 3.5' | Tr |
| 948.0 - 953.0 | Grano'd, dk greyish, fine grained, minor QTZ, minor PY | 277 | | | 5.0' | Tr |
| 953.0 - 955.7 | Grano'd, greyish, fine grained, some QTZ in hairline fractures, mineralized with fine disseminated PY | 278 | | | 2.7' | Tr |
| 955.7 - 958.0 | Grano'd, greyish, fine grained, 5% QTZ in hairline fractures at 60 degrees to core, 1% disseminated PY | 279 | | | 2.3' | Tr |
| 958.0 - 960.7 | Grano'd, greyish, fine grained, 5% QTZ in hairline fractures at 60 degrees to core, 1% disseminated PY | 280 | | | 2.7' | Tr |
| 960.7 - 963.7 | Grano'd, greyish, fine to med grained, 5% QTZ in fractures at 60 degrees to core, 1/2% PY | 281 | | | 3.0' | Tr |
| 963.7 - 966.7 | Grano'd, greyish, fine to med. grained, 5% QTZ in fractures at 60 degrees to core 1% PY | 282 | | | 3.0' | Tr |
| 966.7 - 969.7 | Grano'd, 10% QTZ in stringers, 1% PY | 283 | | | 3.0' | Tr |
| 969.7 - 972.7 | Grano'd, med. grained. minor QTZ, minor PY | 284 | | | 3.0' | Tr |
| 972.7 - 974.6 | Grano'd, med. grained, 5% QTZ, 1/2% PY | 285 | | | 1.9' | Tr |
| 974.6 - 976.6 | Grano'd, minor QTZ, 1/2% PY | 286 | | | 2.0' | Tr |

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DIAMOND DRILL RECORD

WINDFALL OILS & MINES LTD.

HOLE NO. 80 - 1 SHEET NO. 13

LATITUDE _____ DATUM _____ STARTED _____
 DEPARTURE _____ BEARING _____ COMPLETED _____
 ELEVATION _____ DIP _____ ULTIMATE DEPTH _____

| DEPTH FEET | FORMATION | SAMPLE NO. | FROM | TO | WIDTH | OZS Au |
|----------------|--|------------|------|----|-------|--------|
| 976.6 - 979.5 | Grano'd, 5% QTZ in fractures, 1/2% PY | 287 | | | 2.9' | Tr |
| 979.5 - 982.0 | Grano'd, 3% QTZ in fractures at 60 degrees to core 1% PY | 288 | | | 2.5' | Tr |
| 982.0 - 984.0 | Grano'd, 5% QTZ in fractures at 60 degrees to core, 2% dissem. PY | 289 | | | 2.0' | Tr |
| 984.0 - 987.0 | Grano'd, 5% QTZ in fractures, 1 1/2% PY | 290 | | | 3.0' | Tr |
| NOTE: | At 285.0' 1" section of breccia which indicates a late fault at 60 degrees to core axis. | | | | | |
| 987.0 - 989.3 | Grano'd, med grained, 5% QTZ in fractures, 1% dissem Py | 291 | | | 2.3' | Tr |
| 989.3 - 992.0 | Grano'd, greyish, minor QTZ, minor PY | 292 | | | 2.7' | Tr |
| 992.0 - 996.0 | Grano'd, med. grained, minor QTZ, minor PY | 293 | | | 4.0' | Tr |
| 996.0 - 998.5 | Grano'd, 5% QTZ in fractures, 1/2% PY | 294 | | | 2.5' | .01 |
| NOTE: | 998.5 - 999.5 1/8" black line fault runs at 15 degrees to core, it contains some blue QTZ along the fault. | | | | | |
| 998.5 - 1001.4 | Grano'd, greyish, med. grained, minor QTZ, 1% PY | 295 | | | 3.4' | Tr |

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DIAMOND DRILL RECORD

WINDFALL OILS & MINES LTD.

HOLE NO. 80 - 1 SHEET NO. 14

LATITUDE _____ DATUM _____ STARTED _____
 DEPARTURE _____ BEARING _____ COMPLETED _____
 ELEVATION _____ DIP _____ ULTIMATE DEPTH _____

| DEPTH FEET | FORMATION | SAMPLE NO | FROM | TO | WIDTH | OZ Au |
|-----------------|--|-----------|------|----|-------|-------|
| 1001.4 - 1004.4 | Grano'd, greyish, med grained, minor QTZ, minor PY | 296 | | | 3.0' | Tr |
| NOTE: | 998.5 - 1029.0 The grano'd is brownish grey, med. grained, partly biotitic, this block is caught between two faults. A black line fault at 999.0 running at 10 degrees to core and sericitic and black line fault that runs at 25 degrees to the core at 1029.0. This grano'd forms a slip block against the major fault at 1029.0 | | | | | |
| | 1029.0 - is grano'd coarse grained, light greenish grey, brecciated in part, at 1035 it contains several black line faults which is part of a horse tail fault displacement system. The following are the locations of the black line faults: | | | | | |
| | 999.0 at 10 degrees to core axis | | | | | |
| | 1029.0 ' '30 ' | | | | | |
| | 1056.0 ' '10 ' | | | | | |
| | 1056.5 ' '60 ' | | | | | |

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DIAMOND DRILL RECORD

WINDFALL OILS & MINES LTD.

HOLE NO. 80 - 1 SHEET NO. 16

LATITUDE _____ DATUM _____ STARTED _____
 DEPARTURE _____ BEARING _____ COMPLETED _____
 ELEVATION _____ DIP _____ ULTIMATE DEPTH _____

| DEPTH FEET | FORMATION | SAMPLE NO | FROM | TO | WIDTH | OZS Au |
|-----------------|---|-----------|------|----|-------|--------|
| 1040.0 - 1041.7 | Grano'd, coarse grained, 3% QTZ in fractures, 1/2 1/2% PY | 308 | | | 1.7' | .02 |
| 1041.7 - 1045.0 | Grano'd, coarse grained texture, minor QTZ, minor PY | 309 | | | 3.3' | .03 |
| 1045.0 - 1049.0 | Grano'd, greyish, coarse grained, minor QTZ, minor PY | 310 | | | 4.0' | Tr |
| 1049.0 - 1050.8 | Grano'd, coarse grained, 5% QTZ in fractures, minor PY | 311 | | | 1.8' | Tr |
| 1050.8 - 1051.7 | Grano'd, coarse grained, 3" grey QTZ vien with 3% PY, 1% PO | 312 | | | 0.9' | Tr |
| 1051.7 - 1056.0 | Grano'd, coarse grained with some coarse PY along th black line fault which runs along the core from 1055.0 - 1056.0 | 313 | | | 4.3' | Tr |
| 1056.0 - 1059.1 | Grano'd, greyish, coarse grained with black line faults at 1056 to 1058, minor QTZ, 1% coarse PY largely along the faults | 314 | | | 3.1' | Tr |
| 1059.1 - 1061.0 | Grano'd, coarse grained, minor QTZ, minor PY | 315 | | | 1.9' | Tr |
| 1061.0 - 1062.8 | Grano'd, coarse grained with black line faults at 1061.3 and some coarse PY cubes along the fault | 316 | | | 1.8' | .01 |
| 1062.8 - 1064.4 | Grano'd, coarse grained, looks barren | 317 | | | 1.6' | .01 |

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DIAMOND DRILL RECORD

WINDFALL OILS & MINES LTD.

HOLE NO. 80 - 1 SHEET NO. 17

LATITUDE _____ DATUM _____ STARTED _____

DEPARTURE _____ BEARING _____ COMPLETED _____

ELEVATION _____ DIP _____ ULTIMATE DEPTH _____

| DEPTH FEET | FORMATION | SAMPLE NO. | FROM | TO | WIDTH | OZS. Au |
|-----------------|--|------------|------|----|-------|---------|
| 1064.4 - 1067.7 | Grano'd, bluish grey, coarse grained, looks barren | 318 | | | 3.3' | Tr |
| 1067.7 - 1069.3 | Grano'd, coarse grained, 1" QTZ vien at 55 degrees to core, 1% dissem. PY in wall rock | 319 | | | 1.6' | Tr |
| 1069.3 - 1071.0 | Grano'd, coarse grained, 2 1/4" QTZ vienlets at 55 degrees to core, 1% PY | 320 | | | 1.7' | .01 |
| 1071.0 - 1073.5 | Grano'd, coarse grained, minor QTZ, 1/2% PY | 321 | | | 2.5' | Tr |
| 1073.5 - 1076.0 | Grano'd, coarse grained, minor QTZ in stringers, 1/2% PY | 322 | | | 3.0' | Tr |
| 1076.0 - 1078.0 | Grano'd, coarse grained with a black line fault which carries some coarse PY along side it | 323 | | | 2.0' | .01 |
| 1078.0 - 1080.4 | Grano'd, coarse grained, minor QTZ, 1/2% PY | 324 | | | 2.4' | Tr |
| 1080.4 - 1082.7 | Grano'd, coarse grained, 1/2" QTZ vienlet, 1/2% PY | 325 | | | 0.3' | Tr |
| 1082.7 - 1085.4 | Grano'd, coarse grained, 7% QTZ in fractures, 1% coarse PY | 326 | | | 2.7' | Tr |
| 1085.4 - 1087.8 | Grano'd, coarse grained, minor QTZ, minor PY | 327 | | | 2.4' | Tr |
| 1087.8 - 1089.8 | Grano'd, 5% QTZ in fractures, 1% coarse PY | 328 | | | 2.0' | Tr |
| 1089.8 - 1092.0 | Grano'd, coarse grained, looks barren | 329 | | | 2.2' | Tr |
| 1092.0 - 1094.0 | Grano'd, coarse grained, 5% QTZ in fractures, 1% PY | 330 | | | 2.0' | Tr |

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DIAMOND DRILL RECORD

WINDFALL OILS & MINES LTD.

HOLE NO. 80 - 1 SHEET NO. 18

LATITUDE _____ DATUM _____ STARTED _____

DEPARTURE _____ BEARING _____ COMPLETED _____

ELEVATION _____ DIP _____ ULTIMATE DEPTH _____

| DEPTH FEET | FORMATION | SAMPLE NO. | FROM | TO | WIDTH | OZS Au |
|-----------------|---|------------|------|----|-------|--------|
| 1094.0 - 1098.0 | Grano'd, coarse grained, looks barren | 331 | | | 4.0' | Tr |
| 1098.0 - 1104.0 | Grano'd, coarse grained, looks barren | 332 | | | 6.0' | Tr |
| 1104.0 - 1106.0 | Grano'd, coarse grained, 5% QTZ in fractures, 1% coarse PY | 333 | | | 2.0' | .02 |
| 1106.0 - 1107.0 | Grano'd, coarse grained, 1/4" QTZ fracture at 55 degrees to core with wall rock alt'n which carries 5% coarse PY | 334 | | | 1.0' | .05 |
| 1107.0 - 1108.0 | Grano'd, coarse grained, looks barren | 335 | | | 1.0' | Tr |
| 1108.0 - 1110.2 | Grano'd, coarse grained, 20% QTZ in glassy fr fractures a 55 degrees to core, 1% coarse PY | 336 | | | 2.2' | Tr |
| 1110.2 - 1112.4 | Grano'd, coarse grained, 5% QTZ in fine fract- ures, 1/2% PY | 337 | | | 2.2' | Tr |
| 1112.4 - 1116.0 | Grano'd, coarse grained, 3% QTZ in fine fract- ures, minor PY | 338 | | | 3.6' | Tr |
| 1116.0 - 1117.2 | Grano'd, with 5% QTZ in fractures, 1/2% PY, t traces of chalco-pyrite at 1117.0 | 339 | | | 1.2' | Tr |
| 1117.2 - 1121.0 | Grano'd, coarse grained, minor QTZ, minor PY | 340 | | | 3.8' | Tr |
| 1121.0 - 1121.8 | Grano'd, coarse grained, 1 1/2" QTZ vein running at 60 degrees to core, 3% coarse PY in alt'n wall rock, looks good | 341 | | | 0.8' | .02 |
| 1121.0 - 1124.0 | Grano'd, coarse grained, looks barren | 342 | | | 2.2' | Tr |

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DIAMOND DRILL RECORD

WINDFALL OILS & MINES LTD.

HOLE NO. 80 - 1 SHEET NO. 19

LATITUDE _____ DATUM _____ STARTED _____
 DEPARTURE _____ BEARING _____ COMPLETED _____
 ELEVATION _____ DIP _____ ULTIMATE DEPTH _____

| DEPTH FEET | FORMATION | SAMPLE NO. | FROM | TO | WIDTH | OZS Au |
|-----------------|--|------------|------|----|-------|--------|
| 1124.0 - 1127.3 | Grano'd, coarse grained, minor QTZ, minor PY | 343 | | | 3.3' | Tr |
| 1127.3 - 1129.0 | Grano'd, coarse grained, looks barren | 344 | | | 1.7' | Tr |
| 1129.0 - 1133.0 | Grano'd, 5% QTZ in fractures, 1/2% PY | 345 | | | 4.0' | Tr |
| 1133.0 - 1135.3 | Grano'd, coarse grained, 5% QTZ in fractures, 1% dissem. PY | 346 | | | 2.3' | .01 |
| NOTE: | 1135.3 - 1164.0 This possibly the projection of the Goldlund 103-104 structure. It consists of coarse, greyish grano'd, interlaced with n numerous QTZ fractures running at 50-70 degrees to core axis. Considerable bleaching and wall rock QTZ-carb. alt'n and well mineralized with coarse cubes of PY in the alt'd wall rock, it looks good. | | | | | |
| 1135.3 - 1137.0 | Grano'd, coarse grained, 15% QTZ, 3% coarse PY in wall rock alt'n | 347 | | | 1.7' | .02 |
| 1137.0 - 1139.0 | Grano'd, crse grained, 15% QTZ in fractures, 3% coarse PY in wall rock alt'n | 348 | | | 2.0' | .01 |
| 1139.0 - 1140.6 | Grano'd, coarse grained, strong wall rock alt'n 5% coarse PY, looks good | 349 | | | 1.6' | .04 |

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DIAMOND DRILL RECORD

WINDFALL OILS & MINES LTD.

HOLE NO. 80 - 1 SHEET NO. 20

LATITUDE _____ DATUM _____ STARTED _____
 DEPARTURE _____ BEARING _____ COMPLETED _____
 ELEVATION _____ DIP _____ ULTIMATE DEPTH _____

| DEPTH FEET | FORMATION | SAMPLE NO. | FROM | TO | WIDTH | OZS Au |
|-----------------|--|------------|------|----|-------|--------|
| 1140.6 - 1142.3 | Grano'd, coarse grained, 20% QTZ in fractures strong wall rock alt'n, 5% coarse PY, looks good | 350 | | | 1.7' | .03 |
| 1142.3 - 1143.0 | Grano'd, coarse grained, 30% QTZ in fractures, strong wall rock alt'n, 7% coarse PY, looks good | 351 | | | 0.7' | .07 |
| 1143.0 - 1144.2 | Grano'd, coarse grained, strong wall rock alt'n secondary QTZ in fractures, 4% coarse PY, looks good | 352 | | | 1.2' | .02 |
| 1144.2 - 1145.5 | Grano'd, coarse grained, 20% QTZ, strong wall rock alt'n, 7% coarse PY, looks good | 353 | | | 1.3' | .11 |
| 1145.5 - 1147.0 | Grano'd, coarse grained, 5% QTZ in fractures; med wall rock alt'n, 2% PY | 354 | | | 1.5' | .02 |
| 1147.0 - 1148.6 | Grano'd, coarse grained, strong wall rock alt'n 20% QTZ, 10% coarse PY, looks good | 355 | | | 1.6' | .03 |
| NOTE: | Some minor hematitic alt'n gives the rock a slight reddish hue | | | | | |
| 1148.6 - 1150.1 | Grano'd, coarse grained, 5% QTZ in fractures, minor PY | 356 | | | 1.5' | .10 |
| 1150.1 - 1152.0 | Grano'd, coarse grained, 5% QTZ in fractures, 1% PY | 357 | | | 1.9' | .02 |

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DIAMOND DRILL RECORD

WINDFALL OILS & MINES LTD.

HOLE NO. 80 - 1 SHEET NO. 21

LATITUDE _____ DATUM _____ STARTED _____
 DEPARTURE _____ BEARING _____ COMPLETED _____
 ELEVATION _____ DIP _____ ULTIMATE DEPTH _____

| DEPTH FEET | FORMATION | SAMPLE NO | FROM | TO | WIDTH | OZS Au |
|------------------|---|-----------|------|----|-------|--------|
| 1152.0 - 1153.7 | Grano'd, coarse grained, 10% QTZ in fractures, med. QTZ-carb alt'n, 3 % PY | 358 | | | 1.7' | Tr |
| 1153.7 - 1154.7 | Grano'd, Coarse grained, 10% QTZ, strong wall rock alt'n, 7% coarse PY, looks good | 359 | | | 1.0' | .05 |
| 1154.7 - 1156.4 | Grano'd, coarse grained, 10% QTZ, 1% PY | 360 | | | 1.7' | .04 |
| 1156.4 - 1157.7 | Grano'd, coarse grained, 10% QTZ, weak QTZ carb alt'n, 1% PY | 361 | | | 1.3' | Tr |
| 1157.7 - 1160.0 | Grano'd, coarse grained, minor QTZ, minor PY | 362 | | | 2.3' | Tr |
| 1160.0 - 1163.0 | Grano'd, coarse grained, 5% QTZ, 1/2% PY | 363 | | | 3.0' | Tr |
| 1163.0, - 1164.2 | Grano'd, coarse grained, med. QTZ-carb alt'n 3% coarse PY | 364 | | | 1.2' | .03 |
| 1164.2 - 1168.0 | Grano'd, coarse grained, minor PY, minor QTZ | 365 | | | 3.8' | .02 |
| 1168.0 - 1172.0 | Grano'd, coarse grained, 5% QTZ in fractures, minor PY | 366 | | | 4.0' | Tr |
| NOTE: | 1163 - 1248 , Note the grano'd is greyish to greenish grey, med graine and generally barren, with widely spaced narrow QTZ filled fractures. This is similar to the hanging wall, barren grano'd dyke above the west zone dyke at the Goldlund mine | | | | | |

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DIAMOND DRILL RECORD

WINDFALL OILS & MINES LTD.

HOLE NO. 80 - 1 SHEET NO. 22

LATITUDE _____ DATUM _____ STARTED _____
 DEPARTURE _____ BEARING _____ COMPLETED _____
 ELEVATION _____ DIP _____ ULTIMATE DEPTH _____

| DEPTH FEET | FORMATION | SAMPLE NO. | FROM | TO | WIDTH | OZs Au |
|-----------------|---|------------|------|----|-------|--------|
| 1172.5 - 1173.2 | Grano'd, 1/2" QTZ filled fracture at 50 degrees to core, minor PY | 367 | | | 0.7' | Tr |
| 1175.4 - 1176.0 | Grano'd, 1" glassy QTZ vien at 60 degrees to core, minor PY | 368 | | | 0.6' | Tr |
| 1176.6 - 1177.6 | Grano'd, 2 1/4" QTZ stringers, minor PY | 369 | | | 1.0' | .01 |
| 1183.0 - 1183.6 | Grano'd, 1/2" QTZ vienlet at 50 degrees to core, 1% PY | 370 | | | 0.6' | Tr |
| 1195.6 - 1196.8 | Grano'd, 1" and 1/2" QTZ-carb vienlet at 50 degrees to core, 1% PY | 371 | | | 1.2' | .01 |
| 1208.0 - 1209.2 | Grano'd, 1" and 1/2" QTZ vienlet at 55 degrees to core, coarse grain of ZNS and a caarse grain of chalco with PO in 1/2" vien at 1208.2 | 372 | | | 1.2' | .01 |
| 1223.0 - 1213.8 | Grano'd, 1 1/2" QTZ vienlet with 5 in. wall rock alt'n, 2% PO, 1% PY | 373 | | | 0.8' | Tr |
| 1222.8 - 1223.6 | Grano'd, 1" glassy QTZ vien at 55 degrees to core, minor PY | 374 | | | 0.8' | Tr |
| 1234.2 - 1236.3 | Grano'd, several 1/4" QTZ filled fractums at 234.7 a vienlet carries massive Po with traces chalco, some weak wall rock QTZ-carb alt'n | 375 | | | 2.1' | Tr |
| 1279.0 - 1280.6 | Andesitic Tuff caught between grano'd with contacts at 40 degrees to core | | | | | |

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DIAMOND DRILL RECORD

WINDFALL OILS & MINES LTD.

HOLE NO. 80 - 1 SHEET NO. 23

LATITUDE _____ DATUM _____ STARTED _____
 DEPARTURE _____ BEARING _____ COMPLETED _____
 ELEVATION _____ DIP _____ ULTIMATE DEPTH _____

| DEPTH FEET | FORMATION | SAMPLE NO | FROM | TO | WIDTH | OZS Au |
|------------------|--|-----------|------|----|-------|--------|
| 1280.6 - 1288.6 | Grano'd, dyke, med. grained, dark greyish | | | | | |
| 1288.6 - 1290.0 | Tuff, dark greenish grey, finely banded | | | | | |
| 1290.0 - (1305+) | QTZ-por'y dyke, waxy sericitic, the contact at 1290.0 runs at 35 degrees to core | | | | | |
| 1283.0 - 1283.7 | Grano'd, a 1" glassy QTZ vien at 60 degrees to core, 1% PY, 1% PO in wall rock | 377 | | | 0.7' | .01 |
| 1309.3 - 1312.3 | QTZ- por'y, 5% QTZ in fractures, 1% PY | 639 | | | 3.0' | Tr |
| 1313.0 - 1317.5 | Grano'd, greyish, coarse grained, looks barren | | | | | |
| 1318.5 - 1375.0 | Grano'd, greyish, coarse grained, very little fracturing developed, it looks massive, and generally barren | | | | | |
| 1324.8 - 1325.3 | Grano'd, 1/2" QTZ vienlet, minor PY | 640 | | | 0.5' | Tr |
| 1342.0 - 1342.5 | Grano'd, a 1/2" QTZ vienlet at 60 degrees to core, looks barren | 641 | | | 0.5' | Tr |
| 1360.5 - 1362.3 | Grano'd, four 1/4" QTZ vienlets, minor PY | 642 | | | 1.8' | Tr |
| 1375.0 - 1378.7 | Tuff, greenish grey, finely banded with amygdule-like QTZ-carb flecs, finely banded at 30 degrees to core | | | | | |
| 1378.7 - 1383.7 | Grano'd, greenish grey coarse grained | | | | | |
| 1383.7 - 1388.0 | Tuff, greenish grey, finely banded at 25 degrees to core | | | | | |

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DIAMOND DRILL RECORD

WINDFALL OILS & MINES LTD.

HOLE NO. 80 - 1 SHEET NO. 24

LATITUDE _____ DATUM _____ STARTED _____
 DEPARTURE _____ BEARING _____ COMPLETED _____
 ELEVATION _____ DIP _____ ULTIMATE DEPTH _____

| DEPTH FEET | FORMATION | SAMPLE NO | FROM | TO | WIDTH | OZS Au |
|-----------------|--|-----------|------|----|-------|--------|
| 1388.0 - 1460.0 | Grano'd, greenish grey, fine to med. grained, slightly more basic in composition | | | | | |
| 1398.5 - 1399.0 | Grano'd, a 1/4" q-c vienlet with 2% PO, 1% PY, and trace of chalco | 643 | | | 0.5' | .03 |
| 1420.6 - 1421.1 | Grano'd, a 1/2" QTZ vienlet at 60 degrees to core minor PY | 644 | | | 0.5' | .03 |
| 1425.0 - 1425.5 | Grano'd, a silicified fracture carries heavy PO, some PY, minor chalco | 645 | | | 0.5' | Tr |
| 1438.5 - 1439.0 | Grano'd, 1/2" QTZ vienlet at 65 degrees to core, looks barren | 646 | | | 0.5' | Tr |
| 1447.5 - 1448.0 | Grano'd, a 1/2" QTZ vien at 65 degrees to core, looks barren | 647 | | | 0.5' | .02 |
| 1460.0' | END OF HOLE | | | | | |
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C. J. Kuyleni

DIAMOND DRILL RECORD


WINDFALL OILS & MINES LTD.

HOLE NO. 80 - 2 SHEET NO. 1

LATITUDE 13525.5
 DEPARTURE 12107.4
 ELEVATION 9914.0

DATUM BQ core stored in office at Windfall STARTED July 21, 1980
 BEARING S - 3° - W COMPLETED August 11, 1980
 DIP 62° Collar Ft 100. Horiz. Vert ULTIMATE DEPTH 988.0'

| DEPTH FEET | FORMATION | SAMPLE NO. | FROM | TO | WIDTH | OZS Au |
|---------------|--|------------|------|----|-------|--------|
| 0 - 43.0 | Casing in clay overburden | | | | | |
| 43.0 - 54.5 | Andesitic tuff, dark greenish, finely banded at 15 degrees to core, some PY, calco-PY and ZNS mineralization up against gabbro dyke | | | | | |
| 52.6 - 54.5 | Dark greenish, andesitic tuff, 5% QTZ, 2% PY 1/4% chalco-PY, minor ZNS | 666 | | | 1.9' | Tr |
| 54.5 - 303.0 | Gabbro with 3' of finer grained chilled contact zone, minor PY & PO throughout with some narrow BX at 110.0 and 121.0 that runs at 25 degrees to core. From 280.0 - 303.0 the foot wall of the gabbro dyke is mineralized with 2% 1/2" blebs of sulphides, largely PO with PY, chalco and pentlandite? | | | | | |
| 145.0 - 148.0 | Gabbro from a glassy 2" 1" and 1/2" QTZ vienlets, minor PY | 667 | | | 3.0' | Tr |
| 150.0 - 151.4 | Gabbro a 6" glassy QTZ vien runs at 15 degrees to core, it carries 2% PY, 1% PO and 1/4% chalco-PY | 668 | | | 4' | Tr |

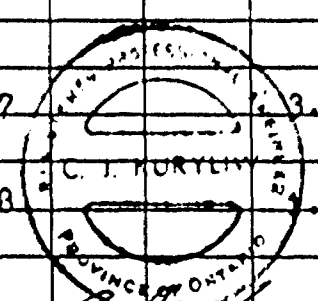

C. J. Kortlin

DRILLED BY George A. ...

**DIAMOND DRILL RECORD
WINDFALL OILS & MINES LTD.**

HOLE NO. 80 - 2 SHEET NO. 2

LATITUDE _____ DATUM _____ STARTED _____
 DEPARTURE _____ BEARING _____ COMPLETED _____
 ELEVATION _____ DIP _____ ULTIMATE DEPTH _____

| DEPTH FEET | FORMATION | SAMPLE NO. | FROM | TO | WIDTH | OZS. Au |
|---------------|---|------------|------|----|-------|---------|
| 302.0 - 303.0 | Glassy white QTZ viens at gabbro contact at 25 degrees to core. minro PO | 722 | | | 1.0' | Tr |
| 303.0 - 386.0 | Andesitic pillow lava, dark greenish grey, banded with amygdule like QTZ-carb flecks. Upon further examination the apparent banding occurs between amydaloidal pillow rims | | | | | |
| 307.0 - 307.7 | Andesitic pillow lava with a 1/2" QTZ-carb vienlet at 30 degrees to core. It carries 2%PO, 1% PY, 1/4% Chalco | 723 | | | 0.7' | Tr |
| 386.0 - 463.5 | QTZ-por'y dyke, sericitic, buff grey in colour, with 10% blue QTZ pheno-crysts up to 6mm in diam. some minor dissem PY | | | | | |
| 463.5 - 541.0 | Andesitic pillow lava with obvious amygdaloidal pillow rims. Some mineralization occurs along pillow rims which consists of magnetite, PO, PY and rarely chalco | | | | | |
| 499.0 - 501.8 | Andesitic pillow lava, 1% PY, 1% PO along pil- low rims. Two 1/8" wiggly QTZ stringers | | | | | |

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DIAMOND DRILL RECORD

WINDFALL OILS & MINES LTD.

HOLE NO. 80 - 2 SHEET NO. 3

LATITUDE _____ DATUM _____ STARTED _____
 DEPARTURE _____ BEARING _____ COMPLETED _____
 ELEVATION _____ DIP _____ ULTIMATE DEPTH _____

| DEPTH FEET | FORMATION | SAMPLE NO. | FROM | TO | WIDTH | OZS. Au |
|---------------|--|------------|------|----|-------|---------|
| 504.5 - 508.5 | Andesitic pillow lava, 1% PY, 1% PO along pillow rims. Two 1/8" wiggly QTZ vienlets. | 762 | | | 4.0' | Tr |
| 510.0 - 513.4 | Andesitic pillow lava, 2% PO, 1% PY, along pillow rims | 763 | | | 3.4' | Tr |
| 521.5 - 522.5 | Andesitic pillow lava with 1% PY, 1% PO trace of chalco along pillow rim | 764 | | | 1.0' | Tr |
| 524.8 - 527.4 | Andesitic pillow lava 1% PY, 1% PO and a 1/4" QTZ vienlet along the pillow rim | 765 | | | 2.6' | Tr |
| 540.2 - 541.1 | Andesitic pillow lava, 2% PY, 1% PO and a 1/8" wiggly QTZ stringer | 766 | | | 0.9' | Tr |
| 541.0 - 580.0 | QTZ-por'y, greyish to waxy in sheared sections carries 5 - 10% QTZ pheno-crysts up to 6mm in diam., some sericitic sections carry some dissem. PY mineralization and minor ZNS and chalco PY. The contact at 541.0 is irregular tongued. | | | | | |
| 549.0 - 550.1 | QTZ-por'y sericitic, 1% PY traces of ZNS | 767 | | | 1.1' | Tr |
| 554.4 - 556.5 | QTZ-por'y, sericitic, 2% dissem. PY, minor ZNS | 768 | | | 2.1' | Tr' |
| 560.3 - 561.5 | QTZ-por'y, strongly sheared, a possible fault | | | | | |

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DIAMOND DRILL RECORD

WINDFALL OILS & MINES LTD.

HOLE NO. 80 - 2. SHEET NO. 4

LATITUDE _____ DATUM _____ STARTED _____
 DEPARTURE _____ BEARING _____ COMPLETED _____
 ELEVATION _____ DIP _____ ULTIMATE DEPTH _____

| DEPTH FEET | FORMATION | SAMPLE NO. | FROM | TO | WIDTH | OZS. Au |
|---------------|---|------------|------|----|-------|---------|
| | zone , 1% PY | 769 | | | 1.2' | Tr |
| 564.9 - 565.7 | QTZ-por'y, sericitic, 2% Dissem. PY, with a streak of chalco and streaks of ZNS | 770 | | | 0.8' | Tr |
| 574.4 - 576.0 | QTZ-por'y, sericitic, 1% PY, hair-line streaks' of ZNS | 771 | | | 1.6' | Tr |
| 577.6 - 579.8 | QTZ-por'y, a 1/2" QTZ vienlet with some minor PY and PO, some streaks of ZNS | 772 | | | 2.2' | Tr |
| 580.0 - 624.0 | Grano'd, greyish, fine to med. grained, quite barren with fractures being rare. | | | | | |
| 589.1 - 589.7 | Grano'd, a 1/2" QTZ filled fracture at 60 degrees to core, minor PY | 773 | | | 0.6' | Tr |
| 619.5 - 620.1 | Grano'd, Two 1/4" QTZ filled fractures. 1/2% PY | 781 | | | 0.6' | Tr |
| 622.0 - 623.4 | Grano'd, Two 1/2" QTZ vienlets, wth 20% QTZ-carb alt'n, 2% PY | 782 | | | 0.4' | Tr |
| 623.4 - 630.3 | Andesite, greenish, with numerous calcitic amygdule-like flecks | | | | | |
| 629.5 - 630.3 | Andesite, minor QTZ-carb alt'n. 2% PY | 783 | | | 0.8' | Tr |
| 630.3 - 645.0 | Grano'd, greenish grey, med. grained, generally massive | | | | | |
| 635.5 - 636.8 | Grano'd, two 1/4" QTZ stringers, one is pinkish hematitic. 1% PY | 784 | | | 1.3' | Tr |

WINDFALL OILS & MINES LTD.

SIGNED *[Signature]*

DIAMOND DRILL RECORD

WINDFALL OILS & MINES LTD.

HOLE NO. 80 - 2 SHEET NO. 5

LATITUDE _____ DATUM _____ STARTED _____
 DEPARTURE _____ BEARING _____ COMPLETED _____
 ELEVATION _____ DIP _____ ULTIMATE DEPTH _____

| DEPTH FEET | FORMATION | SAMPLE NO. | FROM | TO | WIDTH | OZ Au |
|---------------|---|------------|------|----|-------|-------|
| 645.0 - 660.5 | QTZ-por'y dyke, waxy sericitic with numerous QTZ pheno's, 1mm in diam. | | | | | |
| 659.3 - 660.5 | QTZ-por'y, 10% QTZ-carb, 1% PY | 785 | | | 1.2' | Tr |
| 660.5 - 685.0 | Grano'd, greyish, fine to med. grained, mass- ive looks barren | | | | | |
| 685.0 - 697.3 | Waxy QTZ-por'y, sericitic, 5% QTZ pheno's up to 2mm in diam. | | | | | |
| 687.0 - 689.3 | QTZ-por'y, wiggly 1/2" QTZ stringer running along the core, carries minor PY | 794 | | | 2.3' | Tr |
| 695.5 - 697.0 | QTZ-por'y, a/12" wiggly QTZ stringer follows the core, minor PY | 795 | | | 1.5' | Tr |
| 697.0 - 698.5 | Grano'd, three 1/8" QTZ filled fractures at 55 degrees to core, 1/2% PY | 796 | | | 1.5' | Tr |
| 698.5 - 699.1 | Grano'd, a 1" irregular QTZ vienlet, carries 2% PY | 797 | | | 0.6' | Tr |
| 705.5 - 708.9 | Grano'd, weak QTZ-carb alt'n, minor PY | 798 | | | 3.4' | Tr |
| 711.5 - 714.7 | Grano'd, four 1/8" QTZ vienlets, 1/2% PY | 799 | | | 3.2' | Tr |
| 715.0 - 717.2 | Grano'd, a 1" and two 1/4" QTZ vienlets, minor | 800 | | | 2.2' | Tr |

PY
 DRILLED BY *Kenneth P. ...*

SIGNED *BJK*

DIAMOND DRILL RECORD

WINDFALL OILS & MINES LTD.

HOLE NO. 80 - 2 SHEET NO. 6

LATITUDE _____ DATUM _____ STARTED _____
 DEPARTURE _____ BEARING _____ COMPLETED _____
 ELEVATION _____ DIP _____ ULTIMATE DEPTH _____

| DEPTH FEET | FORMATION | SAMPLE NO | FROM | TO | WIDTH | OZS Au |
|---------------|---|-----------|------|----|-------|--------|
| 728.4 - 729.4 | Grano'd, three 1/8" QTZ vienlets, minor PY | 801 | | | 1.0' | Tr |
| 697.0 - 778.0 | Grano'd, greyish, med grained, some poorly developed QTZ filled fractures at 55 degrees to core, minor PY | | | | | |
| 729.5 - 732.0 | Grano'd, four 1/4" QTZ filled fractures with dissem. PY along the borders of the QTZ fractures. | 802 | | | 2.5' | Tr |
| 734.5 - 737.0 | Grano'd, three 1/8" QTZ filled fractures with dissem. PY along edges of the vienlets which run a 55 degrees to core | 803 | | | 2.5' | Tr |
| 737.0 - 739.0 | Grano'd, four 1/8" QTZ filled fractures with dissem. PY along the vienlets | 804 | | | 2.0' | Tr |
| 744.0 - 746.2 | Grano'd, four 1/8" QTZ filled fractures with dissm. PY along the fractures | 805 | | | 2.2' | Tr |
| 746.2 - 748.5 | Grano'd, a 1/4" and three 1/8" QTZ filled fractures with dissem. PY | 806 | | | 2.3' | Tr |
| 752.0 - 754.3 | Grano'd, coarse grained, two 1/8" QTZ vienlets minor reddish flecks of hematitic alt'n that resembles ZNS | 807 | | | 2.3' | Tr |
| 754.3 - 757.0 | Grano'd, coarse grained slightly silicified, | 808 | | | 2.7' | Tr |

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Handwritten initials

DIAMOND DRILL RECORD

WINDFALL OILS & MINES LTD.

HOLE NO. 80 - 2 SHEET NO. 7

LATITUDE _____ DATUM _____ STARTED _____
 DEPARTURE _____ BEARING _____ COMPLETED _____
 ELEVATION _____ DIP _____ ULTIMATE DEPTH _____

| DEPTH FEET | FORMATION | SAMPLE NO. | FROM | TO | WIDTH | OZS Au |
|---------------|--|------------|------|----|-------|--------|
| | with 1/2% PY and reddish hematitic flecks | | | | | |
| 757.0 - 759.0 | Grano'd, coarse grained, slightly silicified, 1/4% PY, some fine hematitic flecks in slightly silicified areas | 809 | | | 2.0' | Tr |
| 759.0 - 762.0 | Grano'd, slightly silicified 1/2% PY, 1/4% hematitic flecks of jasper | 810 | | | 3.0' | Tr |
| 762.0 - 765.5 | Grano'd, coarse grained, 1/2% PY, a few fine specks of jasper | 811 | | | 3.5' | Tr |
| 765.5 - 769.0 | Grano'd, coarse grained, slight silicification, 1/4% PY | 812 | | | 3.5' | Tr |
| 778.0 - 779.8 | QTZ-por'y dyke with 10% large pheno-crysts of QTZ up to 6mm in diameter | | | | | |
| 779.8 - 847.5 | Grano'd, coarse grained, greyish, some poorly developed QTZ filled fractures at 55 degrees to 65 degrees to core each carrying minor dissem PY | | | | | |
| 772.5 - 773.8 | Grano'd, two 1/4" QTZ vienlets, minor PY | 851 | | | 1.3' | Tr |
| 774.9 - 778.0 | Grano'd, a 1/2" QTZ vienlet, minor PY | 852 | | | 3.1' | Tr |
| 779.4 - 781.3 | Grano'd, three 1/8" QTZ vinelets, 1/2% PY | 853 | | | 1.9' | Tr |

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DIAMOND DRILL RECORD

WINDFALL OILS & MINES LTD.

HOLE NO. 80 - 2 SHEET NO. 8

LATITUDE _____ DATUM _____ STARTED _____
 DEPARTURE _____ BEARING _____ COMPLETED _____
 ELEVATION _____ DIP _____ ULTIMATE DEPTH _____

| DEPTH FEET | FORMATION | SAMPLE NO. | FROM | TO | WIDTH | OZS Au |
|---------------|---|------------|------|----|-------|--------|
| 783.5 - 787.0 | Grano'd, four 1/4" QTZ vienlets, minor PY | 854 | | | 3.5' | Tr |
| 788.0 - 789.3 | Coarse grano'd, four 1/8" QTZ vienlets, 1/2%PY | 901 | | | 1.3' | Tr |
| 789.3 - 790.4 | Grano'd, three 1/2" QTZ vienlets at 60 degrees tocore, 1% PY | 902 | | | 1.4' | Tr |
| 790.4 - 793.0 | Coarse grano'd, for 1/8" QTZ vienlets, minorPY | 903 | | | 2.6' | Tr |
| 793.0 - 794.6 | Grano'd, three 1/2" QTZ vienlets, minor PY | 904 | | | 1.6' | Tr |
| 794.6 - 795.9 | Grano'd, minor QTZ, minor PY | 905 | | | 1.3' | Tr |
| 795.9 - 797.0 | Grano'd, a 1/2" QTZ vienlets with some fault breccia, 3% PY | 906 | | | 1.1' | Tr |
| 797.0 - 799.2 | Grano'd, minorQTZ, minor PY | 907 | | | 2.2' | Tr |
| 799.2 - 802.0 | Grano'd, a 1" and three 1/4" QTZ vienlets some pink QTZ-carb. 2% dissem PY | 908 | | | 2.8' | Tr |
| 802.0 - 804.0 | Grano'd, two 1/2" QTZ vienlets with PY along edges | 909 | | | 2.0' | Tr |
| 804.0 - 806.0 | Grano'd, three 1/2" QTZ vienlets, 1/2% PY | 910 | | | 2.0' | Tr |
| 806.0 - 808.0 | Grano'd, one 1/2" and three 1/4" QTZ vienlet 1/2% PY | 911 | | | 1.5' | Tr |
| 808.0 - 809.5 | Grano'd, 20% QTZ in vienlets, some vienlets carry chlorite, 1% PY | 912 | | | 1.5' | Tr |
| 809.5 - 811.0 | Grano'd, a 2" and three 1/2" glassy QTZ vienlets, one with massive chlorite, 1/2% py | 913 | | | 1.5' | Tr |

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DIAMOND DRILL RECORD WINDFALL OILS & MINES LTD.

HOLE NO. 80 - 2 SHEET NO. 9

LATITUDE _____ DATUM _____ STARTED _____
 DEPARTURE _____ BEARING _____ COMPLETED _____
 ELEVATION _____ DIP _____ ULTIMATE DEPTH _____

| DEPTH FEET | FORMATION | SAMPLE NO. | FROM | TO | WIDTH | OZ% Au |
|---------------|--|------------|------|----|-------|--------|
| 811.0 - 812.0 | Grano'd, 15% QTZ in vienlets, 1% PY | 914 | | | 1.0' | Tr |
| 812.0 - 814.0 | Grano'd, 15% QTZ in stringers, 1% dissem. PY | 915 | | | 2.0' | Tr |
| 814.0 - 816.0 | Grano'd, 5% QTZ in stringers, 1/2% PY | 916 | | | 2.0' | Tr |
| 816.0 - 817.3 | Grano'd, a 1/2" glassy QTZ vienlet, minor PY | 917 | | | 1.3' | Tr |
| | three parallel fault zones run at 50 degrees to core | | | | | |
| 817.3 - 820.0 | Grano'd, 10% QTZ in vienlets, 3% dissem. PY | 918 | | | 2.7' | Tr |
| 820.0 - 822.0 | Grano'd, 5% QTZ in vienlets, minor PY, one vien has a streak of massive chlorite | 919 | | | 2.0' | Tr |
| 822.0 - 824.0 | Grano'd, two 1/4" QTZ vienlets, 1% PY | 920 | | | 2.0' | Tr |
| 824.0 - 825.5 | Grano'd, three 1/8" QTZ vienlets, 1% PY | 921 | | | 1.5' | Tr |
| 825.5 - 827.0 | Grano'd, two 1/2" and four 1/4" QTZ vienlets, 4% PY | 922 | | | 1.5' | Tr |
| 827.0 - 828.0 | Grano'd, four 1/4" QTZ vienlets at 55 degrees to core, 2% PY, some massive chlorite in viens | 953 | | | 1.0' | Tr. |
| 828.0 - 829.0 | Grano'd, 25% glassy QTZ in fractures, 1/2% PY | 954 | | | 1.0' | Tr. |
| 829.0 - 831.1 | Grano'd, 15% QTZ in fractures, some weak QTZ-carb. alt'n, 1/2% PY | 955 | | | 2.1' | Tr. |
| 831.1 - 833.1 | Grano'd, minor QTZ, minor PY | 956 | | | 2.0' | Tr. |
| 833.1 - 835.1 | Grano'd, strong QTZ-carb. alt'n, some pink hematitic staining, 1/2% PY | 957 | | | 2.0' | Tr. |

L. Windfall Drilling Co.

6/11

DIAMOND DRILL RECORD

WINDFALL OILS & MINES LTD.

HOLE NO. 80 - 2 SHEET NO. 10

LATITUDE _____ DATUM _____ STARTED _____
 DEPARTURE _____ BEARING _____ COMPLETED _____
 ELEVATION _____ DIP _____ ULTIMATE DEPTH _____

| DEPTH FEET | FORMATION | SAMPLE NO. | FROM | TO | WIDTH | OZS Au |
|---------------|---|------------|------|----|-------|--------|
| 835.1 - 837.5 | Grano'd, 5% QTZ in fractures, one with massive chlorite, 2% dissem. PY | 958 | | | 2.4' | Tr. |
| 837.5 - 839.0 | Grano'd, one 2" QTZ vienlets with several 1/4" vienlets which carry 2% PY and streaks of massive chlorite | 959 | | | 1.5' | Tr. |
| 839.0 - 841.0 | Grano'd, 10% QTZ in fractures, 1% PY | 960 | | | 2.0' | Tr. |
| 841.0 - 843.0 | Grano'd, 20% QTZ in fractures and silicification, 5% dissem. PY | 961 | | | 2.0' | Tr. |
| 843.0 - 846.0 | Grano'd, 5% QTZ in fractures, 1% PY | 962 | | | 3.0' | Tr. |
| 846.0 - 848.0 | Grano'd, coarse grained, a 1" and a 1/4" QTZ vienlet, 1% PY, fault at 848.0' | 1052 | | | 2.0' | Tr. |
| 848.6 - 849.1 | Grano'd, fine grained, a 1/2" QTZ vien at 60 degrees to core, with heavy PY | 1053 | | | 0.5' | Tr. |
| 849.1 - 852.0 | Grano'd, fine grained, some narrow fractures with coarse PY | 1054 | | | 2.9' | Tr. |
| 858.8 - 860.3 | Grano'd, two 1/4" QTZ vienlets, 2% PY | 1055 | | | 1.5' | Tr. |
| 866.5 - 867.0 | Grano'd, a 1/4" QTZ vienlet with heavy PY | 1056 | | | 0.5' | Tr. |
| 880.5 - 881.5 | Grano'd, two 1/4" QTZ vienlets, minor PY | 1057 | | | 1.0' | Tr. |
| 892.8 - 893.3 | Grano'd, a 1/4" vien (QTZ) with coarse PY | 1058 | | | 0.5' | Tr. |
| 897.3 - 898.0 | Grano'd, two 1/8" QTZ stringers, 1% PY | 1059 | | | 0.7' | Tr. |
| 900.0 - 902.0 | Grano'd, fine greyish, three 1/4" QTZ vienlets, 1/2% PY | 1060 | | | 2.0' | Tr. |

DRILLED BY *[Signature]*

[Signature]

DIAMOND DRILL RECORD

WINDFALL OILS & MINES LTD.

HOLE NO. 80 - 2 SHEET NO. 11

LATITUDE _____ DATUM _____ STARTED _____
 DEPARTURE _____ BEARING _____ COMPLETED _____
 ELEVATION _____ DIP _____ ULTIMATE DEPTH _____

| DEPTH FEET | FORMATION | SAMPLE NO. | FROM | TO | WIDTH | OZS Au |
|---------------|--|------------|------|----|-------|--------|
| 847.5 - 852.0 | Gran'd, dark greyish, fine grained | | | | | |
| 847.5 - 848.5 | Lamprophyre dyke, contacts at 60 degrees to core | | | | | |
| 848.5 - 920.0 | Gran'd, dark greyish, fine grained, very poorly developed fracturing | | | | | |
| 920.0 - 973.0 | Andesitic tuff to dacitic tuff, greyish to greenish grey, finely banded at 40 degrees to core. It contains some QTZ carb. Amygdule-like flecks | | | | | |
| 973.0 - 988.0 | Gabbro Dark greenish, med. grained, flecked with 5% fine magnetite | | | | | |
| 927.0 - 927.6 | Tuff with a 1/4" QTZ filled fracture and a 1/8" streak of massive PY | 1061 | | | 0.6' | Tr. |
| 948.4 - 950.7 | Tuff, weak QTZ-carb, alt'n, 2% dissem. PY | 1062 | | | 2.3' | Tr. |
| | 988.0 END OF HOLE | | | | | |
| | | | | | | |
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| | | | | | | |

C. Kurylow

HOLE No. 80 - 2

| Footage | Dip | Bearing | Azim. | Footage | Horiz. | Vert. |
|---------|------|-----------|-------|------------|--------|-------|
| Collar | -62° | S -3° - W | | 0 - 100' | 47.0 | 88.3 |
| 200' | -58° | S - 4° E | 180° | 100 - 300' | 106.0 | 169.6 |
| 400' | -56° | S - 5° E | 179° | 300 - 500' | 111.8 | 165.8 |
| 600' | -48° | S - 6½° E | 177½° | 500 - 700' | 133.8 | 148.6 |

DIAMOND DRILL RECORD


WINDFALL OILS & MINES LTD.

HOLE NO. 80 - 3 SHEET NO. 1

LATITUDE 13208.81
 DEPARTURE 11162.67
 ELEVATION 9914.55

DATUM AxT Cow (stored in core at Windfall) STARTED Aug. 23, 1980
 BEARING N 84°34' E COMPLETED Aug. 27, 1980
 Collar - 69°29'
 DIP 200' - 57° Azim 69.5° ULTIMATE DEPTH 271.0

| DEPTH FEET' | FORMATION | SAMPLE NO | FROM | TO | WIDTH | 4 1/2" - 4 1/2" | |
|--------------|---|-----------|------|----|-------|-----------------|------------|
| 0 - 23.0 | Casing in overburden. | | | | | | WIDTH OZ'S |
| 23.0 - 197.0 | Grano'd. dark greyish, fine to med. grained, somewhat massive, very little fracturing developed. | | | | | | |
| 57.0-57.6 | Grano'd. A 1/2" QTZ. vienlet, minor PY. | 1437 | | | | .6 | .11 |
| 70.0-70.5 | Grano'd. A 1/2" QTZ. vienlet, minor PY. | 1438 | | | | .5 | .06 |
| 73.2-74.5 | Grano'd. A 1/2" QTZ. vienlet 4% coarse PY. | 1439 | | | | 1.3 | .12 |
| 74.5-76.4 | Grano'd. minor QTZ, Minor PY. | 1440 | | | | 1.9 | TR. |
| 76.4-77.5 | Grano'd. Three 1/8" QTZ. vienlets, 1% PY. | 1441 | | | | 1.1 | .03 |
| 82.2-83.3 | Grano'd. Three 1/8" QTZ, vienlets minor PY | 1442 | | | | 1.1 | .04 |
| 84.8-85.4 | Grano'd. A 1/2" QTZ, vienlet, minor PY. | 1443 | | | | .6 | TR. |
| 114.8-115.9 | Grano'd. A 1" QTZ, vien, at 50' to core, and a vienlet runs along the core that carries 3% PO. | 1444 | | | | 1.1 | TR. |
| 126.0-126.6 | Grano'd. 4" QTZ, vienlet, at 50' to core, looks barren. | 1445 | | | | .6 | TR. |
| 131.5-132.2 | Grano'd. A 1" QTZ. vien, looks barren. | 1446 | | | | .7 | TR. |
| 133.2-133.8 | Grano'd. A 1" QTZ. vien, with 5% PO. 1% PY in adjacent wall rock. | 1447 | | | | .6 | .07 |
| 140.0-140.5 | Grano'd. A 1/2" QTZ. vien minor PY. | 1448 | | | | .5 | TR. |
| 143.4-144.1 | Grano'd. A 3/4" and a 1/2" QTZ. vienlet at 50' to core, some strong wall rock Alt'n. Carries 3% PO and 1% PY. | 1449 | | | | .7 | .05 |

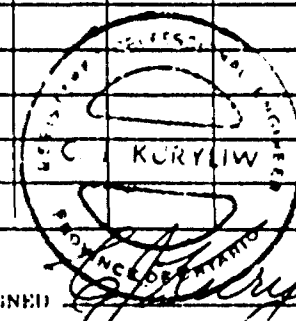

DRILLED BY Fortune D. Kelly, K. O. O.

SIGNED

[Signature]

DIAMOND DRILL RECORD

WINDFALL OILS & MINES LTD.

HOLE NO. 80 - 3 SHEET NO. 2

LATITUDE _____ DATUM _____ STARTED _____

DEPARTURE _____ BEARING _____ COMPLETED _____

ELEVATION _____ DIP _____ ULTIMATE DEPTH _____

| DEPTH FEET | FORMATION | SAMPLE NO. | FROM | TO | WIDTH | OZS Au |
|-------------|--|------------|------|----|-------|--------|
| 166.2-166.8 | Grano'd. A 1" QTZ. vien at 50' to core, carries two patches of fine VG. along a fracture $\frac{1}{2}$ " in the wall rock near the vien. | 1468 | | | .6 | .10 |
| 176.8-177.4 | Grano'd. A $\frac{1}{2}$ " QTZ. vien, minor PY. | 1469 | | | .6 | .06 |
| 181.0-181.5 | Grano'd. A 1" QTZ. vien 3% PY. | 1470 | | | .5 | Tr. |
| 183.8-184.4 | Grano'd. A $\frac{1}{2}$ " QTZ. vien 2% PY. | 1471 | | | .6 | Tr. |
| 186.5-187.0 | Grano'd. A $\frac{1}{2}$ " QTZ. vien, minor PY. | 1472 | | | .5 | Tr. |
| 188.0-188.8 | Grano'd. strong Q.C. Alt'n. A $\frac{1}{2}$ " QTZ. Carb. vienlet with 50% massive PY. Carries two specks of V.G. at 188.4' | 1473 | | | .8 | .34 |
| 192.3-194.7 | Grano'd. Strong Q.C. Alt'n. 10% coarse PY. | 1474 | | | 2.4 | .12 |
| 197.0-197.6 | Grano'd. A 2" QTZ. vien, minor PY. | 1475 | | | .6 | .03 |
| 208.0-210.0 | Tuff 10% QTZ. Carb. Alt'n 1% PY. | 1476 | | | 2.0 | Tr. |
| 240.0-242.0 | QTZ. Porphyry 5% PO. minor Q.C. Alt'n. | 1477 | | | 2.0 | Tr. |
| 197.0-204.0 | Gaburo, dark greenish, med, grained, partly sheared. | | | | | |
| 204.0-205.0 | Brownish Andesitic tuff. | | | | | |
| 205.0-208.0 | QTZ. Porphyry, waxy, sericitic, with 5%, 1 m.m. QTZ. pheros. | | | | | |
| 208.0-210.0 | Brownish finely banded tuff. banding runs along the core. | | | | | |

6/28

HOLE No. 80 - 3

| Footage | Dip | Bearing | Azim. | Footage | Horiz. | Vert. |
|---------|-------|------------|-------|-----------|--------|-------|
| Collar | | | | | | |
| Collar | -59½° | N - 74½° E | | 0-100 | 50.7 | 86.1 |
| 200' | -57° | N - 65½° E | 69½ | 100-271.0 | 3.1 | 143.4 |

DIAMOND DRILL RECORD

HOLE NO. 80-4

SHEET NUMBER 2

STARTED _____

LATITUDE _____

DATUM _____

COMPLETED _____

DEPARTURE _____

BEARING _____

ULTIMATE DEPTH _____

ELEVATION _____

DIP _____

| DEPTH FEET | FORMATION | SAMPLE NO. | | | Width | Ozs. Au | | | |
|------------|--|------------|------|----|-------|------------|--|--|--|
| | | | From | To | | | | | |
| 12.7-14.0 | Granodiorite, 40% Qtz in stringers, 2% coarse py, some tourmaline. | 8 | | | 1.3' | Trace | | | |
| 14.0-19.0 | Granodiorite, very minor Qtz, minor py | 9 | | | 5.0' | Tr | | | |
| 19.0-24.0 | Granodiorite, very minor Qtz, minor py | 10 | | | 4.0 | Tr. | | | |
| 23.0-24.5 | Granodiorite, four 1/4" Qtz, stringers, minor py | 11 | | | 1.5' | Tr. | | | |
| 24.5-28.5 | Granodiorite, three 1/4" Qtz veinlets, minor py | 12 | | | 4.0 | Tr. | | | |
| 28.5-31.0 | Granodiorite, coarser grained texture, seven 1/4" stringers, one 2" Qtz veinlets a few specs of coarse py. | 13 | | | 2.5' | Tr. | | | |
| 31.0-34.8 | Granodiorite, looks barren. | 14 | | | 3.8' | Tr. | | | |
| 34.8-37.3 | Granodiorite, fine 1/4" to 1/2" Qtz veinlets, some massive py blebs. | 15 | | | 2.5' | Tr. | | | |
| 37.8-40.2 | Granodiorite, traces Qtz, trace py | 16 | | | 2.9' | Tr. | | | |
| 40.2-43.0 | Granodiorite, traces Qtz, traces py | 17 | | | 2.8' | Tr. | | | |
| 43.0-46.0 | Granodiorite, two 1/4" Qtz stringers, minor py | 18 | | | 3.0' | Tr. | | | |
| 46.0-49.0 | Granodiorite, traces Qtz, traces py | 19 | | | 3.0 | .05 | | | |
| 49.0-51.2 | Granodiorite, two 1/4" Qtz veinlets, minor py | 20 | | | 2.2' | tr. | | | |
| 51.2-52.6 | Granodiorite, traces Qtz, traces py | 21 | | | 1.4' | tr. | | | |
| 52.6-54.3 | Granodiorite, two 1/4" Qtz stringers, minor coarse py. | 22 | | | 1.7' | tr. | | | |
| 54.3-57.8 | Granodiorite, traces Qtz, traces py | 23 | | | 3.5' | tr. | | | |

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DIAMOND DRILL RECORD WINDFALL OILS & MINES LTD.

HOLE NO. 80 - 4 SHEET NO. 2

LATITUDE _____ DATUM _____ STARTED _____
 DEPARTURE _____ BEARING _____ COMPLETED _____
 ELEVATION _____ DIP _____ ULTIMATE DEPTH _____

| DEPTH FEET | FORMATION | SAMPLE NO | FROM | TO | WIDTH | OZS Au |
|-------------|--|-----------|------|----|-------|--------|
| 12.7 - 14.0 | Granodiorite, 40% QTZ in stringers, 2 coarse PY, some tourmaline. | 8 | | | 1.3' | Trace |
| 14.0 - 19.0 | Granodiorite, very minor QTZ, minor PY. | 9 | | | 5.0' | tr |
| 19.0 - 24.0 | Granodiorite, very minor QTZ, minor PY. | 10 | | | 4.0' | tr |
| 23.0 - 24.5 | Granodiorite, four 1/4" QTZ stringers, minor PY. | 11 | | | 1.5' | tr |
| 24.5 - 28.5 | Granodiorite, three 1/4" QTZ vienlets, minor PY. | 12 | | | 4.0' | tr |
| 28.5 - 31.0 | Granodiorite, coarser grained texture, seven 1/4" stringers, one 2" QTZ vienlets a few specs of coarse PY. | 13 | | | 2.5' | tr |
| 31.0 - 34.8 | Granodiorite, looks barren. | 14 | | | 3.8' | tr |
| 34.8 - 37.3 | Granodiorite, fine 1/4" to 1/2" QTZ vienlets, some massive PY blebs. | 15 | | | 2.5' | tr |
| 37.8 - 40.2 | Granodiorite, traces QTZ, trace PY | 16 | | | 2.9' | tr |
| 40.2 - 43.0 | Granodiorite, traces QTZ, traces PY | 17 | | | 2.8' | tr |
| 43.0 - 46.0 | Granodiorite, two 1/4" QTZ stringers, minor PY | 18 | | | 3.0' | tr |
| 46.0 - 49.0 | Granodiorite, traces QTZ, traces PY | 19 | | | 3.0' | .05 |
| 49.0 - 51.2 | Granodiorite, two 1/2" QTZ vienlets, minor PY | 20 | | | 2.2' | tr |
| 51.2 - 52.6 | Granodiorite, traces QTZ, traces PY. | 21 | | | 1.4' | tr |
| 52.6 - 54.3 | Granodiorite, two 1/2" QTZ stringers, minor coarse PY. | 22 | | | 1.7' | tr |
| 54.3 - 57.8 | Granodiorite, traces QTZ, traces PY. | 23 | | | 3.5' | tr |

6/24

DIAMOND DRILL RECORD

 HOLE NO. 80-4

 SHEET NUMBER 3

STARTED _____

LATITUDE _____

DATUM _____

COMPLETED _____

DEPARTURE _____

BEARING _____

ULTIMATE DEPTH _____

ELEVATION _____

DIP _____

| DEPTH FEET | FORMATION | SAMPLE NO. | From | To | Width | Ozs. | | | |
|-------------|--|------------|------|----|-------|------|--|--|--|
| | | | | | | Au | | | |
| 57.8-62.0 | Grano'd fine $\frac{1}{2}$ " to $\frac{1}{2}$ " qtz veinlets, some massive py blebs. | 24 | | | 4.2' | tr. | | | |
| 62.0-66.0 | Grano'd, greyish, liiks barren | 25 | | | 4.0' | tr. | | | |
| 66.0-72.0 | Grano'd, greyish, looks barren | 26 | | | 6.0' | tr. | | | |
| 72.0-76.0 | Grano'd, greyish, fine to med. grained, no fracturing, minor qtz. | 27 | | | 4.0' | tr. | | | |
| 76.0-79.2 | Grano'd, minor qtz, carb. alt'n, minor py | 28 | | | 3.2' | Tr. | | | |
| 79.2-80.0 | Grano'd, some bleaching, 10% qtz in fractures, 2% py. | 29 | | | 0.8' | .02 | | | |
| 80.0-82.2 | Grano'd, 5% qtz in fractures, 1% po | 30 | | | 2.2' | .04 | | | |
| 82.2-83.2 | Grano'd greyish, looks barren | 31 | | | 1.0' | tr. | | | |
| 83.2-84.2 | Grano'd, 1" qtz filled fracture at 55 detrees to core axis, minor po. | 32 | | | 1.0' | .01 | | | |
| 84.2-88.2 | Grano'd, greyish, looks barren | 33 | | | 4.0' | .05 | | | |
| 88.2-89.0 | Grano'd, $\frac{1}{2}$ " qtz filled fracture at 50 degrees to core axis, minor py. | 34 | | | 0.8' | .01 | | | |
| 89.0-92.0 | Grano'd, greyish, looks barren. | 35 | | | 3.0' | tr. | | | |
| 92.0-96.8 | Grano'd, greyish, minor qtz, minor py | 36 | | | 4.8' | tr. | | | |
| 96.8-100.7 | Grano'd, greyish, looks barren | 37 | | | 3.9' | .01 | | | |
| 100.7-101.3 | Grano'd, 1" qtz filled fracture, minor py | 38 | | | 0.6' | .01 | | | |
| 101.3-104.9 | Grano'd, greyish, looks barren. | 39 | | | 3.6' | tr. | | | |

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WINDFALL OILS & MINES LTD.

HOLE NO. 80 - 4 SHEET NO. 3

LATITUDE _____ DATUM _____ STARTED _____
 DEPARTURE _____ BEARING _____ COMPLETED _____
 ELEVATION _____ DIP _____ ULTIMATE DEPTH _____

| DEPTH FEET | FORMATION | SAMPLE NO | FROM | TO | WIDTH | OZS Au |
|---------------|---|-----------|------|----|-------|--------|
| 57.8 - 62.0 | Grano'd, fine 1/4" to 1/2" QTZ vienlets, some massive PY blebs. | 24 | | | 4.2' | tr |
| 62.0 - 66.0 | Grano'd, greyish, looks barren | 25 | | | 4.0' | tr |
| 66.0 - 72.0 | Grano'd, greyish, looks barren | 26 | | | 6.0' | tr |
| 72.0 - 76.0 | Grano'd, greyish, fine to med. grained, no fracturing, minor QTZ. | 27 | | | 4.0' | tr |
| 76.0 - 79.2 | Grano'd, minor QTZ, carb. alt'n, minor PY. | 28 | | | 3.2' | tr |
| 79.2 - 80.0 | Grano'd, some bleaching, 10' PY in fractures, 2' PY. | 29 | | | 0.8' | .02 |
| 80.0 - 82.2 | Grano'd, 5' QTZ in fractures, 1' PO | 30 | | | 2.2' | .04 |
| 82.2 - 83.2 | Grano'd, greyish, looks barren | 31 | | | 1.0' | tr |
| 83.2 - 84.2 | Grano'd, 1" QTZ filled fracture at 45 degrees to core axis, minor PO. | 32 | | | 1.0' | .01 |
| 84.2 - 88.2 | Grano'd, greyish, looks barren | 33 | | | 4.0' | .05 |
| 88.2 - 89.0 | Grano'd, 1/2" QTZ filled fracture at 50 degrees to core axis, minor PY. | 34 | | | 0.8' | .01 |
| 89.0 - 92.0 | Grano'd, greyish, looks barren. | 35 | | | 3.0' | tr |
| 92.0 - 96.8 | Grano'd, greyish, minor S.S., minor PY | 36 | | | 4.8' | tr |
| 96.8 - 100.7 | Grano'd, greyish, looks barren | 37 | | | 3.9' | .01 |
| 100.7 - 101.3 | Grano'd, 1" QTZ filled fracture, minor PO | 38 | | | 0.6' | .01 |
| 101.3 - 104.0 | Grano'd, greyish, looks barren. | 39 | | | 3.6' | tr |

BOILED BY _____

SIGNED _____

CJK

DIAMOND DRILL RECORD

 HOLE NO. 80-4

 SHEET NUMBER 4

STARTED _____

LATITUDE _____

DATUM _____

COMPLETED _____

DEPARTURE _____

BEARING _____

ULTIMATE DEPTH _____

ELEVATION _____

DIP _____

| DEPTH FEET | FORMATION | SAMPLE NO. | | | Width | Ozs. Au | | | |
|-------------|---|------------|------|----|-------|------------|--|--|--|
| | | | From | To | | | | | |
| 104.9-108.6 | Grano'd, greyish, looks barren | 40 | | | 3.7' | tr. | | | |
| 108.6-109.4 | Grano'd, with two qtz filled fractures. owe 3/4" wide qtz, has 1" bleached silicified wall rock alt'n, mineralized with 2% po, 1/2% py, looks good. | 41 | | | 0.8' | tr. | | | |
| 109.4-111.4 | Grano'd, two ' qtz filled fracture, 1/2% po and minor py. | 42 | | | 2.0' | tr. | | | |
| 111.4-115.5 | Grano'd, greyish, med. grained, looks barren | 43 | | | 4.1 | tr. | | | |
| 115.5-116.0 | Grano'd 3" qtz filled fracture with 1/2" bleached greyish alt'n in wall rock, minor py | 55 | | | 1.0' | tr. | | | |
| 116.0-122.0 | Grano'd, greyish, looks barren | 56 | | | 6.0' | tr. | | | |
| 122.0-127.0 | Grano'k, greyish looks barren | 57 | | | 5.0' | tr. | | | |
| 127.0-128.1 | Grano'd, greyish, two 1/2" qtz veinlets at 50% degrees to core, minor py, po. | 58 | | | 1.1' | tr. | | | |
| 128.1-132.0 | Grano'd, greyish, med. grained, looks barren | 59 | | | 3.9' | tr. | | | |
| 132.0-136.7 | Grano'd, greyish, med grained, minor qtz, minor po. | 60 | | | 4.7' | tr. | | | |
| 136.7-139.0 | Grano'd, greyish med. grained, minor qtz minor py. | 61 | | | 2.3' | tr. | | | |
| 139.0-142.3 | Grano'd, greyish, looks barren | 62 | | | 3.3' | tr. | | | |
| 142.3-144.4 | Grano'd, greyish, 1/2" qtz veinlet at 142.6 with | | | | | | | | |

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DIAMOND DRILL RECORD

WINDFALL OILS & MINES LTD.

HOLE NO. 80 - 4 SHEET NO. 4

LATITUDE _____ DATUM _____ STARTED _____
 DEPARTURE _____ BEARING _____ COMPLETED _____
 ELEVATION _____ DIP _____ ULTIMATE DEPTH _____

| DEPTH FEET | FORMATION | SAMPLE NO. | FROM | TO | WIDTH | OZS Au |
|---------------|--|------------|------|----|-------|--------|
| 104.9 - 108.0 | Grano'd, greyish, looks barren | 40 | | | 3.7' | tr |
| 103.6 - 109.4 | Grano'd, with two QTZ filled fractures, cwe 3/4" wide QTZ, has 1" of bleached solidified wall rock alt'n, mineralized with 2% Cu, 1/2% PY, looks good. | 41 | | | 0.8' | tr |
| 109.4 - 111.4 | Grano'd, two 1/2" QTZ filled fracture, 1/2" H, and minor PY. | 42 | | | 2.0' | tr |
| 111.4 - 115.5 | Grano'd, greyish, med. grained, looks barren. | 43 | | | 4.1' | tr |
| 115.5 - 116.0 | Grano'd, 3" QTZ filled fracture with 1/2" bleached greenish alt'n in wall rock, minor PY. | 55 | | | 1.0' | tr |
| 116.0 - 122.0 | Grano'd, greyish, looks barren. | 56 | | | 6.0' | tr |
| 122.0 - 127.0 | Grano'd, greyish looks barren | 57 | | | 5.0' | tr |
| 127.2 - 128.1 | Grano'd, greyish, two 1/2" QTZ vienlets at 50% degrees to core, minor PY PO. | 58 | | | 1.1' | tr |
| 128.1 - 132.0 | Grano'd, greyish, med. grained, looks barren. | 59 | | | 3.9' | tr |
| 132.0 - 136.7 | Grano'd, greyish, med. grained, minor QTZ, minor PO. | 60 | | | 4.7' | tr |
| 136.7 - 139.0 | Grano'd, greyish med. grained, minor QTZ, minor PY | 61 | | | 2.3' | tr |
| 139.0 - 142.3 | Grano'd, greyish, looks barren | 62 | | | 3.3' | tr |
| 142.3 - 144.1 | Grano'd, greyish, 1/4" QT vienlet at 142.6 with | | | | | |

DRILLED BY *[Signature]*

SIGNED *[Signature]*

DIAMOND DRILL RECORD

 HOLE NO. 80-4

 SHEET NUMBER 5

STARTED _____

LATITUDE _____

DATUM _____

COMPLETED _____

DEPARTURE _____

BEARING _____

ULTIMATE DEPTH _____

ELEVATION _____

DIP _____

| DEPTH FEET | FORMATION | SAMPLE NO. | | | Width | Ozs. Au | | | |
|-------------|---|------------|------|----|-------|------------|--|--|--|
| | | | From | To | | | | | |
| 144.4-145.6 | 2" of wall rock alt'n carrying 2% po, 1/8 py Grano'd, greyish, two 1/2" qtz veinlets, at | 63 | | | 2.1' | tr. | | | |
| | | 64 | | | 1.2' | tr. | | | |
| | 144.6 2" of bleached wall rock alt'n carrying 2% po, 1/8 py. | | | | | | | | |
| 145.6-146.4 | Grano'd 2" qtz filled fractures at 50° to core axis, two inch of bleached wall rock alt'n with 2% po and 1/8 py. | 65 | | | 0.8' | .01 | | | |
| 146.4-148.0 | Grano'd, greyish, med. grained, looks barren | 66 | | | 1.6' | tr. | | | |
| 148.0-148.5 | Grano'd 1" qtz filled fracture with 1" bleached wall rock alt'n with 1% po and minor py. | 67 | | | 0.5' | tr. | | | |
| 148.5-150.1 | Grano'd, dark greyish, looks barren | 68 | | | 1.6' | tr. | | | |
| 150.0-151.2 | Grano'd, three 1/2" qtz filled fracture at 50° to core axis, strong bleached wall rock alt'n 3% po 1/8 py, looks good. | 69 | | | 1.1' | tr. | | | |
| 151.2-152.7 | Grano'd, dark greyish, looks barren | 70 | | | 1.5' | tr. | | | |
| 152.7-154.2 | Grano'd, dark greyish, two 1/2" qtz filled fractures 1/8 po minor py. | 71 | | | 1.5' | tr. | | | |
| 154.2-155.3 | Grano'd, dark greyish, looks barren | 72 | | | 1.1' | tr. | | | |
| 155.3-156.1 | Grano'd, two 1" qtz filled fractures at 50° to core axis, strong bleached to light green wall rock alt'n which consists largely of carb. and | 73 | | | 0.8' | tr. | | | |

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WINDFALL OILS & MINES LTD.

HOLE NO. 80 - 4 SHEET NO. 5

LATITUDE DATUM STARTED

DEPARTURE BEARING COMPLETED

ELEVATION DIP ULTIMATE DEPTH

| DEPTH FEET | FORMATION | SAMPLE NO | FROM | TO | WIDTH | OZS Au |
|---------------|--|-----------|------|----|-------|--------|
| | 2" of wall rock alt'n ca carrying 2% PO, 1/2% Py | 63 | | | 2.1' | tr |
| 144.4 - 145.6 | Grano'd, greyish, two 1/4" QZ filled v. fract., at 144.6 | 64 | | | 1.2' | tr |
| | 2" of bleached wall rock alt'n carrying 2% PO 1/2% Py. | | | | | |
| 145.6 - 146.4 | Grano'd, 2" QZ filled fracture at 50 degrees to core axis, two inch of bleached wall rock alt'n with 2% PO and 1/2% Py. | 65 | | | 0.8' | .01 |
| 146.4 - 147.0 | Grano'd, greyish, med. grained, looks barren. | 66 | | | 1.6' | tr |
| 148.0 - 148.5 | Grano'd, 1" QZ filled fracture with 1" bleached wall rock alt'n with 1% PO and minor Py. | 67 | | | 0.5' | tr |
| 148.5 - 150.1 | Grano'd, dark greyish, looks barren. | 68 | | | 1.6' | tr |
| 150.1 - 151.2 | Grano'd, three 1/2" QZ filled fracture at 50 de- grees to core axis, strong bleached wall rock alt'n 3% PO 1/2% Py. looks good. | 69 | | | 1.1' | tr |
| 151.2 - 152.7 | Grano'd, dark greyish, looks barren | 70 | | | 1.5' | tr |
| 152.7 - 154.2 | Grano'd, dark greyish, two 1/2" QZ filled fract- ures, 1/2" Py, barren. | 71 | | | 1.5' | tr |
| 154.2 - 155.3 | Grano'd, dark greyish, looks barren | 72 | | | 1.1' | tr |
| 155.3 - 156.1 | Grano'd, two 1" QZ filled fractures at 50 degrees to core axis, strong bleached to light green wall rock alt'n which consists largely of carb. and | 73 | | | 0.8' | tr |

DRILLED BY James J. Doolittle

SIGNED CDK

DIAMOND DRILL RECORD

HOLE NO. 80-4

SHEET NUMBER 6

STARTED _____

LATITUDE _____

DATUM _____

COMPLETED _____

DEPARTURE _____

BEARING _____

ULTIMATE DEPTH _____

ELEVATION _____

DIP _____

| DEPTH FEET | FORMATION | SAMPLE NO. | From | To | Width | Ozs. Au |
|-------------|---|------------|------|----|-------|------------|
| 156.1-157.0 | silica, 3% Po 1% py, looks good. | 74 | | | 0.9 | tr. |
| 157.0-158.0 | Grano'd, dark greyish, looks barren. | 75 | | | 1.0' | .05 |
| 158.0-159.3 | Grano'd, 2" qtz filled fracture, 50° to core bleached light greenish wall rock alt'n and secondary grey qtz stringers, 3% po in massive blebs, 1% py, looks good. | 76 | | | 1.3' | .04 |
| 159.3-165.0 | Grano'd, two 1/2" qtz filled fractures with heavy light green qtz, carb. wall rock alt'n 3% po 1/2% py, looks good. | 77 | | | 5.7' | tr |
| 165.0-166.7 | Grano'd, dark greyish, med. grained, minor qtz. | 78 | | | 1.7' | .01 |
| 166.7-167.9 | Grano'd, two 1" qtz veinlets at 50° to core, strong light green qtz. carb. wall rock alt'n 3% py in coarse blebs. looks good. | 79 | | | 1.2' | tr. |
| 167.9-169.0 | Grano'd, 2" qtz filled fracture with 4" of green qtz carb. wall rock alt'n 2% po, 1% py, looks good. | 80 | | | 1.1' | tr. |
| 169.0-169.8 | Grano'd, several narrow ??, stringers, 2% disseminated Py, some bleaching. | 81 | | | 0.8' | .01 |
| | Grano'd 1" carb. filled fracture with heavy green qtz carb. wall rock alt'n 3% coarse po in blebs, 1/2% py, looks good. | | | | | |

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WINDFALL OILS & MINES LTD.

HOLE NO. 20 - 4 SHEET NO. 6

LATITUDE _____ DATUM _____ STARTED _____
 DEPARTURE _____ BEARING _____ COMPLETED _____
 ELEVATION _____ DIP _____ ULTIMATE DEPTH _____

| DEPTH FEET | FORMATION | SAMPLE NO | FROM | TO | WIDTH | OZS Au |
|---------------|---|-----------|------|----|-------|--------|
| | silica. 3/4 PO 1" PY. looks good. | | | | | |
| 156.1 - 157.0 | Grano'd, dark greyish, looks brown. | 74 | | | 0.9 | tr |
| 157.0 - 158.0 | Grano'd 2" QTZ filled fractures, at 50' to 55' to core, bleached light green in wall rock alt'n and secondary grey MS at 50' to 55' in massive blebs, 1/2 PY. looks good. | 75 | | | 1.0' | .05 |
| 158.0 - 159.3 | Grano'd, two 1/4" QTZ filled fractures with heavy light green QTZ, carb. wall rock alt'n, 3" PO 1/2 PY. looks good. | 76 | | | 1.3' | .04 |
| 159.3 - 165.0 | Grano'd, dark greyish, med. stained, show MS. | 77 | | | 5.7' | tr |
| 165.0 - 166.7 | Grano'd, two 1" QTZ veinlets at 50' to 55' to core, strong light green MS. carb. wall rock alt'n 3" in coarse blebs. looks good. | 78 | | | 1.7' | .01 |
| 166.7 - 167.9 | Grano'd, 2" MS filled fracture with 4" of green QTZ Carb. wall rock alt'n 2-3" in coarse blebs. looks good. | 79 | | | 1.2' | tr |
| 167.9 - 169.0 | Grano'd, several narrow, small cores, 1/2 dis-simulated MS, some bleaching. | 80 | | | 1.1' | tr |
| 169.0 - 169.8 | Grano'd, 1/4" QTZ Carb. filled fracture with heavy green MS carb. wall rock alt'n 3" coarse PO in blebs, 1/2 PY. looks good. | 81 | | | 0.8' | .01 |

DRILLED BY K. H. H. H. H.

SIGNED C. J. K.

DIAMOND DRILL RECORD

 HOLE NO. 80-4

 SHEET NUMBER 7

STARTED _____

LATITUDE _____

DATUM _____

COMPLETED _____

DEPARTURE _____

BEARING _____

ULTIMATE DEPTH _____

ELEVATION _____

DIP _____

| DEPTH FEET | FORMATION | SAMPLE NO. | From | To | Width | Ozs. Au | | | |
|-------------|---|------------|------|----|-------|------------|--|--|--|
| | | | | | | | | | |
| 169.8-170.5 | Grano'd, greyish 1/2" qtz veinlet with 1% coarse po | 82 | | | 0.7' | .01 | | | |
| 170.5-171.8 | Grano'd, greyish, looks barren | 83 | | | 1.3' | tr. | | | |
| 171.8-172.7 | Grano'd, 2" qtz veinlet in fracture, strong light green qtz carb. wall rock alt'n, 1% po 1/2% py. | 84 | | | 0.9' | tr. | | | |
| 172.7-173.7 | Grano'd, three 1/2" qtz veinlets at 65° to core strong light green qtz carb. wall rock alt'n 3% coarse po, 3% coarse py blebs, looks good | 85 | | | 1.0' | .01 | | | |
| 173.7-174.7 | Grano'd, 80% qtz vein containing carb. light green qtz carb. wall rock alt'n coarse blebs of py and po, looks good. | 86 | | | 1.0' | tr. | | | |
| 174.7-175.7 | Grano'd, greyish, 1/2" qtz veinlet at 50° to core. Light green bleached wall rock carries 2% coarse py. | 87 | | | 1.0' | .02 | | | |
| 175.7-179.2 | Grano'd dark greyish, looks barren | 88 | | | 3.5' | tr. | | | |
| 179.2-179.8 | Grano'd 30% qtz 1/2% py 1/2% po | 89 | | | 0.6' | tr | | | |
| 179.8-181.1 | Grano'd, dark greenish, looks barren | 90 | | | 1.3' | tr. | | | |
| 181.1-183.1 | Grano'd, two 1/2" qtz veinlets at 50° to core Light bleached alt'n throughout. 1% py minor po | 91 | | | 2.0' | .02 | | | |
| 183.1-184.1 | Grano'd two 1/2" qtz veinlets, strong light greenish qtz carb. wall rock alt'n 3% blebs po, 2% | | | | | | | | |

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TO FOLLOW**

DIAMOND DRILL RECORD

WINDFALL OILS & MINES LTD.

HOLE NO. 80 - 4 SHEET NO. 7

LATITUDE _____ DATUM _____ STARTED _____
 DEPARTURE _____ BEARING _____ COMPLETED _____
 ELEVATION _____ DIP _____ ULTIMATE DEPTH _____

| DEPTH FEET | FORMATION | SAMPLE NO | FROM | TO | WIDTH | OZS Au |
|---------------|---|-----------|------|----|-------|--------|
| 169.5 - 170.5 | Grano'd, greyish 1/2" QTZ violet with 1% coarse PO | 82 | | | 0.7' | .01 |
| 170.5 - 171.8 | Grano'd, greyish, looks barren | 83 | | | 1.3' | tr |
| 171.8 - 172.7 | Grano'd, 2" QTZ violet in fracture, strong light green QTZ Carb. wall rock alt'n, 1% PO 1/4% PY. | 84 | | | 0.9' | tr |
| 172.7 - 173.7 | Grano'd, three 1/2" QTZ vienlets at 65 degrees to core, strong light green PY Carb. wall rock alt'n 3% coarse IO, 3% coarse black, looks good | 85 | | | 1.0' | .01 |
| 173.7 - 174.7 | Grano'd, 80% QTZ vien containing carbonate light green QTZ Carb. wall rock alt'n coarse blebs of PY and IO, looks good. | 86 | | | 1.0' | tr |
| 174.7 - 175.7 | Grano'd, greyish, 1/2" 1% violet at 50 degrees to core. Light green bleached wall rock carries 2% coarse PY | 87 | | | 1.0' | .02 |
| 175.7 - 179.2 | Grano'd, dark greyish, looks barren | 88 | | | 3.5' | tr |
| 179.2 - 179.8 | Grano'd, 30% 1/2" PY 1/4% | 89 | | | 0.6' | tr |
| 179.8 - 181.1 | Grano'd, dark greyish, looks barren | 90 | | | 1.3' | tr |
| 181.1 - 183.1 | Grano'd, two 1/2" QTZ vienlets at 50 degrees to core, Light bleached alt'n throughout, 1% PY minor PO. | 91 | | | 2.0' | .02 |
| 183.1 - 184.1 | Grano'd, two 1/2" QTZ vienlets, strong light greenish QTZ Carb. wall rock alt'n 3% blebs PO, 2% | | | | | |

DRILLED BY W. J. ...

SIGNED CAF

DIAMOND DRILL RECORD

HOLE NO. 80-4

SHEET NUMBER 8

STARTED _____

LATITUDE _____

DATUM _____

COMPLETED _____

DEPARTURE _____

BEARING _____

ULTIMATE DEPTH _____

ELEVATION _____

DIP _____

| DEPTH FEET | FORMATION | SAMPLE NO. | From | To | Width | Ozs. Au | |
|-------------|--|------------|------|----|--------------|--------------------------|-----|
| 184.1-184.7 | blebs py, looks good. Grano'd, with a 4? white qtz veinlet that carries a 10% py blebs one is 3/4" in diameter at 184.3, there are several fine specs of V.G. This is a good looking structure. | 92 93 | | | 1.0' 0.6' | .04 .47 .45 .52 | .48 |
| 184.7-185.4 | Grano'd, some gr. qtz carb. wall rock alt'n 2% po 1% py. | 94 | | | 0.7' | .01 | |
| 185.4-187.0 | Grano'd dk, greyish, looks barren | 95 | | | 1.6' | tr. | |
| 187.0-187.6 | Grano'd, 2" qtz veinlet at 50° to core axis. 1% py. | 96 | | | 0.6' | .01 | |
| 187.6-189.2 | Grano'd, dk, greyish, looks barren | 97 | | | 1.6' | tr. | |
| NOTE. | <p>142.1-187.6 the granodiorite is mineralized with alternating bands of dark grey barren looking grano'd with series of qtz filled fracture veins, carrying strong light green qtz carb. wall rock alt'n that carries blebs of po and py. mineralization and also carries V.G. recognized at 184.3</p> <p>Note: This seems to be a structural grouping over core length of 45.4'.</p> | | | | | | |

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DIAMOND DRILL RECORD

WINDFALL OILS & MINES LTD.

HOLE NO. 80 - 4 SHEET NO. 8

LATITUDE _____ DATUM _____ STARTED _____
 DEPARTURE _____ BEARING _____ COMPLETED _____
 ELEVATION _____ DIP _____ ULTIMATE DEPTH _____

| DEPTH FEET | FORMATION | SAMPLE NO. | FROM | TO | WIDTH | OZS. Au | |
|---------------|---|------------|------|----|-------|---------|-----|
| | blebs PY, looks good. | 92 | | | 1.0' | .04 | |
| 184.1 - 184.7 | Grano'd, with a 4Y white QFZ violet that carries a 10% PY blebs one is 3/4" in diameter at 184.3, there are several fine specs of V.G. this is a good looking structure. | 93 | | | 0.6 | .47 | .48 |
| | | | | | | .45 | |
| | | | | | | .52 | |
| 184.7 - 185.4 | Grano'd, some gr. 2% QFZ, well rock alt'n, 15 PY. | 94 | | | 0.7' | .01 | |
| 185.4 - 187.0 | Grano'd, dk. greyish, looks barren | 95 | | | 1.6' | tr | |
| 187.0 - 187.6 | Grano'd, 2" QFZ violet at 50 degrees to core axis, 15 PY | 96 | | | 0.6' | .01 | |
| 187.6 - 189.2 | Grano'd, dk. greyish, looks barren | 97 | | | 1.6' | tr | |
| Note | 142.1 - 187.6 The Granodiorite is mineralized with alternating bands of dark grey barren looking grano'd with series of Pb filled fracture veins, carrying strong light green Pb carb. All rock alt'n that carries blebs of PY and PY. Mineralization and also carries V.G. recognized at 184.3 | | | | | | |
| | Notes: This seems to be a structural grouping over core length of 45.4'. | | | | | | |

DRILLED BY James D. Blumley Co.

SIGNED [Signature]

DIAMOND DRILL RECORD

HOLE NO. 80-4

SHEET NUMBER 9

STARTED _____

LATITUDE _____

DATUM _____

COMPLETED _____

DEPARTURE _____

BEARING _____

ULTIMATE DEPTH _____

ELEVATION _____

DIP _____

| DEPTH FEET | FORMATION | SAMPLE NO. | | | Width | Ozs. Au | | | |
|-------------|---|------------|------|----|-------|------------|--|--|--|
| | | | From | To | | | | | |
| 189.2-192.0 | Grano'd, greyish, minor qtz minor Py | 98 | | | 2.8' | tr | | | |
| 192.0-192.5 | Grano'd, 1" qtz veinlet along fracture, minor wall rock alt'n 1% Po, 1/2% Py | 99 | | | 0.5' | tr | | | |
| 192.5-196.8 | Grano'd dark greyish, med. grained, looks barren | 100 | | | 4.3' | tr | | | |
| 196.8-197.4 | Grano'd, 1" qtz vein at 55° to core axis minor py, minor po | 101 | | | 0.6' | tr | | | |
| 197.4-200.1 | Grano'd, greyish looks barren | 102 | | | 2.7' | tr | | | |
| 200.1-201.0 | Grano'd, two 1/2" qtz stringers 1% py streak | 103 | | | 0.9' | .02 | | | |
| 201.0-207.2 | Grano'd, dk. greyish, med. grained looks barren | 104 | | | 6.2' | tr | | | |
| 207.2-208.5 | Grano'd, 1/2" and 1" qtz filled fracture, minor py minor po | 105 | | | 1.3' | tr | | | |
| 208.5-210.0 | Grano'd dk. greyish, looks barren | 106 | | | 1.5' | tr | | | |
| 210.0-210.7 | Grano'd, strong lt. greenish qtz carb.alt'n 1/2" qtz vein filled with 3/4" massive py, looks good. | 107 | | | 0.7' | .03 | | | |
| 210.7-212.6 | Grano'd, dark greyish 1/2" qtz veinlet minor py | 108 | | | 1.9' | tr. | | | |
| 212.6-216.0 | Andesite, possibly antisictic? tuff contacts with grano'd are sharp at 40° to core axis. minor qtz and po | 109 | | | 3.4' | tr | | | |
| 216.0-216.5 | Contact zone between Grano'd and tuff carries a 1/2" qtz vein and 3% py and po. | 110 | | | 0.5' | .03 | | | |

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DIAMOND DRILL RECORD

WINDFALL OILS & MINES LTD.

HOLE NO. BQ - 4 SHEET NO. 9

LATITUDE _____ DATUM _____ STARTED _____
 DEPARTURE _____ BEARING _____ COMPLETED _____
 ELEVATION _____ DIP _____ ULTIMATE DEPTH _____

| DEPTH FEET | FORMATION | SAMPLE NO. | FROM | TO | WIDTH | OZS. Au |
|---------------|--|------------|------|----|-------|---------|
| 189.2 - 192.0 | Grano'd, greyish, minor QTZ, minor PY | 98 | | | 2.8' | tr |
| 192.0 - 192.5 | Grano'd, 1" QTZ vienlet along fracture, minor wall rock alt'n 1% PO, 1/2% PY | 99 | | | 0.5' | tr |
| 192.5 - 196.8 | Grano'd dark greyish, med. grained, looks barren | 100 | | | 4.3' | tr |
| 196.8 - 197.4 | Grano'd, 1" QTZ vien at 55 degrees to core axis minor PY, minor PO | 101 | | | 0.6' | tr |
| 197.4 - 200.1 | Grano'd, greyish, looks barren | 102 | | | 2.7' | tr |
| 200.1 - 201.0 | Grano'd, two 1/4" QZ filled cracks 1% PY alt'n | 103 | | | 0.9' | .02 |
| 201.0 - 207.2 | grano'd, dk. greyish, med. grained looks barren | 104 | | | 6.2' | tr |
| 207.2 - 208.5 | Grano'd, 1/2" and 1" QZ filled fracture, minor PY, minor PO | 105 | | | 1.3' | tr |
| 208.5 - 210.0 | Grano'd, dk. greyish, looks barren | 106 | | | 1.5' | tr |
| 210.0 - 210.7 | Grano'd, strong lt. greenish dk carb. alt'n 1/2" QTZ vien filled with 3/4" massive PY, looks good | 107 | | | 0.7' | .03 |
| 210.7 - 212.6 | Grano'd, dark greyish 1/4" QTZ vienlet minor PY | 108 | | | 1.9' | tr |
| 212.6 - 216.0 | Andesite, possibly andesitic tuff contacts with grano'd are sharp at 40 degrees to core axis, minor QTZ and PO | 109 | | | 3.4' | tr |
| 216.0 - 216.5 | Contact zone between Grano'd and Tuff carries a 1/2" QTZ vien and 3% PY and PO | 110 | | | 0.5' | .03 |

DRILLED BY *James D. ...*

SIGNED *[Signature]*

DIAMOND DRILL RECORD

WINDFALL OILS & MINES LTD.

HOLE NO. 80 - 4 SHEET NO. 10

LATITUDE _____ DATUM _____ STARTED _____
 DEPARTURE _____ BEARING _____ COMPLETED _____
 ELEVATION _____ DIP _____ ULTIMATE DEPTH _____

| DEPTH FEET | FORMATION | SAMPLE NO | FROM | TO | WIDTH | OZS Au | |
|---------------|--|-----------|------|----|-------|---------------|--|
| 216.5 - 218.0 | Grano'd, minor QTZ, minor PY | 111 | | | 1.5' | tr | |
| 218.0 - 219.0 | Grano'd, strong lt. green QTZ Carb. alt'n, 7% PO 2% PY. | 112 | | | 1.0' | .06 | |
| 219.0 - 222.8 | Grano'd, to 220' then andicite from 220' - 222.8' sharp contacts. The andicite carries minor PO. | 113 | | | 3.8' | tr | |
| 222.8 - 223.5 | Grano'd, minor QTZ Carb. alt'n, minor PO | 114 | | | 0.7' | tr | |
| 223.5 - 224.0 | Grano'd, a 1" QTZ vien filled fracture at 55 degrees to core, minor PO. | 115 | | | 0.5' | tr | |
| 224.0 - 227.5 | Grano'd, greyish, looks barren | 116 | | | 3.5' | tr | |
| 227.5 - 229.1 | Grano'd, greyish, looks barren | 117 | | | 1.6' | tr | |
| 229.1 - 229.8 | Grano'd, 1/4" grey QTZ vienlet, 1% PO | 118 | | | 0.7' | .31, .34, .30 | |
| 229.8 - 232.0 | Grano'd, greyish, looks barren | 119 | | | 2.2' | tr | |
| 232.0 - 233.5 | Grano'd, 1" QTZ vienlet at 55 degrees to core, 4" of bleached wall rock alt'n each side and c carries 7% coarse Blob of PY, looks good | 120 | | | 1.5' | .05 | |
| 233.5 - 234.3 | Grano'd, 5" QTZ vien at 55 degrees to core, some coarse blebs of PY, looks good | 121 | | | 0.8' | .02 | |
| 234.3 - 238.0 | Grano'd, greyish, looks barren | 122 | | | 3.7' | tr | |
| 238.0 - 243.0 | Grano'd, greyish, looks barren | 123 | | | 5.0' | tr | |
| 243.0 - 246.0 | Grano'd, greyish, looks barren | 124 | | | 3.0' | tr | |
| 246.0 - 246.8 | Grano'd, greyish, 1/2" QTZ vienlet, minor PO | 125 | | | 0.8' | .02 | |

HOLE 80 - 4

Tro Pari Tests

| Footage | Dip | Bearing | Azim | Footage | Horis. | Vert. |
|---------|-----|---------|---------|-----------|--------|-------|
| Collar | -62 | N-80-E | N-80° E | 0-100' | 47.0 | 88.3 |
| 200' | -60 | N-72° E | 76 | 100'-284' | 92.0 | 159.4 |

DIAMOND DRILL RECORD

WINDFALL OILS & MINES LTD.

HOLE NO. 80 - 5 SHEET NO. 1

LATITUDE 13221.82
 DEPARTURE 11259.42
 ELEVATION 9914.72


ART. CORE SIZE

DATUM *Stand. in office Windfall*
 BEARING .. N-80°-E
 DIP -60°

STARTED .. June 26, 1980
 COMPLETED .. June 30, 1980
 ULTIMATE DEPTH 209.0

| DEPTH FEET | FORMATION | SAMPLE NO | FROM | TO | WIDTH | OZS Au |
|-------------|---|-----------|------|----|-------|--------|
| 0 - 23.0 | Casing in overburden | | | | | |
| 23.0 - | Grano'd, dk, greyish, fine grained, probably chilled contact edge of the grano'd. | | | | | |
| 23.0 - 28.0 | Grano'd, greyish, 1/2% PY | 197 | | | 5.0' | tr |
| 28.0 - 33.0 | Grano'd, greyish, looks barren | 198 | | | 5.0' | tr |
| 33.0 - 38.0 | Grano'd, greyish, fine grained, looks barren. | 199 | | | 5.0' | tr |
| 38.0 - 42.5 | Grano'd, greyish, fine grained, looks barren. | 200 | | | 4.5' | tr |
| 42.5 - 45.8 | Grano'd, greyish, minor PY, minor QTZ | 201 | | | 3.3' | tr |
| 45.8 - 49.0 | Grano'd, fine grained, 2 1/4" QTZ stringers, with PY | 202 | | | 1.2' | tr |
| 49.0 - 51.0 | Grano'd, fine grained, 2 1/4" QTZ vienlets, minor PY | 203 | | | 2.0' | tr |
| 51.0 - 56.0 | Grano'd, fine rained, minor QTZ, minor PY | 204 | | | 5.0' | tr |
| 56.0 - 61.0 | Grano'd, fine grained, looks barren | 205 | | | 5.0' | .03 |
| 61.0 - 63.0 | Grano'd, greyish, looks barren | 206 | | | 2.0' | tr |
| 63.0 - 66.5 | Grano'd, fine grained, minor QTZ, 1% PY | 207 | | | 3.5' | .02 |
| 66.5 - 67.4 | Grano'd, 2 1/4" QTZ vienlets, 1% coarse PY | 208 | | | 0.9' | .07 |
| 67.4 - 71.0 | Grano'd, fine grained, looks barren | 209 | | | 2.6' | tr |
| 71.0 - 76.0 | Grano'd, fine grained, looks barren | 210 | | | 5.0' | tr |
| 76.0 - 79.0 | Grano'd, med. grained, looks barren | 211 | | | 5.0' | tr |

Kenora Drilling Co.

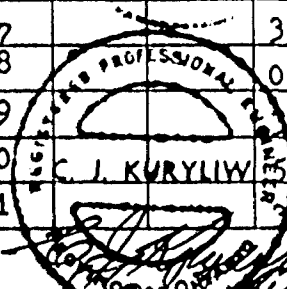

DIAMOND DRILL RECORD

WINDFALL OILS & MINES LTD.

HOLE NO. 80 - 5 SHEET NO. 2

LATITUDE _____ DATUM _____ STARTED _____
 DEPARTURE _____ BEARING _____ COMPLETED _____
 ELEVATION _____ DIP _____ ULTIMATE DEPTH _____

| DEPTH FEET | FORMATION | SAMPLE NO | FROM | TO | WIDTH | OZS Au |
|---------------|---|-----------|------|----|-------|--------|
| 79.0 - 81.6 | Grano'd, greyish, fine grained, looks barren | 212 | | | 2.6' | tr |
| 81.6 - 88.0 | Grano'd, fine grained, chilled contact edge, trace QTZ, trace PY | 213 | | | 6.4' | tr |
| 88.0 - 89.5 | Grano'd, 80% core recovery, 5% QTZ, 1/2% PY | 214 | | | 1.5' | tr |
| 89.5 - 90.5 | Grano'd, 20% sol'd, 3% dissem. PY, at 90.4 minor fault runs at 55 degrees to core. | 215 | | | 1.0' | .02 |
| 90.5 - 95.5 | Andesite, probably a tuff, greyish, fine grained, a few amygdules. | 216 | | | 5.0' | tr |
| 95.5 - 100.0 | 80% grano'd, 20% andesite, a contact zone follows along the core, minor QTZ, minor PY | 217 | | | 4.5' | tr |
| NOTE: | The drill hole id following the contact | | | | | |
| 100.0 - 105.0 | Grano'd, along the contact, vuggy in part, pos- sibly due to PY mineralization and fault movements. | 218 | | | 5.0' | tr |
| 105.0 - 110.0 | Grano'd, med. grained, greyish, minor QTZ, minor PY. | 219 | | | 5.0' | tr |
| 110.0 - 115.0 | 60% andesite, 40% grano'd, the drill hole is sliding along the contact zone. the grano'd is vuggy in part with some PY. | 220 | | | 5.0' | tr |

EdH

DIAMOND DRILL RECORD

WINDFALL OILS & MINES LTD.

HOLE NO. 80 - 5 SHEET NO. 3

LATITUDE _____ DATUM _____ STARTED _____
 DEPARTURE _____ BEARING _____ COMPLETED _____
 ELEVATION _____ DIP _____ ULTIMATE DEPTH _____

| DEPTH FEET | FORMATION | SAMPLE NO | FROM | TO | WIDTH | OZS. Au | |
|---------------|---|-----------|------|----|-------|---|--|
| 115.0 - 120.0 | Andesite, brownish grey, fine grained with fine amygdules, looks barren | 221 | | | 5.0' | tr | |
| 120.0 - 125.0 | Andesite, brownish grey, fine grained with fine amygdules, looks barren | 222 | | | 5.0' | tr | |
| 125.0 - 127.0 | Andesite, brownish grey, fine grained, amygduloidal, looks barren | 223 | | | 2.0' | tr | |
| 127.0 - 127.6 | Andesite, 3/4" QTZ vien at 50 degrees to core, 3% coarse PY, looks good | 224 | | | 0.6' | .06 | |
| 127.6 - 131.5 | Grano'd, greyish 1/2" QTZ vienlet, looks barren | 225 | | | 1.9' | tr | |
| 131.5 - 137.0 | Grano'd, greyish, looks barren | 226 | | | 5.5' | tr | |
| 137.0 - 141.5 | Grano'd, greyish, fine grained, looks barren | 227 | | | 4.5' | tr | |
| 141.5 - 143.2 | Grano'd, greyish, 1/2" QTZ vienlets, looks barren | 228 | | | 1.7' | .01 | |
| 143.2 - 143.7 | Grano'd, 1/2" QTZ vienlet, 3% coarse PY, looks good. | 229 | | | 0.5' | $\left. \begin{matrix} 1.53 \\ 1.02 \end{matrix} \right\} 1.53/0.5$ | |
| 143.7 - 147.5 | Grano'd, greyish, fine grained, looks barren | 230 | | | 3.8' | .02 | |
| 147.5 - 151.5 | Grano'd, greyish, fine grained, 1/2% PY | 231 | | | 4.0' | tr | |
| 151.5 - 156.2 | Grano'd, minor QTZ-carb. alt'n, 2% PY | 232 | | | 4.7' | tr | |
| 156.2 - 157.3 | Grano'd, 1" QTZ vien at 55 degrees to core, 2% coarse PY. | 233 | | | 1.1' | .04 | |
| 157.3 - 158.8 | Grano'd, greyish, looks barren | 234 | | | 1.5' | tr | |
| 158.8 - 159.4 | Grano'd, 2 1/4" QTZ vienlets, 2% PY | 235 | | | 0.6' | tr | |

DRILLED BY John B. ...

SIGNED CPK

DIAMOND DRILL RECORD

WINDFALL OILS & MINES LTD.

HOLE NO. 80 - 5 SHEET NO. 4

LATITUDE _____ DATUM _____ STARTED _____
 DEPARTURE _____ BEARING _____ COMPLETED _____
 ELEVATION _____ DIP _____ ULTIMATE DEPTH _____

| DEPTH FEET | FORMATION | SAMPLE NO. | FROM | TO | WIDTH | OZS. Au |
|---------------|---|------------|------|----|-------|---------|
| 159.4 - 164.0 | Grano'd, greyish, vuggy in part, minor PY | 236 | | | 4.6' | tr |
| 164.0 - 168.5 | Grano'd, greyish, 1/2% PY | 237 | | | 4.5' | tr |
| 168.5 - 173.0 | Grano'd, greyish, looks barren | 238 | | | 4.5' | tr |
| 173.0 - 177.5 | 30% grano'd, 70% andesite, core followed the contact zone, the grano'd is pretty vuggy with some PY | 239 | | | 4.5' | tr |
| 177.5 - 182.0 | Andesite, brownish grey, fine grained, amygdaloidal | 240 | | | 4.5' | tr |
| 182.0 - 186.5 | Andesite, brownish grey, fine grained, amygdaloidal | 241 | | | 4.5' | tr |
| 186.5 - 191.0 | Andesite, brownish ^{grey} , fine grained, amygduloidal | 242 | | | 4.5' | tr |
| 191.0 - 195.3 | Contact zone, 80% grano'd, 20% andesite, drill core follows along the grano'd - andesite contact which undulates along the core, the grano'd is vuggy at the contact with 1% PY | 243 | | | 4.3' | .10 |
| 195.3 - 199.7 | Grano'd, greyish, fine grained, traces PY | 244 | | | 4.4' | tr |
| 199.7 - 204.5 | Grano'd, greyish, looks barren | 245 | | | 4.8' | tr |
| 204.5 - 209.0 | Grano'd, greyish, fine grained, looks barren | 246 | | | 4.5' | tr |

NOTE : This hole was stopped at 209' due to the fact that the drill hole was following in and out of the contact zone between a grano'd dyke and an

DRILLED BY [Signature]

SIGNED

[Signature]

HOLE No. 80 - 5

| Footage | Dip | Bearing | Azim. | Footage | Horiz | Vert. |
|---------|------|----------|----------|----------|-------|-------|
| Collar | -60° | N - 80°E | N - 80°E | 0 - 209' | 104.5 | 181.1 |

DIAMOND DRILL RECORD

WINDFALL OILS & MINES LTD.

HOLE NO. 80 -6 SHEET NO. 1

AXT Core

LATITUDE 13202.46

DATUM *Stored in office Windfall*

STARTED July 1, 1980

DEPARTURE 11376.75

BEARING N-79 19' 07"-E
Tro Paris Collar = 58 21' 19" N-79-19'-E


COMPLETED July 9, 1980

ELEVATION 9921.40

DIP @200 = 53 @400 = 53 N-85-E

ULTIMATE DEPTH 502.0'

| DEPTH FEET | FORMATION | SAMPLE NO | FROM | TO | WIDTH | OZS Au |
|--------------|--|-----------|------|----|-------|--------------------------------|
| 0 - 15.0 | Casing in overburden | | | | | |
| 15.0 - 80.0, | Grano'd, dk greyish, fine grained, massive, generally barren with very little QTZ fractures | | | | | |
| 45.3 - 46.3 | Grano'd, 1/2" QTZ vien with massive PY, runs at 50 degrees to core | 466 | | | 1.0' | .07 |
| 57.7 - 58.3 | Grano'd, 1/2" QTZ-carb vienlet with massive PY, runs 50 degrees to core | 467 | | | 0.6' | .07 |
| 80.0 - 82.0 | Gran'd, med. grained, two 1/4" QTZ stringers, minor PY | 468 | | | 2.0' | Tr |
| 80.0 - 160.0 | Grano'd, greyish, med. grained with several QTZ vienlets, running at 55 degrees to core, some with wall rock alt'n with coarse to massive PY some of these carry V.G | | | | | |
| 82.0 - 85.0 | Grano'd, dk greyish, med. grained, minor QTZ, minor PY | 469 | | | 3.0' | Tr |
| 85.0 - 89.0 | Grano'd, 3% QTZ in narrow stringers, 1/2% PY | 470 | | | 4.0' | Tr |
| 89.0 - 90.0 | Grano'd, a 2" banded QTZ vienlet at 50 degrees to core, 2% coarse PY | 471 | | | 1.0' | Tr |
| 90.0 - 91.0 | Grano'd, a 2" glassy QTZ vien runs at 35 degrees to core and carries two specs of V.G. at 90.5' | 472 | | | 1.0' | { 0.07 0.06 0.06 } 0.063 |

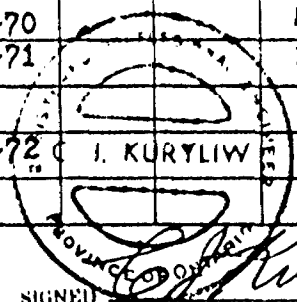

DRILLED BY *W. J. Williams Co*

SIGNED *J. Kuryliw*

DIAMOND DRILL RECORD

WINDFALL OILS & MINES LTD.

HOLE NO. 80 - 6 SHEET NO. 2

LATITUDE _____ DATUM _____ STARTED _____
 DEPARTURE _____ BEARING _____ COMPLETED _____
 ELEVATION _____ DIP _____ ULTIMATE DEPTH _____

| DEPTH FEET | FORMATION | SAMPLE NO. | FROM | TO | WIDTH | OZS Au | |
|---------------|--|------------|------|----|-------|--------------------------|------|
| 91.0 - 93.0 | Grano'd, minor QTZ, minor Py | 473 | | | 2.0' | Tr | |
| 93.0 - 97.0 | Grano'd, greyish, med. grained, looks barren | 474 | | | 4.0' | Tr | |
| 97.0 - 101.3 | Grano'd, minor QTZ, minor PY | 475 | | | 4.3' | Tr | |
| 101.3 - 102.0 | Grano'd, a 1/2" QTZ vien with 3% PY runs at 50 degrees to core | 476 | | | 0.7' | Tr | |
| 102.0 - 106.0 | Grano'd, greyish, looks barren | 477 | | | 4.0' | Tr | |
| 106.0 - 106.8 | Grano'd, a 2" QTZ vien runs at 50 degrees to core with 2% PY, a one of V.G in carbonate included in the QTZ | 478 | | | 0.8' | .04 | |
| 106.8 - 110.0 | Grano'd, greyish, looks barren | 479 | | | 3.2' | Tr | |
| 110.0 - 112.6 | Grano'd, greyish, minor QTZ, minor PY | 480 | | | 2.6' | Tr | |
| 112.6 - 113.6 | Grano'd, a 1" QTZ vien with 2" greenish wall rock alt'n each side which carries 2% PO, 3% PY, looks good | 481 | | | 1.0' | .02 | |
| 113.6 - 114.6 | Grano'd, a 1/4" QTZ vienlet with massive PY carries one fine spec of V.G, 4" of wall rock alt'n arrying PY borders the vienlet | 482 | | | 1.0' | { 0.60 0.63 0.69 } | 0.64 |
| 114.6 - 118.0 | Granod, looks barren | 483 | | | 3.4' | .06 | |
| 118.0 - 118.8 | Grano'd, two 1/4" QTZ vienlets, minor PY | 484 | | | 0.8' | Tr | |
| 118.8 - 123.8 | Grano'd, greyish, looks barren | 485 | | | 0.5' | Tr | |
| 123.8 - 129.5 | Grano'd, looks barren | 486 | | | 5.7' | Tr | |

GAH

DIAMOND DRILL RECORD

WINDFALL OILS & MINES LTD.

HOLE NO. 80 - 6 SHEET NO. 3

LATITUDE _____ DATUM _____ STARTED _____
 DEPARTURE _____ BEARING _____ COMPLETED _____
 ELEVATION _____ DIP _____ ULTIMATE DEPTH _____

| DEPTH FEET | FORMATION | SAMPLE NO | FROM | TO | WIDTH | OZS Au | |
|---------------|---|-----------|------|----|-------|--------------------------------|------|
| 129.5 - 130.8 | Grano'd, strong green QTZ-carb alt'n, 5% massive PY | 487 | | | 1.9' | .04 | |
| 130.8 - 131.0 | Grano'd, greyish, minor QTZ, minor PY | 488 | | | 2.2' | Tr | |
| 133.0 - 134.0 | Grano'd, two 1/2" QTZ vienlets, one with massive PY runs at 55 degrees to core | 489 | | | 1.0' | Tr | |
| 134.0 - 135.0 | Grano'd, greyish, 1/4" QTZ-carb vienlet with 50% massive Py Carries a spec. of V.G. at 134.5 Wall rock alt'n 1" wide occurs in each side of the vienlet | 490 | | | 1.0' | { 2.01 2.29 2.08 } | 2.12 |
| 135.0 - 140.0 | Grano'd, greyish, looks barren | 491 | | | 5.0' | .09 | |
| 151.0 - 153.0 | Gabbro dyke, dk greyish, fine to med, grained with its contact at 30 degrees to core | | | | | | |
| 176.7 - 177.4 | A 2" glassy QTZ vien at 50 degrees to core, m minor PY | 492 | | | 0.7' | .04 | |
| 199.0 - 199.8 | Grano'd, a 1" QTZ vien and a 1 1/2" massive PY vien at 50 degrees to core, looks good | 493 | | | 0.8' | { .81 .89 .89 } | .86 |
| 214.3 - 214.8 | Grano'd, a 1" glassy QTZ vien at 50 degrees to core, minor PY | 494 | | | 0.5 | .06 | |
| 225.8 - 226.5 | Grano'd, strong QTZ-carb alt'n, greenish | 495 | | | 0.7 | .03 | |

DRILLED BY W. A. D. O.

SIGNED W. A. D. O.

DIAMOND DRILL RECORD

WINDFALL OILS & MINES LTD.

HOLE NO. 80 - 6 SHEET NO. 4

LATITUDE _____ DATUM _____ STARTED _____
 DEPARTURE _____ BEARING _____ COMPLETED _____
 ELEVATION _____ DIP _____ ULTIMATE DEPTH _____

| DEPTH FEET | FORMATION | SAMPLE NO | FROM | TO | WIDTH | OZS Au | | |
|---------------|---|-----------|------|----|-------|--------|-----|------|
| 235.8 - 236.6 | Grano'd, a 2" QTZ vienlet at 50 degrees with 3" of green QTZ-carb wall rock alt'n, minor PY | 496 | | | 0.8' | .12 | | |
| 242.5 - 243.3 | Grano'd, a 3" glassy QTZ vien, 50 degrees to core, minor PY | 497 | | | 0.8' | .02 | | |
| 245.5 - 248.0 | Grano'd, two 4" sections of strong QTZ-carb alt'n 1% PY | 498 | | | 2.5' | Tr | | |
| 153.0 - 249.0 | From 153.0 - 249.0 grano'd, greyish fine to med. grained occasional narrow QTZ vienlet | | | | | | | |
| 261.0 - 510.0 | Grano'd, greyish, med. grained occasional QTZ vienlet and wall rock alt'n | 470 | | | | | | |
| 248.0 - 249.0 | Grano'd, a 3" QTZ vien with rusty wall rock a alt'n | 499 | | | 1.0' | Tr | | |
| 262.5 - 263.2 | Grano'd, a 2" glassy QTZ vien some rusty wall rock alt'n | 500 | | | 0.7' | .02 | | |
| 266.5 - 267.3 | Grano'd, a 1" QTZ vienlet, minor wall rock alt'n | 501 | | | 0.8' | .04 | | |
| 268.0 - 268.7 | Grano'd, a 1" QTZ-carb. vien 1% PO, 1% PY | 502 | | | 0.7' | .38 | .32 | .336 |
| 272.3 - 273.5 | Grano'd, two 1" QTZ vienlets, 1% PY, 15% PO | 503 | | | 1.2' | .01 | | |
| 278.5 - 279.3 | Grano'd, two 1" QTZ vienlets, 3% PY, looks good | 504 | | | 0.8' | .03 | | |
| 279.3 - 282.0 | Grano'd, dk greyish, minor PY, minor QTZ | 505 | | | 2.7' | Tr | | |

CRK

DIAMOND DRILL RECORD

WINDFALL OILS & MINES LTD.

HOLE NO. 80 - 6 SHEET NO. 5

LATITUDE _____ DATUM _____ STARTED _____
 DEPARTURE _____ BEARING _____ COMPLETED _____
 ELEVATION _____ DIP _____ ULTIMATE DEPTH _____

| DEPTH FEET | FORMATION | SAMPLE NO | FROM | TO | WIDTH | OZS Au | |
|---------------|---|-----------|------|----|-------|----------------------|------|
| 282.0 - 283.5 | Grano'd, med. QTZ-carb alt'n, 3% PY | 506 | | | 1.5' | Tr | |
| 283.5 - 286.1 | Grano'd, dk greyish, looks barren | 507 | | | 2.6' | Tr | |
| 286.1 - 287.1 | Grano'd, strong QTZ-carb. alt'n with a 1/2" carb vien which carries coarse specs of dk brown ZNS | 508 | | | 1.0' | Tr | |
| 287.1 - 288.5 | Grano'd, greyish, looks barren | 509 | | | 1.4' | Tr | |
| 292.3 - 293.8 | Grano'd, minor QTZ-carb alt'n, minor PY | 510 | | | 1.5' | Tr | |
| 293.8 - 294.8 | Grano'd, two 1/2" QTZ vienlets, 2% PY | 511 | | | 1.0' | .06 | |
| 294.8 - 295.6 | Grano'd, a 1/2" QTZ vienlet at 60 degrees tp core, one coarse spec of Y.G at 295.3, some rusty wall rock alt'n | 512 | | | 0.8' | 0.70 0.79 0.72 | 0.73 |
| 295.6 - 297.4 | Grano'd, 1/2" QTZ vien, 1/2% coarse PY | 513 | | | 1.8' | Tr | |
| 299.0 - 299.7 | Grano'd, a 1" QTZ vien at 60 degrees to core, minor PY | 514 | | | 0.7' | Tr | |
| 302.0 - 302.6 | Grano'd, two 1/2" QTZ vienlets, minor PY | 555 | | | 0.6' | .03 | |
| 304.7 - 306.8 | Grano'd, with some carb. hematite alt'n, 5% coarse carb. and 2 apletic dykes, one inch wide each at 305.2 and 306.6 | 515 | | | 2.1' | .01 | |
| 308.2 - 309.8 | Grano'd, a 3" QTZ vien at 60 degrees tp core, 5% coarse PY | 516 | | | 1.6' | .20 | |
| 309.8 - 311.4 | Grano'd, a 1/2" QTZ vienlet with 3" of strong QTZ-carb wall rock alt'n that carries 5% PY, | | | | | | |

CSK

DIAMOND DRILL RECORD

WINDFALL OILS & MINES LTD.

HOLE NO. 80 - 6 SHEET NO. 6

LATITUDE _____ DATUM _____ STARTED _____
 DEPARTURE _____ BEARING _____ COMPLETED _____
 ELEVATION _____ DIP _____ ULTIMATE DEPTH _____

| DEPTH FEET | FORMATION | SAMPLE NO | FROM | TO | WIDTH | OZ. Au | |
|---------------|--|-----------|------|----|-------|----------------------|-------|
| | 2% PO | 517 | | | 1.6' | .04 | |
| 311.4 - 313.4 | Grano'd, strong QTZ-carb alt'n, 2% coarse PY | 518 | | | 2.0' | .02 | |
| 313.4 - 314.6 | Grano'd, a 3" QTZ vien at 60 degrees to core, 1/2% PY | 519 | | | 1.2' | .02 | |
| 314.6 - 316.8 | Grano'd, minor QTZ, minor PY | 520 | | | 2.2' | Tr | |
| 316.8 - 317.4 | Grano'd, a 2" QTZ vien with 5% massive PY | 521 | | | 0.6' | .13 | |
| 317.4 - 322.8 | Grano'd, dk. greyish, minor QTZ, minor PY | 522 | | | 5.4' | Tr | |
| 322.8 - 324.5 | Grano'd, one 3" glassy QTZ vien, the other a 1" QTZ vien that carries 5% coarse PY in wall rock alt'n | 523 | | | 1.7' | Tr | |
| 334.0 - 335.4 | Grano'd, coarse grained, two 1/4" QTZ stringers, minor PY | 524 | | | 1.4' | .02 | |
| 338.6 - 343.4 | Grano'd, greyish, coarse grained, looks barren | 525 | | | 4.8' | Tr | |
| 343.4 - 344.1 | Grano'd, a 3" QTZ vien at 60 degrees to core carries some coarse PY and several specs of <u>V.G.</u> with altaite at 343.9 | 526 | | | 0.7' | 0.57 0.57 0.69 | 0.597 |
| 344.1 - 345.3 | Grano'd, greyish, looks barren | 527 | | | 1.2' | Tr | |
| 353.6 - 354.2 | Grano'd coarse grained, a 1/2" QTZ vien, carries 1% PY and some ZNS | 528 | | | 0.6' | .02 | |
| 354.2 - 355.6 | Grano'd, med QTZ-carb alt'n, 2% PY | 529 | | | 1.4' | Tr | |
| 358.8 - 359.4 | Grano'd, a 1/2" QTZ vienlet, minor PY | 530 | | | 0.6' | Tr | |

DRILLED BY _____

SIGNED *EJK*

DIAMOND DRILL RECORD

WINDFALL OILS & MINES LTD.

HOLE NO. 80 - 6 SHEET NO. 7

LATITUDE _____ DATUM _____ STARTED _____
 DEPARTURE _____ BEARING _____ COMPLETED _____
 ELEVATION _____ DIP _____ ULTIMATE DEPTH _____

| DEPTH FEET | FORMATION | SAMPLE NO. | FROM | TO | WIDTH | OZS Au |
|---------------|--|------------|------|----|-------|-------------------------------|
| 365.0 - 366.0 | Grano'd, a 3" QTZ vien at 50 degrees to core, 5% coarse PY, in wall rock, looks good | 531 | | | 0.16' | .05 |
| 366.0 - 370.0 | Grano'd, dk greyish, coarse grained, loos barren | 532 | | | 3.0' | Tr |
| 370.0 - 371.4 | Grano'd, 4" QTZ vien at 45 degrees to core, 30 coarse PY in wall rock alt'n | 533 | | | 1.4' | .06 |
| 371.4 - 372.2 | Grano'd, dk greyish, looks barren | 534 | | | 0.8' | .03 |
| 372.2 - 373.3 | Grano'd, a 1" QTZ vien with strong wall rock alt'n, 1% PY | 535 | | | 1.1' | Tr |
| 373.3 - 378.3 | Grano'd, looks barren | 536 | | | 5.0' | Tr |
| 378.0 - 379.0 | Grano'd, a 1/2" QTZ vien, minor PY | 537 | | | 1.0' | Tr |
| 383.8 - 385.1 | Grano'd, strong QTZ-carb alt'n with 5% coarse Py, contains a 3" QTZ-carb vien at 50 degrees tocore with V.G. at 385.0 along the edge of the vienlet | 538 | | | 1.3' | { 0.17 0.13 0.18 } 0.16 |
| 385.1 - 386.8 | Grano'd, dk greyish, looks barren | 539 | | | 1.7' | Tr |
| 386.8 - 388.4 | Grano'd, two 1" QTZ vienlets, 1% PY | 540 | | | 1.6' | Tr |
| 388.4 - 393.4 | Grano'd, dk greyish, looks barren | 541 | | | 5.0' | Tr |
| 393.4 - 395.0 | Grano'd, wk QTZ-carb alt'n, 1/2% PY | 542 | | | 1.6' | Tr |
| 395.0 - 397.1 | Grano'd, two 1" QTZ vienlets, with some wall rock alt'n, 1% PY | 543 | | | 2.1' | .04 |

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DIAMOND DRILL RECORD

WINDFALL OILS & MINES LTD.

HOLE NO. 80 - 6 SHEET NO. 8

LATITUDE _____ DATUM _____ STARTED _____
 DEPARTURE _____ BEARING _____ COMPLETED _____
 ELEVATION _____ DIP _____ ULTIMATE DEPTH _____

| DEPTH FEET | FORMATION | SAMPLE NO | FROM | TO | WIDTH | OZS. Au | |
|---------------|---|-----------|------|----|-------|----------------------|------|
| 397.1 - 398.4 | Grano'd, a 1/2" QTZ-carb vien with 3" QTZ-carb wall rock alt'n that carries 1% PO, 1% PY | 544 | | | 1.3' | .01 | |
| 398.4 - 401.4 | Grano'd, dk greyish, looks barren | 545 | | | 3.0' | Tr | |
| 401.4 - 402.8 | Grano'd, a 1" glassy QTZ vien that runs at 50 degrees to core, has strong wall rock alt'n with coarse PY and a spec of V.G at 402.5 | 546 | | | 1.4' | 0.03 0.02 0.02 | .023 |
| 402.8 - 405.0 | Grano'd, dk. greyish, looks barren | 547 | | | 2.2' | Tr | |
| 405.0 - 406.2 | Grano'd, several 1/8" QTZ fractures that carries 1% coarse PY | 548 | | | 1.2' | .02 | |
| 406.2 - 409.8 | Grano'd, dk greyish, looks barren | 549 | | | 3.6' | Tr | |
| 409.8 - 410.4 | Grano'd, 1" QTZ vien, minor PY | 550 | | | 0.6' | Tr | |
| 415.3 - 415.8 | Grano'd, 1/2" QTZ vien, minor PY | 551 | | | 0.5' | .01 | |
| 419.3 - 420.7 | Grano'd, a 1/2" QTZ vienlet with minor PY | 552 | | | 1.4' | .02 | |
| 420.7 - 422.1 | Grano'd, dk greyish, looks barren | 553 | | | 1.4' | Tr | |
| 422.1 - 422.8 | Grano'd, a 6" glassy QTZ vien at 50 degrees to core, some coarse PY in wall rock | 554 | | | 0.7' | .02 | |
| 422.8 - 424.0 | Grano'd, one 1/2" QTZ vienlet at 50 degrees to core, 3% PY in altered wall rock | 556 | | | 1.2' | .05 | |
| 424.0 - 425.0 | lost core | | | | | | |
| 425.0 - 426.7 | Grano'd, dk. greyish, minor QTZ, minor PY | 558 | | | 1.7' | Tr | |
| 426.7 - 429.0 | Grano'd, wk QTZ carb, alt'n 1% PY | 558 | | | 2.3' | Tr | |

DRILLED BY _____

SIGNED 

DIAMOND DRILL RECORD

WINDFALL OILS & MINES LTD.

HOLE NO. 80 - 6 SHEET NO. 9

LATITUDE _____ DATUM _____ STARTED _____
 DEPARTURE _____ BEARING _____ COMPLETED _____
 ELEVATION _____ DIP _____ ULTIMATE DEPTH _____

| DEPTH, FEET | FORMATION | SAMPLE NO. | FROM | TO | WIDTH | OZS. Au |
|---------------|--|------------|------|----|-------|---------|
| 429.0 - 431.9 | Grano'd, a 1/2" QTZ-carb vienlet with coarse PY, and strong wall rock alt'n, dk greyish, minor QTZ, minor PY | 559 | | | 2.9' | Tr |
| 431.9 - 435.5 | Grano'd, minor QTZ, minor PY | 561 | | | 3.6' | Tr |
| 435.5 - 437.1 | Grano'd, a 3" glassy QTZ vien at 55 degrees to core, 1% PY | 562 | | | 1.6' | .16 |
| 443.7 - 444.7 | Grano'd, one 2" and 1" QTZ vienlets, med. wall rock alt'n, 2% PY | 563 | | | 1.0' | .13 |
| 444.7 - 448.8 | Grano'd, coarse grained, looks barren | 564 | | | 4.1' | Tr |
| 448.8 - 450.3 | Grano'd, a 1" QTZ vien at 55 degrees to core, 1/2% PO, 1/2% PY | 565 | | | 1.5' | Tr |
| 450.3 - 452.2 | Grano'd, four 1/2" QTZ vienlets with strong wall rock alt'n, 3% coarse PY, looks good | 566 | | | 1.9' | .09 |
| 452.2 - 456.1 | Grano'd, dk greyish, minor QTZ, minor PY | 567 | | | 3.9' | Tr |
| 456.1 - 456.8 | Grano'd, a 2" QTZ-carb vienlet, 1% PY | 568 | | | 0.7' | Tr |
| 456.8 - 459.6 | Grano'd, dk. greyish, minor QTZ, minor PY | 569 | | | 2.8' | Tr |
| 459.6 - 461.2 | Grano'd, med. QTZ-carb alt'n, 3% PY | 570 | | | 1.6' | .08 |
| 466.3 - 468.6 | Grano'd, med. QTZ alt'n, 2% PY, a trace of ZNS | 571 | | | 2.3' | Tr |
| 471.2 - 472.0 | Grano'd, a 2" QTZ vien, 1% coarse PY | 572 | | | 0.8' | Tr |
| 478.4 - 480.0 | Grano'd, three 1" QTZ vienlets, med. QTZ-carb alt'n, 3% coarse PY | 573 | | | 1.6' | Tr |

DRILLED BY *W. J. ...*

CRK

DIAMOND DRILL RECORD

WINDFALL OILS & MINES LTD.

HOLE NO. 80 - 6 SHEET NO. 10

LATITUDE _____ DATUM _____ STARTED _____
 DEPARTURE _____ BEARING _____ COMPLETED _____
 ELEVATION _____ DIP _____ ULTIMATE DEPTH _____

| DEPTH FEET | FORMATION | SAMPLE NO | FROM | TO | WIDTH | OZS. Au |
|---------------|---|-----------|------|----|-------|---------|
| 482.3 - 483.0 | Grano'd, a 1/2" QTZ vien at 50 degrees to core, 3% PO, 2% PY in viens | 574 | | | 0.7' | Tr |
| 486.7 - 487.7 | Grano'd, strong QTZ-carb alt'n, 3% coarse PO, 3% coarse PY, a trace of ZNS | 575 | | | 1.0' | .04 |
| 500.6 - 502.0 | Grano'd, a 1/2" QTZ vienlet at 40 degrees to core, minor PY | 576 | | | 1.4' | Tr |
| | 510.0 End of hole | | | | | |
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DRILLED BY W. H. H. [Signature]

SIGNED [Signature]

DIAMOND DRILL RECORD

WINDFALL OILS & MINES LTD.

Ax Core

HOLE NO. 80 - 7 SHEET NO. 1

LATITUDE 13258.68

DATUM Stored in office Windfall

STARTED July, 1980

DEPARTURE 11359.36

BEARING N-82 21'55"-E


COMPLETED July 14, 1980

ELEVATION 9922.92

Tro Pari Collar -59 30'45"
 @ 200' -58 N-69-E
 @ 400' -56 N-84-E

ULTIMATE DEPTH 486.0'

| DEPTH FEET | FORMATION | SAMPLE NO. | FROM | TO | WIDTH | OZS Au |
|-------------|--|------------|------|----|-------|--------|
| 0 - 13.0 | Casing in overburden | | | | | |
| 13.0 - 96.5 | Grano'd, greyish to dk greyish, fine to med grained generally barren, with a few widely spaced QTZ filled fractures | | | | | |
| 45.7 - 46.3 | Grano'd, a 3" glassy QTZ vien at 60 degrees to core axis, minor PY | 376 | | | 0.6' | .01 |
| 62.5 - 63.5 | Two 1/4" QTZ stringers at 60 degrees to core, 1% coarse PY | 377A | | | 1.0' | Tr |
| 67.8 - 68.8 | Grano'd, Two 1/2" QTZ vienlets, running at 60 degrees to core axis, 1% PY | 378 | | | 1.0' | .06 |
| 72.2 - 72.7 | Grano'd, 1/2" QTZ vienlet at 60 degrees to core axis, minor PY | 379 | | | 0.5' | Tr |
| 90.0 - 92.5 | Grano'd, a one inch and 1/2" QTZ vienlets, minor PY & PO | 380 | | | 2.5' | Tr |
| 96.5 - 98.4 | Grano'd, two 1/4" QTZ vienlets with 2" QTZ-carb alt'n, wall rock carrying 2% PO, 1/2% PY | 381 | | | 1.9' | .02 |
| NOTE: | 96.5 - 131.0 Grano'd, dark greyish, fine to med. grained, contains several sections of narrow QTZ vienlets, bordered by light greenish | | | | | |

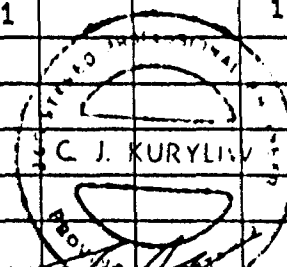

[Handwritten Signature]
 C. J. Kurylin

DRILLED BY Kemera Diamond Drilling Co

DIAMOND DRILL RECORD WINDFALL OILS & MINES LTD.

HOLE NO. 80 - 7 SHEET NO. 2

LATITUDE _____ DATUM _____ STARTED _____
 DEPARTURE _____ BEARING _____ COMPLETED _____
 ELEVATION _____ DIP _____ ULTIMATE DEPTH _____

| DEPTH FEET | FORMATION | SAMPLE NO. | FROM | TO | WIDTH | OZS. Au | |
|---------------|--|------------|------|----|-------|-----------------------------|-----|
| | Qtz-carb wall rock alt'n that carries some PO with minor PY | | | | | | |
| 131.0 - 131.3 | QTZ- sericite dyke running at 25 degrees to core. This represents a fault plane. | | | | | | |
| 131.3 - 164.0 | Andesitic Tuff, dk greyish, fine grained, some fine banding and amygdule-like carb. flecs | | | | | | |
| 100.2 - 100.9 | 1/2" QTZ vein at 45 degrees to core, minor PO and PY in wall rock alt'n | 382 | | | 0.7' | .01 | |
| 102.6 - 103.1 | Grano'd, 1/2" QTZ vienlet at 60 degrees to core, minor PY & PO | 383 | | | 0.5' | .01 | |
| 104.7 - 105.3 | Grano'd, 1/2" QTZ vien at 50 degrees to core, 2% PO wall rock alt'n 1/2% PY | 384 | | | 0.6' | .06 | |
| 107.0 - 108.2 | Grano'd, strong QTZ-carb alt'n, bleached minor QTZ, 10% large cubes and masses of PY, minor PO, looks good | 385 | | | 1.2' | { .30 .39 .41 } | .36 |
| 114.6 - 115.2 | Grano'd, 1/2" QTZ vien at 50 degrees to core contains 70% massive PY | 386 | | | 0.6' | { .35 .34 .28 } | .32 |
| 118.0 - 118.5 | Grano'd, a 3" QTZ vien at 45 degrees to core, looks barren | 387 | | | 0.5' | .08 | |

EdH

DIAMOND DRILL RECORD

WINDFALL OILS & MINES LTD.

HOLE NO. 80 - 7 SHEET NO. 3

LATITUDE _____ DATUM _____ STARTED _____
 DEPARTURE _____ BEARING _____ COMPLETED _____
 ELEVATION _____ DIP _____ ULTIMATE DEPTH _____

| DEPTH FEET | FORMATION | SAMPLE NO | FROM | TO | WIDTH | OZS Au | |
|---------------|--|-----------|------|----|-------|-----------------------|-----|
| 124.2 - 125.3 | Grano'd, a 3" QTZ-carb vien at 60 degrees to core, with 2" of green wall rock QTZ-carb alt'n which contains 2% PO, 1% PY | 388 | | | 1.1 | .02 | |
| 127.3 - 128.7 | Grano'd, a 1" QTZ-carb vien at 45 degrees to core, strong wall rock, greenish QTZ-carb alt'n 3% coarse PO, 2% coarse PY | 389 | | | 1.4' | .01 | |
| 132.5 - 133.5 | Tuff, a 1" Q.-C vien with some wall rock alt'n, 2% coarse PY | 390 | | | 1.0' | { .41 :20 :21 } | .27 |
| 149.0 - 151.0 | Andesitic Tuff, 2% coarse PY, vuggy in part | 391 | | | 2.0' | .01 | |
| 164.0 - 217.5 | Grano'd, med. to coarse grained, some narrow mineralized sections | | | | | | |
| 217.5 - 233.2 | Andesitic Tuff, greenish grey, some fine banding | | | | | | |
| 233.2 - 301.7 | Grano'd, greyish, med. to coarse grained, a blocky, rusty fault zone from 256.5 - 262.0 | | | | | | |
| 164.7 - 166.8 | Grano'd, two 1/2" QTZ vienlets, 1/2% PY | 392 | | | 2.1' | .01 | |
| 175.3 - 176.0 | Grano'd, some weak q.c alt'n, 1% PY | 393 | | | 0.7' | .02 | |
| 179.4 - 180.2 | Grano'd, med. q-c alt'n, 3% PO, 1% PY | 394 | | | 0.8' | Tr | |
| 187.0 - 189.5 | Grano'd, 4" glassy QTZ vien, with some med. wall rock alt'n that carries 2% PY | 395 | | | 2.5' | .01 | |
| 195.0 - 196.0 | Grano'd, a 1" QTZ vien at 45 degrees to core | | | | | | |

DRILLED BY *[Signature]*

SEARCHED

DIAMOND DRILL RECORD

WINDFALL OILS & MINES LTD.

HOLE NO. 80 - 7 SHEET NO. 4

LATITUDE _____ DATUM _____ STARTED _____
 DEPARTURE _____ BEARING _____ COMPLETED _____
 ELEVATION _____ DIP _____ ULTIMATE DEPTH _____

| DEPTH FEET | FORMATION | SAMPLE NO | FROM | TO | WIDTH | OZS Au | |
|---------------|---|-----------|------|----|-------|----------------|------|
| | some weak wall rock alt'n, 1/2% PY | 396 | | | 1.0' | .01 | |
| 204.7 - 205.4 | Grano'd, strong q-c alt'n, 3% PO, 1% PY | 397 | | | 0.7' | Tr | |
| 206.5 - 207.2 | Grano'd, 1/2" QTZ vien, minor PY <small>NOTE: 1/2" IN CORE AT 206.9</small> | 398 | | | 0.7' | {1.15 1.67} | 1.54 |
| 218.0 - 218.6 | Andesitic Tuff, a 1/2" QTZ vienlet at 55 degrees to core, carries minor ZNS and 1% PY | 399 | | | 0.6' | {1.79 .05} | |
| 223.0 - 223.9 | Andesitic Tuff a 1" and 1/2" QTZ vien at 45 degrees to core, 3% coarse PY, 1% PO | 400 | | | 0.9' | {.25 .14} | .16 |
| 228.0 - 229.3 | Andesitic Tuff, a 2" QTZ vien at 40 degrees to core, 3% coarse PY in vien | 401 | | | 1.3' | .01 | |
| 233.0 - 236.0 | Grano'd, med q-c alt'n, 1% PY, 1% PO | 402 | | | 3.0' | .02 | |
| 238.3 - 239.5 | Grano'd, med q-c alt'n, 2% coarse PY | 403 | | | 1.2' | .04 | |
| 242.0 - 242.8 | Grano'd, 1/2" QTZ vien at 60 degrees to core, 2% PO, 1% PY | 404 | | | 0.8' | .01 | |
| 247.0 - 247.6 | Grano'd, 2" glassy QTZ vien at 60 degrees to core, minor PY | 405 | | | 0.6' | Tr | |
| 251.0 - 252.0 | Grano'd, 1 1/2" QTZ vienlet at 60 degrees to core, 1/2% PY | 406 | | | 1.0' | Tr | |
| 256.0 - 256.7 | Grano'd, 1/2" QTZ vienlet, some hematitic alt'n | 407 | | | 0.7' | .02 | |
| 263.0 - 264.5 | Grano'd, two 1" QTZ vienlets at 60 degrees to core, 1% PY, some rusty alt'n | 408 | | | 1.5' | .02 | |
| 274.0 - 274.8 | Grano'd, two 1/2" QTZ vienlets with some wall | 409 | | | 0.8' | .03 | |

DRILLED BY _____

6/2/58

DIAMOND DRILL RECORD WINDFALL OILS & MINES LTD.

HOLE NO. 80 - 7 SHEET NO. 5

LATITUDE _____ DATUM _____ STARTED _____
 DEPARTURE _____ BEARING _____ COMPLETED _____
 ELEVATION _____ DIP _____ ULTIMATE DEPTH _____

| DEPTH FEET | FORMATION | SAMPLE NO. | FROM | TO | WIDTH | OZ/AU | |
|---------------|---|------------|------|----|-------|-------|-------|
| 279.0 - 279.5 | Grano'd, 1/2" QTZ vien, 1% PY | 410 | | | 0.5' | .01 | |
| 280.2 - 280.7 | Grano'd, a 1" QTZ vienlet at 60 degrees to core, 1% PY | 411 | | | 0.5' | .02 | |
| 281.8 - 282.8 | Grano'd, two 1/4" QTZ vienlets, 1/2% PY | 412 | | | 1.0' | .01 | 12.25 |
| 290.1 - 290.8 | Grano'd, a 3" glassy QTZ vien at 60 degrees to core, minor PY | 413 | | | 0.7' | .20 | .203 |
| 300.3 - 301.7 | Grano'd, chilled contact edge, 1% dissem. PY | 414 | | | 1.4' | .01 | |
| 301.7 - 302.3 | Sericitic, waxy QTZ-por'y dyke, vuggy with some PY, a fault zone | 415 | | | 0.6' | Tr. | |
| 314.5 - 315.2 | Grano'd, 1/2" QTZ vienlet, minor PY | 416 | | | 0.7' | .01 | |
| Notes: | 302.3 - 315.2 Grano'd, fine to med grained, dk greyish, looks barren | | | | | | |
| | 315.2 - 316.3 Andesitic tuff, dk greyish, darkly banded | | | | | | |
| | 316.0 - 429.0 Grano'd dyke, fine to med. grained, dk greyish | | | | | | |
| 318.0 - 319.0 | Grano'd, dk greyish, looks barren | 417 | | | 1.0' | Tr | |
| 319.0 - 320.2 | Grano'd, a 1" and 1/2" QTZ vienlet at 65 degrees to core, 2% coarse py | 418 | | | 1.2' | Tr | |

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DIAMOND DRILL RECORD

WINDFALL OILS & MINES LTD.

HOLE NO. 80 - 7 SHEET NO. 6

LATITUDE _____ DATUM _____ STARTED _____
 DEPARTURE _____ BEARING _____ COMPLETED _____
 ELEVATION _____ DIP _____ ULTIMATE DEPTH _____

| DEPTH FEET | FORMATION | SAMPLE NO | FROM | TO | WIDTH | OZS Au |
|---------------|--|-----------|------|----|-------|--------------------------------|
| 320.2 - 323.5 | Grano'd, dk greyish, fine grained, one 1/4" QTZ vienlet, minor PY | 419 | | | 3.3' | Tr |
| 323.5 - 325.0 | Grano'd, a 1/2" QTZ vienlet with q-c wall rock alt'n, 1% PY | 420 | | | 1.5' | Tr |
| 325.0 - 326.7 | Grano'd, 20% QTZ, med q-c alt'n, 4% coarse PY | 421 | | | 1.6' | Tr |
| 326.7 - 327.7 | Grano'd, dk greyish, med grained, minor QTZ, minor PY | 422 | | | 1.1' | .02 |
| 327.7 - 329.4 | Grano'd, med q-c alt'n, 20% QTZ, 3% PY, looks good | 423 | | | 1.7' | Tr |
| 329.4 - 330.1 | Grano'd, dk greyish, looks barren | 424 | | | 0.7' | .02 |
| 330.1 - 330.7 | Grano'd, a 1/2" QTZ vien, strong q-c alt'n, 2% coarse PY | 425 | | | 0.6' | .02 |
| 330.7 - 331.4 | Grano'd, dk greyish, fine grained, looks barren | 426 | | | 0.7' | .01 |
| 331.4 - 333.0 | Grano'd, strong q-c alt'n, 10% QTZ, 3% PY, looks good | 427 | | | 1.6' | .16 |
| 333.0 - 334.2 | Grano'd, dk greyish, 10% QTZ in stringers, 2% coarse PY | 428 | | | 1.2' | .01 |
| 334.2 - 335.5 | Grano'd, strong q-c alt'n, 20% QTZ, 5% PY at 335.2 several specs of V.G and a few specs of dissem. ZNS | 429 | | | 1.3' | { 0.317 0.27 0.28 } .287 |
| 335.5 - 336.5 | Grano'd, strong q-c alt'n with a 2" q-c vien at 336.0, carries one coarse spec of V.G, 2% coarse PY | 430 | | | 1.0' | { 0.37 0.28 0.30 } 0.317 |

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SIGNED 

DIAMOND DRILL RECORD WINDFALL OILS & MINES LTD.

HOLE NO. 80 -7 SHEET NO. 7

LATITUDE _____ DATUM _____ STARTED _____
 DEPARTURE _____ BEARING _____ COMPLETED _____
 ELEVATION _____ DIP _____ ULTIMATE DEPTH _____

| DEPTH FEET | FORMATION | SAMPLE NO. | FROM | TO | WIDTH | OZS Au |
|---------------|--|------------|------|----|-------|--------|
| 336.5 - 337.5 | Grano'd, med. q-c alt'n, 5% QTZ, 2% coarse PY | 431 | | | 1.0' | Tr |
| 337.5 - 339.0 | Grano'd, strong q-c alt'n, 7% coarse PY, looks good | 432 | | | 1.5' | .31 |
| 339.0 - 340.0 | Grano'd, strong q-c alt'n, 10% QTZ, 5% coarse PY, looks good | 433 | | | 1.0' | .13 |
| 340.0 - 341.3 | Grano'd, minor q-c alt'n, minor PY | 434 | | | 1.3' | .01 |
| 341.3 - 342.7 | Grano'd, med. q-c alt'n, 10% QTZ, 4% coarse PY, looks good | 435 | | | 1.4' | .02 |
| 342.7 - 344.0 | Grano'd, strong q-c alt'n, 5% QTZ, 3% Coarse PY | 436 | | | 1.3' | .02 |
| 344.0 - 346.0 | Grano'd, med q-c alt'n, 5% QTZ, 2% coarse PY | 437 | | | 2.0' | .01 |
| 346.0 - 348.0 | Grano'd, a wk q-c alt'n, 10% QTZ, 5% coarse PY | 438 | | | 2.0' | .01 |
| 348.0 - 349.1 | Grano'd, strong q-c alt'n, 10% QTZ, 5% coarse PY, looks good | 439 | | | 1.1' | .02 |
| 349.1 - 350.5 | Grano'd, wk q-c alt'n, 1% coarse PY | 440 | | | 1.4' | Tr |
| 350.5 - 352.5 | Grano'd, dk greyish, coarse grained, 2% PY, wk q-c alt'n | 441 | | | 2.0' | .02 |
| 352.5 - 353.5 | Grano'd, 40% QTZ in vienlets at 60 degrees to core, 2% coarse PY, looks good | 442 | | | 1.0' | Tr |
| 353.5 - 354.9 | Grano'd, dk greyish, minor QTZ, minor PY | 443 | | | 1.4' | Tr |
| 354.9 - 356.7 | Grano'd, dk greyish, fine grained, 5% QTZ, 1% PY | 444 | | | 1.8' | Tr |
| 356.7 - 361.7 | Grano'd, dk greyish, fine grained, looks barren | 445 | | | 5.0' | Tr |

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DIAMOND DRILL RECORD

WINDFALL OILS & MINES LTD.

HOLE NO. 80 - 7 SHEET NO. 8

LATITUDE _____ DATUM _____ STARTED _____
 DEPARTURE _____ BEARING _____ COMPLETED _____
 ELEVATION _____ DIP _____ ULTIMATE DEPTH _____

| DEPTH FEET | FORMATION | SAMPLE NO. | FROM | TO | WIDTH | OZS Au | |
|---------------|--|------------|------|----|-------|--------------------|------|
| 361.7 - 363.0 | Grano'd, strong q-c alt'n, 5% coarse PY | 446 | | | 1.3' | Tr | |
| 363.0 - 368.5 | Grano'd, dk greyish, fine grained, looks barren | 447 | | | 5.5' | Tr. | |
| 368.5 - 371.0 | Grano'd, med q-c alt'n, 10% QTZ, 3% PY | 448 | | | 2.5' | Tr. | |
| 371.0 - 372.0 | Grano'd, strong q-c alt'n, a 2" q-c vien at 55 degrees to core, 3% coarse PY | 449 | | | 1.0' | .01 | |
| 372.0 - 373.0 | Grano'd, a 2" q-c vien at 55 degrees to core, 3% coarse PY | 450 | | | 1.0' | .06 | |
| 373.0 - 374.3 | Grano'd, a 1/2" QTZ vienlet, minor PY | 451 | | | 1.3' | Tr, | |
| 374.3 - 376.0 | Grano'd, dk greyish, looks barren | 452 | | | 1.7' | Tr | |
| 376.0 - 377.7 | Grano'd, strong q-c alt'n, 4% coarse PY | 453 | | | 1.7' | Tr | |
| 377.7 - 379.0 | Grano'd, dk greyish, minor QTZ, minor PY | 454 | | | 1.3' | Tr | |
| 379.0 - 380.5 | Grano'd, strong q-c alt'n, 7% coarse PY cubes up to 1" diam., looks good | 455 | | | 1.5' | .02 | |
| 380.5 - 381.5 | Grano'd, strong q-c alt'n, 5% coarse PY cubes | 456 | | | 1.0' | Tr | |
| 381.5 - 385.5 | Grano'd, dk greyish, med. grained, looks barren | 457 | | | 4.0' | Tr | |
| 385.5 - 386.5 | Grano'd, med q-c alt'n, a 1/2" QTZ vien at 386.0 carries what may be one fine spec of V.G., 5% coarse PY | 458 | | | 1.0' | {.04 .04 Tr} | .026 |
| 386.5 - 390.5 | Grano'd, med grained, looks barren | 459 | | | 4.0' | Tr | |
| 390.5 - 391.9 | Grano'd, strong q-c alt'n, 5% QTZ, 3% PO(coarse) 2% coarse PY, a fine spec of V.G at 391.4 | 460 | | | 1.4' | {.03 tr tr} | .01 |

DRILLED BY [Signature]

SIGNED [Signature]

DIAMOND DRILL RECORD

WINDFALL OILS & MINES LTD.

HOLE NO. 80 - 7 SHEET NO. 9

LATITUDE _____ DATUM _____ STARTED _____

DEPARTURE _____ BEARING _____ COMPLETED _____

ELEVATION _____ DIP _____ ULTIMATE DEPTH _____

| DEPTH FEET | FORMATION | SAMPLE NO. | FROM | TO | WIDTH | OZS. Au |
|---------------|--|------------|------|----|-------|---------|
| 391.9 - 393.6 | Grano'd, dk greyish witha glassy 1" QTZ vienlet at 55 degrees to core, minor PY | 461 | | | 1.7' | Tr |
| 403.5 - 404.2 | Grano'd, a 1/2" QTZ vienlet at 40 degrees to core carries 5% PO and 1% PY | 462 | | | 0.7' | .07 |
| 405.2 - 406.0 | Grano'd, strong q-c alt'n, 5% QTZ, 3% coarse PY, 1% PY | 463 | | | 0.8' | Tr |
| 428.0 - 429.0 | Grano'd, 5% QTZ, minor PY | 464 | | | 1.0' | Tr |
| 429.0 - 486.0 | Waxy seracitic QTZ-por'y, contains 5% QTZ phenos, 1mm diam. and 5% feldspar pheno's | | | | | |
| 484.0 - 486.0 | QTZ-por'y, 30% QTZ sil'n, 1% PY | 465 | | | 2.0' | Tr |
| 486.0 - | END OF HOLE | | | | | |
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| | | | | | | |
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DRILLED BY _____

SIGNED *C. A. Kurylow*

HOLE No. 80 - 7

| Footage | Dip | Bearing | Azim | Footage | Horiz | Vert. |
|---------|-----|------------|-------------|------------|-------|-------|
| Collar | 60° | N-82°20' E | N - 80° - E | 0 - 100' | 50.0 | 86.6 |
| 200' | 58 | N-69 E | 73 | 100 - 300' | 106.0 | 169.6 |
| 400' | 56 | N-84 E | 88 | 300 - 486' | 104.1 | 154.2 |

DIAMOND DRILL RECORD

WINDFALL OILS & MINES LTD.

HOLE NO. 80 - 8 SHEET NO. 1

LATITUDE _____ DATUM _____ STARTED _____
 DEPARTURE _____ BEARING _____ COMPLETED _____
 ELEVATION _____ DIP _____ ULTIMATE DEPTH _____

| DEPTH FEET | FORMATION | SAMPLE NO. | FROM | TO | WIDTH | OZS. Au |
|-------------|---|------------|------|----|-------|---------|
| 0 - 20.0 | Casing in overburden | | | | | |
| 18.0 - 22.3 | Grano'd, greyish, a 1" and a 1/2" QTZ vienlets | 578 | | | 4.3' | Tr. |
| | that carries some PY and PO | | | | | |
| 22.3 - 23.0 | Grano'd, greyish, med. grained, a 1" QTZ vienlet | 579 | | | 0.7' | .02 |
| | at 60 degrees to core, 2% coarse PY | | | | | |
| 23.0 - 27.4 | Grano'd, greyish, minor QTZ, minor PY | 580 | | | 4.4' | Tr. |
| 27.4 - 28.8 | Gran'd, two 1" QTZ vienlets with some wall rock | 581 | | | 1.4' | Tr. |
| | alt'n that carries coarse crysta's of PY | | | | | |
| 32.0 - 32.6 | Grano'd, a 1" QTZ vienlet, minor PY | 582 | | | 0.6' | Tr. |
| 35.4 - 36.0 | Gran'd, a 1" QTZ vien, strong q-c alt'n, | 583 | | | 0.6' | Tr. |
| | 3% PY | | | | | |
| 39.3 - 40.5 | Gran'd, three 1" QTZ viens, strong green q-c | 584 | | | 1.2' | .02 |
| | wall rock alt'n, 3% PY, looks good | | | | | |
| 41.8 - 42.6 | Grano'd, two 1" QTZ viens with strong green wall | 585 | | | 0.8' | .08 |
| | rock alt'n that carries 3% PY | | | | | |
| 45.8 - 46.6 | Grano'd, a 2" QTZ vien at 50 degrees to core, | 586 | | | 0.8' | .02 |
| | minor PY | | | | | |
| 46.6 - 48.7 | Grano'd, looks barren | 587 | | | 2.1' | Tr. |
| 48.7 - 51.0 | Grano'd, strong q-c wall rock alt'n with several | 588 | | | 2.3' | .02 |
| | 1/2" to 1" QTZ viens, 7% coarse PY, 2% PO, green- | | | | | |
| | ish, looks good! | | | | | |

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DIAMOND DRILL RECORD

WINDFALL OILS & MINES LTD.

HOLE NO. 80 - 8 SHEET NO. 2

LATITUDE _____ DATUM _____ STARTED _____
 DEPARTURE _____ BEARING _____ COMPLETED _____
 ELEVATION _____ DIP _____ ULTIMATE DEPTH _____

| DEPTH FEET | FORMATION | SAMPLE NO. | FROM | TO | WIDTH | OZS. Au |
|---------------|---|------------|------|----|-------|---------|
| 51.0 - 52.7 | Grano'd, a 5" glassy QTZ vien, 1% PY | 589 | | | 1.7' | .01 |
| 52.7 - 54.4 | Grano'd, greyish, looks barren | 590 | | | 1.7' | Tr |
| 54.4 - 55.8 | Grano'd, strong green q-c alt'n, 3% coarse PY | 591 | | | 1.4' | .07 |
| 55.3 - 57.5 | Grano'd, dk greyish, minor PY | 592 | | | 1.7' | Tr |
| 57.5 - 58.3 | Grano'd, 1/2" q-c vienlet, strong q-c alt'n, 1% PY and 1% PO | 593 | | | 0.8' | .02 |
| 61.0 - 61.8 | Grano'd, 40% QTZ in vienlets, strong q-c wall rock alt'n, 7% massive PY, looks good | 594 | | | 0.8' | .03 |
| 66.0 - 67.2 | Grano'd, two 1/2" QTZ vienlets, 1% coarse PY | 595 | | | 1.2' | .02 |
| 69.0 - 70.7 | Grano'd, a 1 1/2" and a 1/2" QTZ vienlet at 50 de- grees to core, med q-c wall rock, 3% PY, looks good. | 596 | | | 1.7' | .05 |
| 75.5 - 76.0 | Grano'd, a 1" QTZ vien, 1% coarse PY | 597 | | | 0.5' | .04 |
| 81.5 - 82.3 | Grano'd, two 1" QTZ viens, 1% PY | 598 | | | 0.8' | .03 |
| 85.0 - 86.0 | Grano'd, a 2" and 3" glassy QTZ vien, 1% PY, 1% PO | 599 | | | 1.0' | .03 |
| 90.0 - 90.5 | Grano'd, a 5" glassy QTZ vien, minor PY | 600 | | | 0.5' | .03 |
| 96.5 - 98.0 | Grano'd, two 1" QTZ viens, 1/2% PY, 1/2% PO | 601 | | | 1.5' | .02 |
| 101.6 - 102.6 | Grano'd, two 1/4" QTZ vienlets, 2% PO | 602 | | | 1.0' | .01 |
| 104.8 - 106.0 | Grano'd, a 1" QTZ vien, med q-c alt'n, 1% PY | 603 | | | 1.2' | Tr |
| 116.0 - 118.2 | Grano'd, a 1" and a 1/2" QTZ vienlet, 1% PY | 604 | | | 2.2' | .01 |

DIAMOND DRILL RECORD

WINDFALL OILS & MINES LTD.

HOLE NO. 80 - 8 SHEET NO. 3

LATITUDE _____ DATUM _____ STARTED _____
 DEPARTURE _____ BEARING _____ COMPLETED _____
 ELEVATION _____ DIP _____ ULTIMATE DEPTH _____

| DEPTH FEET | FORMATION | SAMPLE NO. | FROM | TO | WIDTH | OZS. Au | |
|---------------|---|------------|------|----|-------|---------------------------|-------|
| 121.2 - 121.8 | Grano'd, a 1" QTZ vien at 45 degrees to core, 1% PY | 605 | | | 0.6' | Tr | |
| 123.8 - 124.4 | Grano'd, a 1" and 1/2" QTZ vien, 1/2% PY | 606 | | | 0.6' | Tr | |
| 131.2 - 133.3 | Grano'd, Two 1/2" q-c viens, weak q-c alt'n, 2% PY | 607 | | | 2.1' | .07 | |
| 143.0 - 144.7 | Grano'd, strong q-c alt'n, 4% coarse PY, a 2" glassy QTZ vien at 143.6 and a 1" grey QTZ vien at 144.5 which carries a spec of V.G | 608 | | | 1.7' | { .08 .08 .09 | .083 |
| 148.0 - 156.0 | Lost core | | | | | | |
| 158.1 - 158.6 | Grano'd, strong q-c alt'n, 3% massive PY | 609 | | | 0.5' | Tr | |
| 163.0 - 165.0 | Grano'd, greyish (dark), looks barren | 610 | | | 2.0' | Tr | |
| 165.0 - 165.6 | Grano'd, a 1" QTZ vien at 55 degrees to core, it carries at least 50 fine specs of V.G along each wall contact of the QTZ vienlet. A 1/4" wide band of heavy PY mineralization occurs along the wall rock at the vien contact | 611 | | | 0.6' | { 8.03 8.13 8.21 | 8.123 |
| 165.6 - 167.0 | Grano'd, dk greyish, fine grained, looks barren | 612 | | | 1.4' | Tr | |
| 172.5 - 173.0 | Grano'd, a 2" QTZ vien with 2% PY in wall rock | 613 | | | 0.5' | 0.7 | |
| 175.0 - 177.0 | Grano'd, dk greyish, fine grained, minor QTZ, | 614 | | | 2.0' | Tr | |

[Handwritten Signature]

DIAMOND DRILL RECORD WINDFALL OILS & MINES LTD.

HOLE NO. 80 - 8 SHEET NO. 4

LATITUDE _____ DATUM _____ STARTED _____
 DEPARTURE _____ BEARING _____ COMPLETED _____
 ELEVATION _____ DIP _____ ULTIMATE DEPTH _____

| DEPTH FEET | FORMATION | SAMPLE NO | FROM | TO | WIDTH | OZS Au |
|-----------------|--|-----------|------|----|-------|--------|
| | 2% dissem. PY | | | | | |
| 181.5 - 182.9 | Grano'd, strong greenish q-c alt'n, 3% coarse PY 2% PO, minor QTZ | 615 | | | 1.4' | .03 |
| 183.6 - 185.1 | Grano'd, two 1/2" QTZ vienlets, 1% PY | 616 | | | 1.5 | Tr |
| <u>Geology:</u> | | | | | | |
| 18.0 - 190.0 | Grano'd, dk greyish, fine grained to med. grained with some QTZ vienlets running at 50 degrees to 60 degrees to core axis, some of these vienlets carry <u>V.G</u> with abundant fine <u>V.G</u> along both walls of a 1" QTZ filled fracture at 165.3' | | | | | |
| 190.0 - 214.0 | Andesitic Tuff, the grano'd contact runs at 15 degrees to core axis, the tuff is finely banded and fractured, with considerable hematitic alt'n. This section represents a highly fractured fault zone. Lost core from 206.0 - 210.0 very blocky ground. | | | | | |
| 214.0 - 363.0 | Grano'd, greenish grey, fine grained, highly blocky to 220.0, with lost core from 215 - 218.0, From 214.0 - 257.0 the QTZ fractures carry hematite in wall rock adjoining QTZ vienlets. | | | | | |

ELK

DIAMOND DRILL RECORD

WINDFALL OILS & MINES LTD.

HOLE NO. 80 - 8 SHEET NO. 5

LATITUDE _____ DATUM _____ STARTED _____

DEPARTURE _____ BEARING _____ COMPLETED _____

ELEVATION _____ DIP _____ ULTIMATE DEPTH _____

| DEPTH FEET | FORMATION | SAMPLE NO. | FROM | TO | WIDTH | OZ% Au | |
|---------------|---|------------|------|----|-------|---------------------|------|
| 213.3 - 214.0 | Grano'd, 2" QTZ vienlet with 1% coarse PY | 617 | | | 0.7' | .07 | |
| 231.0 - 231.7 | Grano'd, 1" QTZ vienlet at 50 degrees to core minor PY | 618 | | | 0.7' | .08 | |
| 231.7 - 234.2 | Grano'd, dk greyish, looks barren | 619 | | | 2.5' | .01 | |
| 234.2 - 234.7 | Grano'd, a 1/2" QTZ vien, rusty wall rock, minor PY | 620 | | | 0.5 | Tr | |
| 234.7 - 236.0 | Grano'd, dk greyish, looks barren | 621 | | | 1.3' | Tr | |
| 236.0 - 236.6 | Grano'd, a 1/2" QTZ vienlet at 60 degrees to core with 1" each side of strong hematitic wall rock alt'n, 5% coarse PY, several specs of fine V.G. at contact of vienlet at 236.3 | 622 | | | 0.6' | {.71 .74 .73} | .726 |
| 236.6 - 240.0 | Grano'd, dk greyish, looks barren | 623 | | | 0.4' | Tr | |
| 240.0 - 243.2 | Grano'd, three 1/4" QTZ vienlets with 1/2" hem- atitic wall rock alt'n carrying 2% PY | 624 | | | 3.2' | Tr | |
| 247.6 - 248.2 | Grano'd, a 1 1/2" QTZ vienlet with 1% PY | 625 | | | 0.6' | Tr | |
| 248.2 - 250.5 | Grano'd, dk greyish, looks barren | 626 | | | 2.3' | Tr | |
| 250.5 - 251.1 | Grano'd, a 1/3" q-c vienlet with one fine spec. of V.G. at 250.8 | 627 | | | 0.6 | {.04 .04 .03} | .036 |
| 251.1 - 255.5 | Grano'd, dk greyish, looks barren | 628 | | | 4.4 | Tr | |
| 255.5 - 256.1 | Grano'd, a 1/2" QTZ vienlet with hematitic wall rock alt'n, 1/2% PY | 629 | | | 0.6 | Tr | |

GAH

DIAMOND DRILL RECORD

WINDFALL OILS & MINES LTD.

HOLE NO. 80 - 8 SHEET NO. 6

LATITUDE _____ DATUM _____ STARTED _____
 DEPARTURE _____ BEARING _____ COMPLETED _____
 ELEVATION _____ DIP _____ ULTIMATE DEPTH _____

| DEPTH FEET | FORMATION | SAMPLE NO. | FROM | TO | WIDTH | OZS Au | |
|---------------|--|------------|------|----|-------|----------------------|------|
| 267.4 - 268.7 | Grano'd, three 1/4" QTZ vienlets, 1% PY | 630 | | | 1.3' | Tr | |
| 270.4 - 271.8 | Grano'd, dk grayish, two 1" QTZ vienlets, 3% PY | 631 | | | 1.4' | Tr | |
| 278.9 - 279.7 | Grano'd, a 1/2" and a 1/4" QTZ vienlet, 1/2% PY | 632 | | | 0.8' | Tr | |
| 286.0 - 288.2 | Grano'd, Two of 2" QTZ vienlets, 1% PY | 633 | | | 2.2' | .01 | |
| 288.2 - 290.2 | Grano'd, four 1/4" QTZ vienlets, 1/2% PY | 634 | | | 2.0' | Tr | |
| 295.0 - 295.7 | Grano'd, a 1" QTZ vienlet at 50 degrees to core, 2% PY in wall rock | 635 | | | 0.7' | .01 | |
| 306.0 - 306.6 | Grano'd, a 2" QTZ vienlet, 1/2% PY in wall rock | 636 | | | 0.6' | .02 | |
| 306.6 - 310.0 | Grano'd, dk greyish, minor QTZ, minor PY | 637 | | | 3.4' | Tr | |
| 310.0 - 310.7 | Grano'd, a 4" QTZ vien, 1/2% PY in wall rock | 638 | | | 0.7' | .03 | |
| 315.5 - 316.0 | Lost core | | | | | | |
| 321.5 - 322.0 | Grano'd, strong q-c alt'n, 3% coarse PY, looks good | 648 | | | 0.5' | .12 | |
| 322.0 - 325.4 | Grano'd, minor q-c alt'n, 1% PY | 649 | | | 3.4' | .01 | |
| 327.0 - 328.5 | Grano'd, med. q-c alt'n, 2% P0 | 650 | | | 1.5' | .01 | |
| 333.3 - 333.9 | Grano'd, a 1" QTZ vien at 50 degrees to core with a 1/4" streak of massive sulphide consisting of PY and P0 and several fine specs of <u>V.G</u> at 333.6 | 651 | | | 0.6' | 0.72 0.89 0.85 | 0.82 |

GAH

DIAMOND DRILL RECORD

WINDFALL OILS & MINES LTD.

HOLE NO. 80 -8 SHEET NO. 7

LATITUDE _____ DATUM _____ STARTED _____
 DEPARTURE _____ BEARING _____ COMPLETED _____
 ELEVATION _____ DIP _____ ULTIMATE DEPTH _____

| DEPTH FEET | FORMATION | SAMPLE NO. | FROM | TO | WIDTH | OZS Au |
|---------------|--|------------|------|----|-------|--------|
| 341.5 - 342.3 | Grano'd, a 6" glassy QTZ vien at 40 degrees to core, minor PY | 652 | | | 0.8' | .01 |
| 344.0 - 344.6 | Grano'd, a 2" QTZ vien at 45 degrees to core, minor PY | 653 | | | 0.6' | .01 |
| 348.8 - 351.5 | Grano'd, minor QTZ, minor PY | 654 | | | 2.7' | Tr |
| 351.5 - 353.2 | Grano'd, strong q-c alt'n with narrow carb. vien-lets, 5% coarse PY | 655 | | | 1.7' | .01 |
| 353.2 - 354.4 | Grano'd, strong q-c alt'n, 3% PY | 656 | | | 1.2' | .04 |
| 357.4 - 359.4 | Grano'd, minor QTZ, 1% PY | 657 | | | 2.0' | Tr |
| 363.0 - 403.3 | QTZ-por'y dyke, highly sericitic, waxy appearance geology: with numerous QTZ and some feldspar pheno-crysts | | | | | |
| 403.3 - 418.0 | QTZ- diorite, a dk greenish gabbroic rock, high in amphibole, and fine magnetite but carries about 10% deep blue QTZ-pheno-crysts up to 2mm in diam. | | | | | |
| 411.5 - 413.0 | QTZ-diorite, 5% QTZ in fractures, 1/2% PY | 658 | | | 1.5' | Tr |
| 418.0 | END OF HOLE | | | | | |

DRILLED BY *Kenneth Semionov Drilling*

[Handwritten Signature]

HOLE 80 - 8

| Footage | Dip | Bearing | Azim. | Footage | Horiz. | Vert. |
|---------|-------|---------|--------|----------|--------|-------|
| Collar | - 60° | N-79½ E | | 0-150' | 75 | 129.9 |
| 300' | - 57° | N-71° E | N-75°E | 150-418' | 146.0 | 224.8 |

DIAMOND DRILL RECORD

WINDFALL OILS & MINES LTD.

HOLE NO. 80 - 9 SHEET NO. 1


LATITUDE 13232.38
 DEPARTURE 11466.42
 ELEVATION _____

AXT. CORE
 DATUM *Stored in office Windfall*
 BEARING N 79°30' 10" E
 DIP = 59°00' 32"

STARTED July 21, 1980
 COMPLETED July 29, 1980
 ULTIMATE DEPTH 474.0'

| DEPTH FEET | FORMATION | SAMPLE NO | FROM | TO | WIDTH | OZS Au | |
|--------------|--|-----------|------|----|-------|----------------------|------|
| 0 - 19.0 | Casing in overburden | | | | | | |
| 19.0 - 175.0 | Granodioritem dark greyish, fine to medium grained, occasional QTZ filled fractures running at 55 degrees to core, with a flatter set of fractures running at 40 degrees to core | | | | | | |
| 20.5 - 23.2 | Grano'd, several 1/4" QTZ vienlets, 1% fine PY | 659 | | | 2.7' | .02 | |
| 25.7 - 26.4 | Grano'd, a 2" QTZ vienlet at 55 degrees to core with some alt'n at 40 degrees to core, 1% fine PY | 660 | | | 0.7' | Tr | |
| 31.0 - 31.7 | Grano'd, a 1 1/2" QTZ vienlet at 55 degrees to core, minor PY | 661 | | | 0.7' | Tr | |
| 35.0 - 36.2 | Grano'd, three 1/4" QTZ stringers, 1% fine PY | 662 | | | 1.2' | Tr | |
| 38.7 - 40.2 | Grano'd, a 4" q-c vienlet, 1% PY | 663 | | | 1.5' | Tr | |
| 43.0 - 43.5 | Grano'd, a 1/4" QTZ vienlet, 1% PY | 664 | | | 0.5 | .08 | |
| 47.5 - 48.2 | Grano'd, two 1/4" QTZ stringers, 1/2% PY | 665 | | | 0.7' | Tr | |
| 80.3 - 80.9 | Grano'd, a 1" QTZ vien at 45 degrees to core, with a 3mm spot which carries about 15 specs of <u>v.g.</u> with traces of <u>altaite</u> and 1% PY | 669 | | | 0.6' | 0.24 0.20 0.22 | 0.22 |
| 93.0 - 93.5 | Grano'd, a 1/2" QTZ vien at 45 degrees to core, minor PY | 670 | | | 0.5' | 0.11 | |
| 98.4 - 99.0 | Grano'd, a 2" QTZ vien at 45 degrees to core, | 671 | | | 0.6' | 0.03 | |

DRILLED BY *[Signature]*

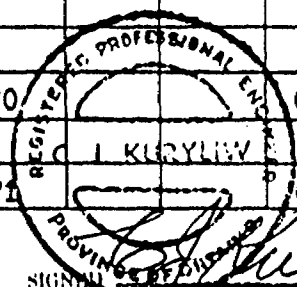

SIGNATURE

DIAMOND DRILL RECORD

WINDFALL OILS & MINES LTD.

HOLE NO. 80 - 9 SHEET NO. 2

LATITUDE _____ DATUM _____ STARTED _____
 DEPARTURE _____ BEARING _____ COMPLETED _____
 ELEVATION _____ DIP _____ ULTIMATE DEPTH _____

| DEPTH FEET | FORMATION | SAMPLE NO. | FROM | TO | WIDTH | OZS Au | |
|---------------|--|------------|------|----|-------|--------------------------|------|
| | 2% PY, minor QTZ-carb wall rock alt'n | | | | | | |
| 112.6 - 115.0 | Grano'd, 5% QTZ in irregular patches, 1/2% PY | 672 | | | 2.4' | 0.18 | |
| 115.0 - 117.0 | Grano'd, greyish fine grained, looks barren | 673 | | | 2.0' | Tr | |
| 117.0 - 117.6 | Grano'd, a 1/8" QTZ vienlet at 45 degrees to core, carries heavy PY and a spot with several specs of V.G at 117.4 | 674 | | | 0.6' | { 0.14 0.14 0.13 } | 0.14 |
| 117.7 - 119.3 | Grano'd, dark greyish, a 1/4" QTZ-carb vienlet, 1/2% PY | 675 | | | 1.6' | Tr | |
| 119.3 - 120.3 | Grano'd, a 6" QTZ vien at 50 degrees to core, carries a spot at each contact with several specs of V.G. each, at 119.5 and at 120.0. | 676 | | | 1.0 | { 0.03 0.04 0.04 } | 0.04 |
| 120.3 - 124.3 | Grano'd, dk greyish, fine grained, looks barren | 677 | | | 4.0' | Tr | |
| 124.3 - 125.0 | Grano'd, a 1" q-c vienlet with wall rock alt'n carries several specs of V.G. in a spot at the border of the vienlet at 124.7 | 678 | | | 0.7' | { 0.11 0.14 0.13 } | 0.13 |
| 125.0 - 128.0 | Grano'd, looks barren | 679 | | | 3.0' | Tr | |
| 128.0 - 128.5 | Grano'd, a 1/2" QTZ vienlet at 55 degrees to core, carries a spot with several specs of V.G. at 128.2 | 680 | | | 0.5' | { 0.60 0.64 0.57 } | 0.60 |
| 128.5 - 134.6 | Grano'd, dk greyish, fine grained, minor QTZ, minor PY | 681 | | | 6.1 | Tr | |

DIAMOND DRILL RECORD

WINDFALL OILS & MINES LTD.

HOLE NO. 80 - 9 SHEET NO. 3

LATITUDE _____ DATUM _____ STARTED _____

DEPARTURE _____ BEARING _____ COMPLETED _____

ELEVATION _____ DIP _____ ULTIMATE DEPTH _____

| DEPTH FEET | FORMATION | SAMPLE NO. | FROM | TO | WIDTH | OZS Au | |
|---------------|---|------------|------|----|-------|--------------------------|------|
| 134.6 - 136.2 | Grano'd, a 2" and 1" QTZ vienlet with some oxidation of wall rock | 682 | | | 1.6' | .03 | |
| 143.6 - 144.7 | Grano'd, a 2" and a 1" QTZ vienlet at 50 degrees to core, 2% PY | 683 | | | 1.1' | Tr | |
| 156.5 - 157.5 | Grano'd, a 5" QTZ vienlet with 2% massive PY, and traces of ZNS, looks good | 684 | | | 1.0' | .02 | |
| 162.8 - 163.3 | Grano'd, two 1/4" QTZ vienlets, 3% PY | 685 | | | 0.5' | .03 | |
| 165.0 - 166.0 | Grano'd, strong q-c alt'n, 2% PY | 686 | | | 1.0' | Tr | |
| 170.0 - 171.0 | Grano'd, a 2" and a 1" QTZ vien, 2% PY, 1% PY | 687 | | | 1.0' | .04 | |
| 171.0 - 175.0 | Grano'd, a 1/4" QTZ vienlet, minor PY | 688 | | | 4.0' | Tr | |
| 175.0 - 175.6 | Grano'd, 3/4" QTZ vienlet with hematitic wall rock alt'n and several specs of V.G. in one spot at 175.3 | 689 | | | 0.6' | { 1.50 1.38 1.63 } | 1.50 |
| 175.6 - 178.5 | Grano'd, minor hematitic alt'n, minor PY | 690 | | | 2.9' | Tr | |
| 178.5 - 181.7 | Grano'd, greyish, med. grained, looks barren | 691 | | | 3.2 | Tr | |
| 181.7 - 182.7 | Grano'd, a 7" QTZ vienlet at 55 degrees to core, some hematitic wall rock alt'n | 692 | | | 1.0' | Tr | |
| 175.0 - 265.0 | Grano'd, fine grained to med. grained. This is a blocky, late fault zone with hematitic wall rock altn of QTZ filled fractures, the badly | | | | | | |

CRK

DIAMOND DRILL RECORD

WINDFALL OILS & MINES LTD.

HOLE NO. 80 - 9 SHEET NO. 4

LATITUDE _____ DATUM _____ STARTED _____

DEPARTURE _____ BEARING _____ COMPLETED _____

ELEVATION _____ DIP _____ ULTIMATE DEPTH _____

| DEPTH FEET | FORMATION | SAMPLE NO. | FROM | TO | WIDTH | OZS. Au | |
|---------------|---|------------|------|----|-------|------------------------|------|
| | oxidized blocky zone extends from 184.0 - 214.0 | | | | | | |
| | with some lost core from 187.0 - 192.0, lost | | | | | | |
| | core from 219.0 - 221.0. | | | | | | |
| 265.0 - 389.3 | Grano'd, med. to coarse grained, greyish, hem- atitic alt'n is absent. | | | | | | |
| 196.0 - 196.6 | Grano'd, a 1/2" QTZ vienlet, 1% PY | 693 | | | 0.6' | Tr | |
| 203.0 - 204.2 | Grano'd, a 6" QTZ vien with 2% coarse PY in wall rock alt'n. | 694 | | | 1.2' | .03 | |
| 208.8 - 209.5 | Grano'd, a 1" QTZ vien with green q-c wall rock alt'n, 2% PY | 695 | | | 0.7' | Tr | |
| 211.3 - 213.1 | Grano'd, two 1/4" QTZ stringers with some wall rock alt'n, hematite and PY | 696 | | | 1.8' | Tr | |
| 217.5 - 218.7 | Grano'd, a 3" QTZ vien at 60 degrees to core 2% coarse PY in wall rock | 697 | | | 1.2' | .01 | |
| 222.7 - 223.2 | Grano'd, a 1" QTZ vien with 2% hematitic PY in wall rock | 698 | | | 0.5' | .02 | |
| 223.1 - 225.6 | Grano'd, minor QTZ, 1% PY | 699 | | | 2.4' | Tr | |
| 225.6 - 226.2 | Grano'd, a 1/2" QTZ vienlet at 60 degrees to core, it carries 2% coarse PY and a spec of V.G at 226.0 | 700 | | | 0.6 | {0.04 0.02 0.05} | 0.04 |

6/7/8

DIAMOND DRILL RECORD

WINDFALL OILS & MINES LTD.

HOLE NO. 80 - 9 SHEET NO. 5

LATITUDE _____ DATUM _____ STARTED _____
 DEPARTURE _____ BEARING _____ COMPLETED _____
 ELEVATION _____ DIP _____ ULTIMATE DEPTH _____

| DEPTH FEET | FORMATION | SAMPLE NO. | FROM | TO | WIDTH | OZS Au |
|---------------|--|------------|------|----|-------|--------|
| 228.6 - 230.0 | Grano'd, two 1/2" QTZ vienlets, 1/2% PY | 701 | | | 1.4' | Tr |
| 231.0 - 231.7 | Grano'd, a 1" QTZ vienlet, 2% PY | 702 | | | 0.7' | Tr |
| 231.7 - 233.7 | Grano'd, two 1/4" QTZ stringers, 2% PY | 703 | | | 2.0' | Tr |
| 236.5 - 237.0 | Grano'd, a 3/4" QTZ vienlet, 7% coarse PY | 704 | | | 0.5' | .05 |
| 237.0 - 239.5 | Grano'd, several 1/4" and 1" QTZ vienlets, 1% PY | 705 | | | 2.5' | Tr |
| 241.0 - 245.0 | Grano'd, med q-c alt'n several 1/4" q-c stringers, 2% coarse PY | 706 | | | 4.0' | .01 |
| 247.0 - 250.0 | Grano'd, strong q-c alt'n, 5% PY | 707 | | | 3.0' | .02 |
| 250.0 - 251.3 | Grano'd, a 6" QTZ vienlet with 2% coarse PY in wall rock | 708 | | | 1.3' | Tr |
| 254.0 - 258.4 | Grano'd, three 1/4" QTZ vienlets, 1% PY | 709 | | | 4.4' | Tr |
| 258.4 - 259.0 | Grano'd, a 1/2" QTZ vienlet with strong wall rock alt'n, 3% PY | 710 | | | 0.6' | Tr |
| 259.7 - 260.3 | Grano'd, a 1" QTZ vienlet, 2% coarse PY in wall rock | 711 | | | 0.6' | Tr |
| 260.6 - 261.5 | Grano'd, four 1/2" QTZ vienlets with some coarse PY | 712 | | | 0.9' | .01 |
| 264.5 - 265.0 | Grano'd, 1" QTZ vienlet with 2% PY in wall rock alt'n | 713 | | | 0.5' | .01 |
| 267.0 - 268.5 | Grano'd, two 1/2" QTZ vienlets at 65 degrees to core, 3% coarse PY in wall rock alt'n | 714 | | | 1.5' | .07 |

GAH

DIAMOND DRILL RECORD

WINDFALL OILS & MINES LTD.

HOLE NO. 80 - 9 SHEET NO. 6

LATITUDE _____ DATUM _____ STARTED _____
 DEPARTURE _____ BEARING _____ COMPLETED _____
 ELEVATION _____ DIP _____ ULTIMATE DEPTH _____

| DEPTH FEET | FORMATION | SAMPLE NO. | FROM | TO | WIDTH | OZS Au |
|---------------|--|------------|------|----|-------|--------|
| 272.2 - 273.2 | Grano'd, one 2" and a three 1/2" QTZ vienlets 2% coarse PY in wall rock | 715 | | | 1.0' | .03 |
| 273.2 - 277.2 | Grano'd, three 1/4" QTZ vienlets, 1/2% PY | 716 | | | 4.0' | .07 |
| 278.8 - 280.7 | Grano'd, a 1" QTZ vien, minor PY | 717 | | | 1.9' | .02 |
| 284.0 - 284.6 | Grano'd, a 2" QTZ vien at 50 degrees to core, 2% coarse PY | 724 | | | 0.6 | .01 |
| 287.7 - 288.4 | Grano'd, a 2" and two 1/4" QTZ vienlets at 55 degrees to core, 1% coarse PY | 725 | | | 0.7' | Tr |
| 290.2 - 291.3 | Grano'd, two 1/2" QTZ vienlets, 1% PY | 726 | | | 1.1' | Tr |
| 293.7 - 294.3 | Grano'd, a 1" QTZ vienlet, 1% coarse PY | 727 | | | 0.6' | 0.12 |
| 295.5 - 296.4 | Grano'd, a 1" and two 1/4" QTZ vienlets, 2% c coarse PY, looks good | 728 | | | 0.9' | 0.05 |
| 302.0 - 302.8 | Grano'd, three 1/4" qtz vienlets, 1% coarse PY | 729 | | | 0.8' | 0.02 |
| 302.8 - 303.3 | Grano'd, a 1" and a 1/2" QTZ vien, 2% PY, and a spec of V.G. at 303.0 | 730 | | | 0.5' | 1.59 |
| 303.3 - 303.9 | Grano'd, a 1" QTZ vienlet, 2% coarse PY | 731 | | | 0.6' | 0.36 |
| 303.9 - 305.6 | Grano'd, a 1" QTZ vien and a 1/4" massive PY vien | 732 | | | 1.7 | 0.07 |
| 317.6 - 318.9 | Grano'd, two 3" QTZ viens at 55 degrees to core at 318.0', 2% PY | 733 | | | 1.3' | 0.01 |
| 321.3 - 322.8 | Grano'd, two 1/4" QTZ vienlets, minor PY | 734 | | | 1.5' | Tr |

GA

DIAMOND DRILL RECORD

WINDFALL OILS & MINES LTD.

HOLE NO. 80 - 9. SHEET NO. 7

LATITUDE DATUM STARTED

DEPARTURE BEARING COMPLETED

ELEVATION DIP ULTIMATE DEPTH

| DEPTH FEET | FORMATION | SAMPLE NO | FROM | TO | WIDTH | OZS Au |
|---------------|--|-----------|------|----|-------|--------|
| 326.4 - 328.0 | Grano'd, a three inch and a 1" QTZ vien, 2% coarse PY | 735 | | | 1.6' | Tr |
| 328.0 - 331.0 | Grano'd, dk greyish, looks barren | 736 | | | 3.0' | Tr |
| 331.0 - 331.9 | Grano'd, a 2" QTZ vien, 2% PY, a trace of ZNS, and 4 specs of fine V.G. at 331.5 | 737 | | | 0.9' | Tr |
| 331.9 - 334.2 | Grano'd, looks barren | 738 | | | 2.3' | Tr |
| 334.2 - 336.7 | Grano'd, several 1/4" QTZ stringers, 3% PY | 739 | | | 2.5' | Tr |
| 338.8 - 340.7 | Grano'd, a 10" glassy QTZ vien, some coarse PY in wall rock | 740 | | | 1.9' | Tr |
| 341.5 - 343.7 | Grano'd, three 1/4" QTZ stringers, one with massive PY | 741 | | | 2.2' | Tr |
| 346.5 - 347.7 | Grano'd, a 5" glassy QTZ vien with 2% PY in wall rock | 742 | | | 1.2' | Tr |
| 347.7 - 350.1 | Grano'd, minor QTZ, 1% PY | 743 | | | 2.4' | .03 |
| 350.1 - 352.7 | Grano'd, minor q-c alt'n, 1% PY | 744 | | | 2.6' | .03 |
| 352.7 - 354.7 | Grano'd, four 1/2" QTZ vienlets, with some coarse PY | 745 | | | 2.0' | .05 |
| 354.7 - 356.6 | Grano'd, dk greyish, minor QTZ-carb. alt'n, minor PY | 746 | | | 1.9' | .13 |
| 357.0 - 358.2 | Grano'd, a 3" glassy QTZ vien at 50 degrees to core, 3% coarse PY in wall rock | 747 | | | 1.2' | Tr. |

GHK

DIAMOND DRILL RECORD

WINDFALL OILS & MINES LTD.

HOLE NO. 80 - 9 SHEET NO. 8

LATITUDE _____ DATUM _____ STARTED _____
 DEPARTURE _____ BEARING _____ COMPLETED _____
 ELEVATION _____ DIP _____ ULTIMATE DEPTH _____

| DEPTH FEET, | FORMATION | SAMPLE NO | FROM | TO | WIDTH | OZS Au | |
|---------------|--|-----------|------|----|-------|--------|--|
| 358.2 - 361.2 | Grano'd, two 1/4" QTZ stringers, 1/2% PY | 748 | | | 3.0' | Tr. | |
| 361.2 - 361.8 | Grano'd, a 1" QTZ vien at 40 degrees to core, one fine spec of V.G. at 361.5 | 749 | | | 0.6' | .02 | |
| 361.8 - 364.0 | Grano'd, three 1/2" QTZ vienlets, 1% PY | 750 | | | 2.2' | .02 | |
| 364.0 - 365.6 | Grano'd, a 1" carb. vienlet with 1" diam mas- sive PY blebs along the vienlet | 751 | | | 1.6' | .04 | |
| 365.6 - 368.8 | Grano'd, two 1/4" QTZ vienlets, 1/2% PY | 752 | | | 3.2' | Tr. | |
| 368.8 - 372.0 | Grano'd, minor QTZ, minor PY | 753 | | | 3.2' | Tr. | |
| 372.0 - 373.6 | Grano'd, three 1/4" vienlets, 1/2% PY | 754 | | | 1.6' | .03 | |
| 373.6 - 376.0 | Grano'd, three 1/4" QTZ vienlets, 1/2% PY | 755 | | | 2.4' | Tr | |
| 391.6 - 392.2 | Sericitic QTZ - por'y with some silicification and 1/4" massive PY vienlet | | | | | | |
| 389.3 - 415.0 | Sericitic, waxy QTZ-por'y dyke, 5% QTZ pheno- crysts, 1mm in diameter. | | | | | | |
| 414.0 - 415.5 | silicified contact zone between porphyry and granodiorite, 1/2% PY | 757 | | | 1.5' | Tr. | |
| 418.0 - 418.7 | Grano'd, a 1/2" QTZ vienlet at 60 degrees to core, 1/2% PY | 758 | | | 0.7' | Tr. | |
| 420.6 - 422.2 | Grano'd, strong q-c alt'n, 2% coarse PY | 759 | | | 1.6' | .01 | |

DRILLED BY Richard D. ...

SIGNED GJK

HOLE 80 - 9

| Footage | Dip | Bearing | Azim | Footage | Horiz. | Vert. |
|---------|-------|----------|----------|--------------|--------|-------|
| Collar | - 60° | N 79½ E | | 0 - 150' | 75' | 129.9 |
| 300' | -56° | N - 79°E | N - 83°E | 150' - 674.0 | 181.1 | 268.6 |

DIAMOND DRILL RECORD

WINDFALL OILS & MINES LTD.

HOLE NO. 80 - 25 SHEET NO. 2

LATITUDE _____ DATUM _____ STARTED _____
 DEPARTURE _____ BEARING _____ COMPLETED _____
 ELEVATION _____ DIP _____ ULTIMATE DEPTH _____

| DEPTH FEET | FORMATION | SAMPLE NO | FROM | TO | WIDTH | OZS. Au |
|-------------|--|-----------|------|----|-------|---------|
| 188.3-189.3 | Grano'd. A 6" glassy Qtz. vein with 2% Py. along edges. | 2313 | | | 1.0 | .01 |
| 191.2-192.2 | Grano'd. A 1/2" and a 1/4" Qtz. veinlet, at 60° to core. A coarse speck of V.G. at 192.0 on the edge of the 1/2" vein. | 2314 | | | 1.0 | .69 |
| 195.0-195.6 | Grano'd. A 1 1/2" Qtz. vein, 2% Py. 2% PO. | 2315 | | | .6 | .06 |
| 203.0-203.6 | Grano'd. weak Q.C. alt'n. 3% Py. | 2316 | | | .6 | .05 |
| 208.0-208.6 | Grano'd. weak Q.C. alt'n. 3% Py. | 2317 | | | .6 | .07 |
| 214.0-214.5 | Grano'd. A 1" Qtz. vein at 60° to core. 1% Py. | 2318 | | | .5 | .03 |
| 217.7-218.7 | Grano'd. A 1" Qtz. vein, 2% Py. | 2319 | | | 1.0 | .01 |
| 228.0-228.5 | Grano'd. A 1/2" Qtz. vein, 2% Py. | 2320 | | | .5 | Tr. |
| 235.5-236.1 | Grano'd. A 1/2" Qtz. Carb. vein, 2% Py. | 2321 | | | .6 | Tr. |
| 245.0-246.0 | Grano'd. Two 1/4" Qtz. veinlets, minor Py. | 2322 | | | 1.0 | Tr. |
| 247.2-248.2 | Grano'd. Two 1/4" Qtz. veinlets, minor Py. | 2323 | | | 1.0 | Tr. |
| 249.6-250.3 | Grano'd. A 3" Qtz. vein, 3% coarse Py. | 2324 | | | .7 | .02 |
| 253.5-255.0 | Grano'd. Med. Q.C. alt'n. 3% Py. | 2325 | | | 1.5 | .01 |
| 257.2-257.7 | Grano'd. A 3/4" Qtz. veinlet, minor Py. | 2326 | | | .5 | Tr. |
| 260.5-261.3 | Grano'd. A 1/2" Qtz. veinlet with 50% massive Py. Med. Q.C. alt'n. in wall rock which carries 2% Py. and 2% PO. | 2327 | | | .8 | .03 |

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SIGNED _____

LOJK

DIAMOND DRILL RECORD

WINDFALL OILS & MINES LTD.

HOLE NO. 80 - 25 SHEET NO. 3

LATITUDE _____ DATUM _____ STARTED _____
 DEPARTURE _____ BEARING _____ COMPLETED _____
 ELEVATION _____ DIP _____ ULTIMATE DEPTH _____

| DEPTH FEET | FORMATION | SAMPLE NO | FROM | TO | WIDTH | OZS Au |
|-------------|--|-----------|------|----|-------|--------|
| 262.8-263.4 | Grano'd. Med. Q.C. alt'n. A 1" Carb. veinlet, 2% Py. 2% PO. | 2328 | | | .6 | Tr. |
| 266.7-268.6 | Grano'd. A 2" and two ½" Qtz. veinlets, 2% Py, 2% PO. | 2329 | | | 1.9 | .02 |
| 269.0-269.7 | Grano'd. A ¼" Qtz. vein at 60° to core, 5% massive Py., streaks in wall rock, 1 coarse speck of V.G. at 269.3. | 2330 | | | .7 | .18 |
| 276.3-277.3 | Grano'd. A ¼" Qtz. vein, strong Q.C. wall rock alt'n. 7% coarse Py. | 2331 | | | 1.0 | .18 |
| 280.4-281.5 | Grano'd. Two ¼" Qtz. veinlets, minor Py. | 2332 | | | 1.1 | Tr. |
| 282.2-282.9 | Grano'd. A 3" glassy Qtz. vein, 2% Py. in wall rock. | 2333 | | | .7 | .04 |
| 285.7-286.2 | Grano'd. A 1" glassy Qtz. vein, minor Py. | 2334 | | | .5 | Tr. |
| 295.9-296.4 | Grano'd. A 3" glassy Qtz. vein, minor Py. | 2335 | | | .5 | Tr. |
| 308.0-308.8 | Grano'd. Two ¼" Qtz. veinlets, minor Py. | 2336 | | | .8 | Tr. |
| 316.2-316.7 | Grano'd. Two ¼" Qtz. veinlets, minor Py. | 2337 | | | .5 | .03 |
| 323.8-324.5 | Grano'd. Med. Q.C. alt'n. 5% coarse Py. | 2338 | | | .7 | .02 |
| 335.6-336.1 | Grano'd. weak Q.C. alt'n. A 1/8" Carb. vein, 2% Py. | 2339 | | | .5 | Tr. |
| 337.5-338.3 | Grano'd. Med. Q.C. alt'n. Two ¼" Carb. veinlets, 3% Py. | 2340 | | | .8 | .02 |

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SIGNED _____

[Handwritten Signature]

DIAMOND DRILL RECORD

WINDFALL OILS & MINES LTD.

HOLE NO. 80 - 25 SHEET NO. 4

LATITUDE _____ DATUM _____ STARTED _____
 DEPARTURE _____ BEARING _____ COMPLETED _____
 ELEVATION _____ DIP _____ ULTIMATE DEPTH _____

| DEPTH FEET | FORMATION | SAMPLE NO | FROM | TO | WIDTH | OZS Au |
|-------------|--|-----------|------|----|-------|--------|
| 340.0-340.7 | Grano'd. weak Q.C. alt'n. Three 1/8" Carb. veinlets, 1% Py. | 2341 | | | .7 | Tr. |
| 342.7-343.9 | Grano'd. Three 1/2" Qtz. veinlets, 1% Py. | 2342 | | | 1.2 | Tr. |
| 347.6-348.2 | Grano'd. Two 1" Qtz. veinlets, 3% coarse Py. | 2343 | | | .6 | Tr. |
| 349.5-351.3 | Grano'd. Med. Q.C. alt'n. Rusty, 2% Py. | 2344 | | | 1.8 | Tr. |
| 351.3-352.7 | Grano'd. 60% fractured greenish Qtz. with vuggy, hematitic alt'n. | 2345 | | | 1.4 | .01 |
| 358.2-358.7 | Grano'd. A 3/4" Qtz. veinlet, minor Py. | 2611 | | | .5 | .01 |
| 362.5-363.0 | Grano'd. A 1/2" Qtz. veinlet with 1% Py. | 2612 | | | .5 | Tr. |
| 367.5-369.5 | Grano'd. A 2" and four 1/2" Qtz. veinlets, 1% Py. | 2613 | | | 2.0 | Tr. |
| 372.7-373.2 | Grano'd. A 1" glassy Qtz. vein, minor Py. | 2614 | | | .5 | Tr. |
| 381.5-382.0 | Grano'd. A 2" glassy Qtz. vein, minor Py. | 2615 | | | .5 | .03 |
| 398.0-398.5 | Grano'd. Strong Q.C. alt'n. 3% Py. | 2616 | | | .5 | Tr. |
| 408.4-409.6 | Grano'd. Two 1" glassy Qtz. veins with med. Q.C. wall rock alt'n. that carries 4% Py., 2% PO. at 408.6, a speck of coarse V.C. occurs at the edge of Qtz. veinlet. | 2617 | | | 1.2 | .13 |
| 416.2-417.0 | Grano'd. Three 1/2" Qtz. veinlet, 2% Py. | 2618 | | | .8 | .02 |
| 427.7-428.2 | Grano'd. A 1/2" Qtz. vein, med. Q.C. wall rock alt'n. 3% coarse Py. | 2619 | | | .5 | .06 |

DRILLED BY K. S. [Signature]

SIGNED [Signature]

DIAMOND DRILL RECORD

WINDFALL OILS & MINES LTD.

HOLE NO. 80 - 25 SHEET NO. 5

LATITUDE _____ DATUM _____ STARTED _____
 DEPARTURE _____ BEARING _____ COMPLETED _____
 ELEVATION _____ DIP _____ ULTIMATE DEPTH _____

| DEPTH FEET | FORMATION | SAMPLE NO | FROM | TO | WIDTH | OZS Au |
|-------------|---|-----------|------|----|-------|--------|
| 456.0-456.5 | Grano'd. A $\frac{1}{4}$ " Qtz. veinlet, 2% fine Py. | 2620 | | | .5 | Tr. |
| 472.0-477.5 | Grano'd. A $\frac{1}{4}$ " Qtz. veinlet, minor Py. | 2621 | | | .5 | Tr. |
| 490.8-491.5 | Grano'd. A 1" Qtz. veinlet, minor Py. | 2768 | | | .7 | Tr. |
| 519.0-521.2 | Grano'd. weak Q.C. alt'n. Ten 1/8" to $\frac{1}{2}$ " Qtz. veinlets, 2% Py. | 2769 | | | 2.2 | Tr. |
| 521.2-523.0 | Grano'd. Weak Q.C. alt'n. Six $\frac{1}{2}$ " Qtz. veinlets, 2% Py. | 2770 | | | 1.8 | Tr. |
| 531.0-533.5 | Grano'd. Med. Q.C. alt'n. 5% Qtz. Carb. in stringers, 2% coarse Py. | 2771 | | | 2.5 | Tr. |
| 533.7-535.5 | Grano'd. Strong Q.C. alt'n. 5% coarse Py. | 2772 | | | 1.8 | .06 |
| 101.5-519.0 | Grano'd. Fine to med. grained, some rare Qtz. filled fractures. | | | | | |
| 519.0-536.0 | Grano'd. Qtz. carbonatized with some fine Qtz. Carb. stringers and pyritic mineralization. | | | | | |
| 536.0-554.0 | Grano'd. greyish, med. grained, much of this section of core, was lost due to heavy caving from the cemented area, from 360.0'-370.0'. This hole was stopped at 554.0. LOST CORE from 543.0 to 545.5. LOST CORE From 548.0 to 549.3, from 552.0 to 553.0 | | | | | |
| | END OF HOLE AT 554.0' | | | | | |

DRILLED BY _____

SIGNED _____

C. K. Kuylen

DIAMOND DRILL RECORD

WINDFALL OILS & MINES LTD.

HOLE NO. 80 - 26 SHEET NO. 1

AXT CORE

LATITUDE 13263.55

DATUM *Stored in Rocky, Windfall*

STARTED Oct. 16, 1980

DEPARTURE 11404.85

BEARING N 81° 21' E


COMPLETED Oct. 31, 1980

ELEVATION 9922.91

DIP - 60° 14'

ULTIMATE DEPTH 395.0'

| DEPTH FEET | FORMATION | SAMPLE NO | FROM | TO | WIDTH | OZS Au |
|------------|---|-----------|------|----|-------|--------|
| 0-24.0 | Casing in clay overburden. | | | | | |
| 24.0-27.2 | Grano'd. greyish to greenish grey. Med. grained with some Qtz. filled fractures. | | | | | |
| 30.4-31.5 | Grano'd. Med. Q.C. alt'n. 3% Py. 2% PO. | 2850 | | | 1.1 | Tr. |
| 34.2-34.7 | Grano'd. A 1" Qtz. veinlet, minor Py. | 2851 | | | .5 | Tr. |
| 40.0-41.0 | Grano'd. A 3" and a 1" Qtz. veinlet, 1% Py. | 2852 | | | 1.0 | Tr. |
| 42.2-48.9 | Grano'd. A 3" and a 1" Qtz. veinlet, minor Py. | 2853 | | | 1.7 | Tr. |
| 48.9-49.6 | Grano'd. A 1" Qtz. vein, 1% Py. | 2854 | | | .6 | .01 |
| 51.8-53.0 | Grano'd. Two 1" Qtz. veinlets, 1% Py. | 2855 | | | 1.2 | .03 |
| 59.0-60.2 | Grano'd. One 2" Qtz. vein, mod. light green Q.C. alt'n. 5% Py. 1% PO. | 2856 | | | 1.2 | .07 |
| 63.7-64.5 | Grano'd. A 2" Qtz. vein, 3% Py. | 2857 | | | .8 | .04 |
| 68.0-69.2 | Grano'd. strong light green Q.C. alt'n. A 1" Qtz. vein, 5% coarse Py. 1% PO. | 2858 | | | 1.2 | .06 |
| 73.4-74.5 | Grano'd. strong Q.C. alt'n. A 2" Qtz. vein, 7% coarse Py. 1% PO. | 2859 | | | 1.1 | 1.11 |
| 79.3-80.3 | Grano'd. Three 1" Qtz. veinlets, at 80.0 a 1" Qtz. vein carries about 10 specks of V.G. and a coarse spot of massive Py. and PO. Traces of allaitc. | 2860 | | | 1.0 | 1.29 |

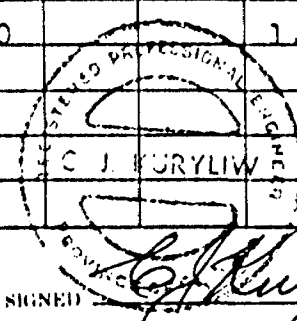

DRILLED BY *Kenneth S. Williams*

SIGNED *C. J. Kuryliw*

DIAMOND DRILL RECORD

WINDFALL OILS & MINES LTD.

HOLE NO. 80-26 SHEET NO. 2

LATITUDE DATUM STARTED

DEPARTURE BEARING COMPLETED

ELEVATION DIP ULTIMATE DEPTH

| DEPTH FEET | FORMATION | SAMPLE NO | FROM | TO | WIDTH | OZS. Au |
|-------------|--|-----------|------|----|-------|---------|
| 87.0-88.5 | Grano'd. 70% glassy Qtz. with 3% Py, 1% PO. in wall rock. | 2861 | | | 1.5 | .05 |
| 88.5-89.8 | Grano'd. Two 1" Qtz. veinlets, 2% Py. | 2862 | | | 1.3 | .03 |
| 89.8-91.4 | Grano'd. weak Q.C. alt'n. 2% Py. | 2863 | | | 1.6 | .03 |
| 91.4-92.7 | Grano'd. strong Q.C. alt'n. A 1" Qtz. vein, 3% Py and a patch of several specks of V.G. in Qtz. at 92.5. | 2864 | | | 1.3 | .33 |
| 92.7-94.0 | Grano'd. Med. Q.C. alt'n. minor Qtz. 2% Py. 1% PO. | 2865 | | | 1.3 | .07 |
| 94.0-95.0 | Grano'd. A 3" glassy Qtz. vein, 3% Py. 1% PO. | 2866 | | | 1.0 | .02 |
| 95.0-96.3 | Andesitic tuff finely banded. 4% Py, minor Qtz. | 2867 | | | 1.3 | Tr. |
| 96.3-97.6 | Andesitic tuff, 5% Py. and a 1/2" Qtz. veinlet. | 2868 | | | 1.3 | .14 |
| 98.6-100.0 | Grano'd. and tuff mixed, weak Q.C. alt'n. minor Qtz. 4% Py. | 2869 | | | 1.4 | .12 |
| 100.0-101.4 | Grano'd. strong Q.C. alt'n. light green. 2% Py. 2% PO. | 2870 | | | 1.4 | .25 |
| 104.0-106.3 | Grano'd. Med. Q.C. alt'n. greenish, A 2" and two 1/2" Qtz. veinlets, 2% Py. 2% PO. | 2871 | | | 2.3 | .02 |
| 106.7-108.2 | Grano'd. Med. light green Q.C. alt'n. 2% Py. 1% PO. | 2872 | | | 1.5 | .02 |

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DIAMOND DRILL RECORD

WINDFALL OILS & MINES LTD.

HOLE NO. 80 - 26 SHEET NO. 3

LATITUDE DATUM STARTED

DEPARTURE BEARING COMPLETED

ELEVATION DIP ULTIMATE DEPTH

| DEPTH FEET | FORMATION | SAMPLE NO. | FROM | TO | WIDTH | OZS Au |
|-------------|--|------------|------|----|-------|--------|
| 108.6-110.0 | Grano'd. strong Q.C. alt'n. light green, 2% Py. 2% PO. | 2873 | | | 1.4 | .10 |
| 115.3-117.3 | Grano'd. Med. Q.C. alt'n. Four 1/2" Qtz. veinlets, 2% Py, 1% PO. | 2874 | | | 2.0 | .05 |
| 147.2-95.0 | Grano'd. Med. grained, greenish grey with strong light green Q.C. alt'n. of wall rock occurs next to Qtz. filled fractures. The mineralization is Py with PO. | | | | | |
| 95.0-99.5 | Andesitic tuff with contacts at 30 - 40° to core, finely banded dark greenish with pyritic mineralization. | | | | | |
| 99.5-158.5 | Grano'd. greenish grey. Med. grained with Qtz. filled fractures. The wall rock of the Qtz. filled fractures has strong light green Q.C. alt'n. and it carries Py. and PO. mineralization. | | | | | |
| 120.8-121.3 | Grano'd. A 1" Qtz. vein, 2% Py. 1% PO;. | 2951 | | | .5 | Tr. |
| 128.2-129.7 | Grano'd. A 1" Qtz. vein, 1% Py. | 2952 | | | .5 | .02 |
| 129.8-130.6 | Grano'd. A 1" Qtz. vein with med. light green Q.C. alt'n. 1% Py. 1% PO. | 2953 | | | .8 | .15 |
| 131.1-132.1 | Grano'd. A 2" Q.Carb. vein with strong light green Q.C. alt'n. 3% Py. 2% PO. | 2954 | | | 1.0 | .03 |

DRILLED BY *[Signature]*

DRILLED *[Signature]*

DIAMOND DRILL RECORD

WINDFALL OILS & MINES LTD.

HOLE NO. 80 - 26 SHEET NO. 4

LATITUDE _____ DATUM _____ STARTED _____
 DEPARTURE _____ BEARING _____ COMPLETED _____
 ELEVATION _____ DIP _____ ULTIMATE DEPTH _____

| DEPTH FEET | FORMATION | SAMPLE NO. | FROM | TO | WIDTH | OZS. Au |
|-------------|---|------------|------|----|-------|---------|
| 135.5-136.4 | Grano'd. Med. Q.C. alt'n. 1% Py. 1% PO. | 2955 | | | .9 | .04 |
| 136.8-138.4 | Grano'd. Two 1" Qtz. veins, 2% Py. | 2956 | | | 1.6 | .03 |
| 146.3-147.4 | Grano'd. A 2" and a 1" Qtz. vein, 1% Py. | 2957 | | | 1.1 | Tr. |
| 150.7-152.4 | Grano'd. A 1" Qtz. vein and strong light green Q.C. alt'n. 3% Py. 2% PO. | 2958 | | | 1.7 | .04 |
| 158.5-172.0 | Greyish tuff, finely banded in parts flecked with amygdules. | | | | | |
| 172.0- | Grano'd. dark greyish, fine to med. grained, fractured with Qtz. veinlets filling the fractures: | | | | | |
| 161.3-162.3 | Tuff, med. Q.C. alt'n. 3% Py. 1% PO. | 2959 | | | 1.0 | .05 |
| 166.0-166.5 | Tuff. A 1/2" Qtz. vein, 2% Py. | 2960 | | | .5 | .03 |
| 171.5-172.0 | Grano'd. Two 1/2" Qtz. veinlets, 2% Py. 1% PO. | 2961 | | | .5 | Tr. |
| 178.7-179.5 | Grano'd. A 1" Qtz. vein with med. Q.C. alt'n. 3% Py. | 2962 | | | .8 | .02 |
| 185.3-186.0 | Grano'd. A 2" Qtz. vein, 1% Py. | 2963 | | | .7 | Tr. |
| 190.0-190.8 | Grano'd. weak Q.C. alt'n. A 1/3" vein of massive Py. | 2964 | | | .8 | .02 |
| 193.2-193.8 | Grano'd. A 2" Qtz. vein, 2% Py. | 2965 | | | .6 | Tr. |
| 197.5-198.0 | Grano'd. A 3" Qtz. vein, 1% Py. | 2966 | | | .5 | Tr. |
| 201.4-202.7 | Grano'd. Two 2" glassy Qtz. veins, 1% Py. | 2967 | | | 1.3 | Tr. |
| 203.5-204.0 | Grano'd. A 1" Qtz. vein, minor Py. | 2968 | | | .5 | Tr. |

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DIAMOND DRILL RECORD

WINDFALL OILS & MINES LTD.

HOLE NO. 80 - 26. SHEET NO. 5

LATITUDE _____ DATUM _____ STARTED _____
 DEPARTURE _____ BEARING _____ COMPLETED _____
 ELEVATION _____ DIP _____ ULTIMATE DEPTH _____

| DEPTH FEET | FORMATION | SAMPLE NO. | FROM | TO | WIDTH | OZS. Au |
|-------------|--|------------|------|----|-------|---------|
| 209.0-210.5 | Grano'd. Three $\frac{1}{4}$ " Qtz. veinlets, one with 50% massive Py. | 2969 | | | 1.5 | .09 |
| 218.0-218.5 | Grano'd. A 2" Qtz. vein, minor Py. | 2970 | | | .5 | .02 |
| 223.0-233.0 | Rusty, very blocky grano'd, about 40% core recovery that required, cementing. | | | | | |
| 233.0- | Grano'd. greyish, fine to med. grained, occasional Qtz. filled fractures running at 50° - 60° to core | | | | | |
| 233.5-234.0 | Grano'd. A $\frac{3}{4}$ " Qtz. vein, minor Py. | 3031 | | | .5 | Tr. |
| 240.0-240.8 | Grano'd. A 2" Qtz. vein with med. wall rock alt'n. 3% Py. at 240 about 15 specks of V.G. with a few specks of alate. | 3032 | | | .8 | 3.17 |
| 247.3-248.0 | Grano'd. A 1" Qtz. vein, minor Py. | 3033 | | | .7 | .13 |
| 252.4-253.0 | Grano'd. A 1" Qtz. vein, 2% Py. | 3034 | | | .6 | .09 |
| 254.0-255.3 | Grano'd. Three $\frac{1}{4}$ " Qtz. veinlets, 3% Py. | 3035 | | | 1.3 | Tr. |
| 261.3-261.9 | Grano'd. A 1" Qtz. vein, minor Py. | 3036 | | | .6 | .03 |
| 269.0-269.5 | Grano'd. A crushed Qtz. vein, 1% Py. | 3037 | | | .5 | Tr. |
| 276.5-277.2 | Grano'd. Med. Q.C. alt'n. 3% Py. | 3038 | | | .7 | .05 |
| 282.0-282.8 | Grano'd. A 1" Qtz. vein, 1% Py. | 3039 | | | .8 | Tr. |
| 285.8-286.4 | Grano'd. Two $\frac{1}{4}$ " Qtz. veinlets, 4% Py. | 3040 | | | .6 | .12 |
| 291.0-292.0 | Grano'd. Two $\frac{1}{4}$ " Qtz. veinlets, partly rusty alt'n. 1% Py. | 3041 | | | 1.0 | Tr. |

DRILLED BY: _____

SIGNED _____

[Handwritten Signature]

DIAMOND DRILL RECORD

WINDFALL OILS & MINES LTD.

HOLE NO. 80 - 26 SHEET NO. 6

LATITUDE DATUM STARTED

DEPARTURE BEARING COMPLETED

ELEVATION DIP ULTIMATE DEPTH

| DEPTH FEET, | FORMATION | SAMPLE NO | FROM | TO | WIDTH | OZS Au |
|-------------|--|-----------|------|----|-------|--------|
| 293.0-293.6 | Grano'd. A ½" Qtz. vein, minor Py. | 3042 | | | .6 | .03 |
| 299.0-299.5 | Grano'd. A 1" Qtz. vein, 3% Py. 3% PO. | 3043 | | | .5 | Tr. |
| 304.4-305.5 | Grano'd. Two 2" Qtz. vein, 5% coarse Py. | 3044 | | | 1.1 | .04 |
| 312.5-313.3 | Grano'd. Med. Q.C. alt'n. 1% Py. | 3081 | | | .8 | Tr. |
| 318.2-318.7 | Grano'd. A 1" Qtz. vein, 2% Py. | 3082 | | | .5 | Tr. |
| 319.2-320.0 | Grano'd. A 1" and a ½" Qtz. vein, strong Q.C. alt'n. 1% Py. | 3083 | | | .8 | Tr. |
| 312.4-322.0 | Grano'd. A 2" Qtz. vein, 2% coarse Py. | 3084 | | | .6 | .11 |
| 323.7-324.7 | Grano'd. Med. Q.C. alt'n. 3% coarse Py. | 3085 | | | 1.0 | .04 |
| 325.2-327.8 | Grano'd. A 3" and two 1" Qtz. Carb. veinlets, 4% streaks of massive Py. | 3086 | | | 1.6 | .04 |
| 329.0-329.5 | Grano'd. Two ½" Qtz. veinlets, 7% streaks of massive Py. | 3087 | | | .5 | .01 |
| 333.5-335.0 | Grano'd. 10% irregular Qtz. minor Py. | 3088 | | | .5 | Tr. |
| 338.0-339.4 | Grano'd. A 1" glassy Qtz. vein, and some irregul. Qtz. Carb. 1% Py. | 3089 | | | 1.4 | Tr. |
| 342.5-344.2 | Grano'd. Two ½" Qtz. veinlets, and some irregular Qtz. Carb. 3% Py. | 3090 | | | 1.7 | Tr. |
| 345.7-346.8 | Grano'd. A 2" and a ½" Qtz. veinlets, Med. Q.C. alt'n. 3% Py. 1% PO. | 3091 | | | 1.1 | Tr. |
| 349.0-350.0 | Grano'd. A ½" Qtz. veinlet, minor Py. | 3092 | | | 1.0 | Tr. |

DRILLED BY *[Signature]*

SIGNED *[Signature]*

DIAMOND DRILL RECORD

WINDFALL OILS & MINES LTD.

HOLE NO. 80 - 26 SHEET NO. 8

LATITUDE DATUM STARTED

DEPARTURE BEARING COMPLETED

ELEVATION DIP ULTIMATE DEPTH

| DEPTH FEET. | FORMATION | SAMPLE NO | FROM | TO | WIDTH | OZS Au |
|-----------------------|---|-----------|-------|----|-------|--------|
| 386.6-388.6 | Grano'd. Med. Q.C. alt'n. two ½" Q.C. veinlets, 3% coarse Py. | 3106 | | | 2.0 | 1.23 |
| 388.6-389.7 | Grano'd. Med. Q.C. alt'n. A 4" glassy Qtz. vein, 3% coarse Py. | 3107 | | | 1.1 | .78 |
| 389.7-390.7 | Grano'd. Med. Q.C. alt'n. A 1" Qtz. Carb. vein with 50% streaks of massive Py. at 390.2 that carries 3 specks of fine V.C. in the massive Py. | 3108 | | | 1.0 | .84 |
| 390.7-391.8 | Grano'd. Med. Q.C. alt'n. 3% coarse Py. with a ½" Qtz. veinlet at 391.5 that has a streak of massive Py. that carries about 7 specks of V.C. One in the massive Py. the rest in the wall rock. | 3109 | | | 1.9 | .47 |
| 391.8-392.7 | Grano'd. weak Q.C. alt'n. 1% Py. | 3110 | | | .9 | Tr. |
| 392.7-394.0 | Grano'd. Med. Q.C. alt'n. with three 1" Qtz. veinlets, 4% Py. | 3111 | | | .3 | .02 |
| 394.0-395.0 | Grano'd. Strong Q.C. alt'n. 4% coarse Py. | 3112 | | | 1.0 | .06 |
| END OF HOLE AT 395.0' | | | | | | |
| | Footage | Dip | Azim. | | | |
| | Collar | | | | | |
| | 200' | - 57° | 77° | | | |

DRILLED BY _____

SIGNED _____

C. J. Kuyflier

DIAMOND DRILL RECORD

WINDFALL OILS & MINES LTD.

HOLE NO. 80 - 27 SHEET NO. 1

LATITUDE --

13239.0

DATUM

ART. CORE

Stand in Rock Windfall

STARTED Nov. 1, 1980

DEPARTURE --

11414.5

BEARING

N - 79° 15' 40" E

COMPLETED Nov. 10, 1980

ELEVATION

4714.6

DIP


- 59° 21' 18"

ULTIMATE DEPTH

| DEPTH FEET | FORMATION | SAMPLE NO | FROM | TO | WIDTH | OZS Au |
|-------------|--|-----------|------|----|-------|--------|
| 0 - 24.0 | Casing in overburden. | | | | | |
| 24.0-51.0 | Grano'd. dark greyish, fine to med. grained. | | | | | |
| 22.6-29.2 | Grano'd. A 2" and three 1" Qtz. veinlets at 55° to core. 3% Py. | 3398 | | | 1.6 | Tr. |
| 33.7-34.4 | Grano'd. Two ½" Qtz. veinlets, one with a fine speck of V.G. at 34.0'. | 3399 | | | .7 | .04 |
| 46.0-47.2 | Grano'd. Two ½" Qtz. veinlets, minor Py. | 3400 | | | 1.2 | Tr. |
| 58.0-58.8 | Grano'd. A 1" Qtz. vein, 1% Py. 1% PO. | 3401 | | | .8 | .04 |
| 51.0-53.3 | Andesitic tuff finely banded at 30° to core. | | | | | |
| 53.3-221.0 | Grano'd. dark greyish, med. grained. | | | | | |
| 81.0-81.8 | Grano'd. A 2" Qtz. vein, 1% Py. | 3402 | | | .8 | .02 |
| 98.4-99.2 | Grano'd. A 4" Qtz. vein, 1% Py. 1% PO. in wall rock. | 3403 | | | .8 | Tr. |
| 106.3-107.1 | Grano'd. A 2" glassy Qtz. vein, minor Py. | 3404 | | | .8 | Tr. |
| 107.5-108.0 | Grano'd. A ½" Qtz. vein, looks barren. | 3405 | | | .5 | .02 |
| 120.1-120.9 | Grano'd. A 4" glassy Qtz. vein, 1% Py. 1% PO. | 3406 | | | .8 | .02 |
| 128.5-129.5 | Grano'd. strong Q.C. alt'n. 3% Py. 1% PO. | 3407 | | | 1.0 | Tr. |
| 130.2-130.7 | Grano'd. A ½" Qtz. vein, looks barren. | 3408 | | | .5 | .02 |
| 133.0-133.7 | Grano'd. A 5" glassy Qtz. vein, 1% Py. | 3409 | | | .7 | .02 |
| 139.5-140.2 | Grano'd. A 1" Qtz. vein, minor Py. | 3410 | | | .7 | .03 |
| 142.0-142.5 | Grano'd. A ½" Qtz. vein, 2% Py. | 3411 | | | .5 | .02 |

DRILLED BY

[Signature]

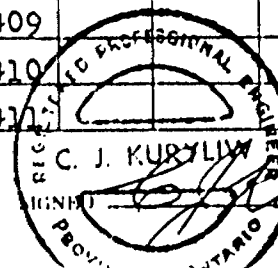

DIAMOND DRILL RECORD

WINDFALL OILS & MINES LTD.

HOLE NO. 80 - 27 SHEET NO. 2

LATITUDE _____ DATUM _____ STARTED _____
 DEPARTURE _____ BEARING _____ COMPLETED _____
 ELEVATION _____ DIP _____ ULTIMATE DEPTH _____

| DEPTH FEET | FORMATION | SAMPLE NO. | FROM | TO | WIDTH | OZS Au |
|-------------|---|------------|------|----|-------|--------|
| 143.4-143.9 | Grano'd. A 1" Qtz. vein, 1% Py. | 3412 | | | .5 | .01 |
| 145.0-145.8 | Grano'd. A 1/2" Qtz. vein, med. Q.C. alt'n. 1% Py. | 3413 | | | .8 | Tr. |
| 149.0-149.5 | Grano'd. A 1/2" Qtz. vein, minor Py. | 3414 | | | .5 | Tr. |
| 150.2-152.4 | Grano'd. med. Q.C. alt'n. 1% Py. 1% PO. | 3415 | | | 2.2 | .05 |
| 152.4-153.8 | Grano'd. weak Q.C. alt'n. 1% Py. | 3416 | | | 1.4 | .02 |
| 157.0-158.0 | Grano'd. Med. Q.C. alt'n. A 1" Qtz. vein, 2% Py. 1% PO. | 3417 | | | 1.0 | .06 |
| 167.5-168.0 | Grano'd. A 1" Qtz. vein, minor Py. | 3418 | | | .5 | .02 |
| 171.8-172.6 | Grano'd. Med. Q.C. alt'n. 1% Py. | 3419 | | | .8 | .03 |
| 174.0-175.8 | Grano'd. strong Q.C. alt'n. Two 1/2" Qtz. veins, 2% Py. | 3420 | | | 1.8 | .01 |
| 175.8-177.7 | Grano'd. A 3" and two 1" Qtz. veins, 1% Py. | 3421 | | | 1.9 | Tr. |
| 174.1-180.0 | Grano'd. strong Q.C. alt'n. Two 1/2" Qtz. Carb. veins, 2% Py. | 3422 | | | .9 | .03 |
| 191.4-192.6 | Grano'd. A 1" and a 1/2" Qtz. vein, 1% Py. 1% PO. | 3423 | | | 1.2 | Tr. |
| 196.4-197.1 | Grano'd. A 1/2" Qtz. vein with a streak of massive Py. and PO. | 3424 | | | .7 | .26 |
| 198.3-199.0 | Grano'd. Med. Q.C. alt'n., 1/2" Qtz. veinlet with streaks of Py. | 3425 | | | .7 | .03 |
| 203.5-204.0 | Grano'd. A 1/2" Qtz. vein, 1/2% Py. 1/2% PO. | 3426 | | | .5 | .05 |
| 206.0-206.7 | Grano'd. A 3/4" Qtz. vein, minor Py. | 3427 | | | .7 | Tr. |

DRILLED BY _____

SIGNED _____

DIAMOND DRILL RECORD

WINDFALL OILS & MINES LTD.

HOLE NO. 80 - 27 SHEET NO. 3

LATITUDE _____ DATUM _____ STARTED _____
 DEPARTURE _____ BEARING _____ COMPLETED _____
 ELEVATION _____ DIP _____ ULTIMATE DEPTH _____

| DEPTH FEET | FORMATION | SAMPLE NO | FROM | TO | WIDTH | OZS Au |
|-------------|--|-----------|------|----|-------|--------|
| 211.4-212.0 | Grano'd. A 6" Qtz. vein with some Py. along edges | 3428 | | | .6 | .05 |
| 229.5-230.0 | Grano'd. Two ¼" Qtz. veinlets, 3% Py. | 3429 | | | .5 | Tr. |
| 242.0-242.8 | Grano'd. Two 1" Qtz. veinlets with rusty wall rock. | 3430 | | | .8 | .02 |
| 221.0-245.0 | Grano'd. , very rusty blocky zone about 50% core recovery. | | | | | |
| 245.8-246.6 | Grano'd. A 2" Qtz. vein, some rusty wall rock, 3% Py. | 3431 | | | .8 | .07 |
| 251.5-252.2 | Grano'd. A 2" Qtz. vein, 2% Py. in wall rock. | 3432 | | | .7 | Tr. |
| 254.0-255.0 | Grano'd. A 1" Qtz. vein, 2% Py. in wall rock. | 3433 | | | 1.0 | Tr. |
| 258.0-259.0 | Grano'd. A ½" and a 1" Qtz. vein, with a streak of massive Py. in wall rock. | 3434 | | | 1.0 | .14 |
| 261.4-262.0 | Grano'd. A 2" Qtz. vein, with rusty wall rock. 1% Py. | 3435 | | | .6 | Tr. |
| 264.5-265.2 | Grano'd. A ½" Qtz. Carb. vein, with med. Q.C. wall rock alt'n. 1% Py. | 3436 | | | .7 | .03 |
| 266.5-267.1 | Grano'd. A ¾" Qtz. vein, 2% Py. in wall rock. | 3437 | | | .6 | Tr. |
| 271.0-272.1 | Grano'd. A 3" Qtz. vein with 3% Py. in wall rock, | 3438 | | | 1.1 | Tr. |
| 272.4-273.0 | Grano'd. A 1" Qtz. vein, 1% Py. in wall rock. | 3439 | | | .6 | Tr. |
| 277.0-277.5 | Grano'd. A ½" Qtz. veinlet, 2% Py. | 3440 | | | .5 | Tr. |

DRILLED BY _____

SIGNED _____

DIAMOND DRILL RECORD

WINDFALL OILS & MINES LTD.

HOLE NO. 80 - 27 SHEET NO. 4

LATITUDE _____ DATUM _____ STARTED _____
 DEPARTURE _____ BEARING _____ COMPLETED _____
 ELEVATION _____ DIP _____ ULTIMATE DEPTH _____

| DEPTH FEET | FORMATION | SAMPLE NO. | FROM | TO | WIDTH | OZS Au |
|-------------|--|------------|------|----|-------|--------|
| 278.1-278.7 | Grano'd. Two $\frac{1}{2}$ " Qtz. veinlets, 3% coarse Py. and one coarse speck of V.G. at 278.4. | 3441 | | | .6 | .20 |
| 287.2-287.7 | Grano'd. A $\frac{1}{4}$ " Qtz. vein with streaks of massive Py. | 3442 | | | .5 | Tr. |
| 289.0-289.8 | Grano'd. A 7" glassy Qtz. vein with some Py. in wall rock. | 3443 | | | .8 | Tr. |
| 300.4-302.2 | Grano'd. Three 1" Qtz. veinlets, 2% coarse Py. | 3444 | | | 1.8 | Tr. |
| 302.8-303.5 | Grano'd. A 2" Qtz. vein, minor Py. | 3445 | | | .7 | Tr. |
| 309.3-310.7 | Grano'd. A 2" and a $\frac{1}{2}$ " Qtz. veinlet with streaks of massive Py. in each. | 3446 | | | 1.4 | .04 |
| 311.4-312.5 | Grano'd. Two $\frac{1}{4}$ " Qtz. veinlets, 2% Py. | 3447 | | | 1.1 | .02 |
| 317.0-318.3 | Grano'd. Two $\frac{1}{2}$ " Qtz. veinlets, 2% Py. | 3448 | | | 1.3 | .14 |
| 321.0-321.5 | Grano'd. A $\frac{1}{2}$ " Qtz. vein, some Py. along vein edges. | 3449 | | | .5 | .63 |
| 322.3-324.5 | Grano'd. A 2" and a 1" Qtz. veinlet, 2% Py. in wall rock. | 3450 | | | 2.2 | .02 |
| 327.0-328.0 | Grano'd. Four $\frac{1}{4}$ " Qtz. veinlets, 1% Py. | 3451 | | | 1.0 | Tr. |
| 337.0-339.6 | Grano'd. weak Q.C. alt'n. 3% coarse Py. | 3452 | | | 2.6 | Tr. |
| 339.6-341.0 | Grano'd. A 3" glassy Qtz. vein, Med. Q.C. alt'n. 3% Py. | 3453 | | | 1.4 | .01 |
| 341.0-343.0 | Grano'd. Med. Q.C. alt'n. a 4" Qtz. vein, 4% Py. | 3454 | | | 2.0 | Tr. |

DRILLED BY _____

SIGNED _____

DIAMOND DRILL RECORD

WINDFALL OILS & MINES LTD.

HOLE NO. 80... 27... SHEET NO. 5

LATITUDE _____ DATUM _____ STARTED _____
 DEPARTURE _____ BEARING _____ COMPLETED _____
 ELEVATION _____ DIP _____ ULTIMATE DEPTH _____

| DEPTH FEET | FORMATION | SAMPLE NO. | FROM | TO | WIDTH | OZS. Au |
|-------------|--|------------|------|----|-------|---------|
| 343.0-344.8 | Grano'd. Med. Q.C. alt'n. Two ½" Qtz. veinlets, 4% coarse Py. | 3455 | | | 1.8 | .03 |
| 344.8-348.0 | Grano'd. weak Qtz. Carb. alt'n. with 3% coarse Py | 3456 | | | 3.2 | .01 |
| 348.0-349.3 | Grano'd. Med. Q.C. alt'n. A 1" Qtz. vein with some streaks of massive Py. looks good. | 3457 | | | 1.3 | .02 |
| 349.3-350.7 | Grano'd. strong Q.C. alt'n. A 3" glassy Qtz. vein, 4% coarse Py. | 3458 | | | 1.4 | .01 |
| 350.7-353.0 | Grano'd. weak Q.C. alt'n. 3% Py. | 3459 | | | 1.5 | Tr. |
| 353.0-354.5 | Grano'd. weak Q.C. alt'n. 2% Py. | 3460 | | | 1.5 | Tr. |
| 354.5-355.6 | Grano'd. strong Q.C. alt'n. A 3" Qtz. vein, 3% Py | 3461 | | | 1.1 | Tr. |
| 355.6-358.3 | Grano'd. Med. Q.C. alt'n. 2% Py. | 3462 | | | 2.7 | Tr. |
| 359.5-360.2 | Grano'd. Med. Q.C. alt'n. A ¼" Qtz. vein, 2% Py. | 3463 | | | .7 | Tr. |
| 361.1-361.9 | Grano'd. A 6" glassy Qtz. vein, 5% coarse Py. in wall rock. | 3464 | | | .8 | Tr. |
| 361.9-364.0 | Grano'd. Med. Q.C. alt'n. Three ¼" Qtz. veinlets 4% coarse Py. | 3465 | | | 2.1 | .05 |
| 364.0-366.0 | Grano'd. Med. Q.C. alt'n. 4% Py. | 3466 | | | 2.0 | .02 |
| 366.0-367.2 | Grano'd. Med. Q.C. alt'n. A ½" Qtz. vein, 3% Py. | 3467 | | | 1.2 | Tr. |
| 368.3-370.4 | Grano'd. weak Q.C. alt'n. 3% Py. | 3468 | | | 1.1 | Tr. |
| 371.3-372.2 | Grano'd. Med. Q.C. A 1" Qtz. vein, 5% Py. | 3469 | | | .9 | Tr. |
| 372.5-374.0 | Grano'd. Med. Q.C. alt'n. 3% Py. | 3470 | | | 1.5 | .01 |

DRILLED BY _____

SIGNED  _____

DIAMOND DRILL RECORD

WINDFALL OILS & MINES LTD.

HOLE NO. 80 - 27 SHEET NO. 6

LATITUDE _____ DATUM _____ STARTED _____
 DEPARTURE _____ BEARING _____ COMPLETED _____
 ELEVATION _____ DIP _____ ULTIMATE DEPTH _____

| DEPTH FEET | FORMATION | SAMPLE NO | FROM | TO | WIDTH | OZS. Au |
|--|--|-----------|------|----|-------|---------|
| 374.0-375.3 | Grano'd. weak Q.C. alt'n. Three $\frac{1}{4}$ " Qtz. veinlets 2% Py. | 3471 | | | 1.3 | Tr. |
| 375.3-377.0 | Grano'd. strong Q.C. alt'n. 10% coarse Py. looks good. | 3472 | | | 1.7 | .01 |
| 377.7-379.0 | Grano'd. strong Q.C. alt'n. A 2" and a 1" Qtz. veinlet, 7% coarse Py. in wall rock. looks good. | 3473 | | | 1.3 | Tr. |
| 380.4-381.3 | Grano'd. Med. Q.C. alt'n. Two $\frac{1}{2}$ " Qtz. veinlets, 4% coarse Py. | 3474 | | | .9 | .02 |
| 382.0-383.0 | Grano'd. Med. Q.C. alt'n. 3% coarse Py. | 3475 | | | 1.0 | Tr. |
| END OF HOLE AT 384.0' | | | | | | |
| Note. Machine motor block cracked, so hole was stopped. | | | | | | |
| | | | | | | |
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DRILLED BY _____

SIGNED *C. Kureflew*

DIAMOND DRILL RECORD

WINDFALL OILS & MINES LTD.

HOLE NO. 80 - 28 SHEET NO. 1

LATITUDE 13205.0

DATUM

AXT Core
Stand in rack Windfall

STARTED Nov. 17, 1980

DEPARTURE ~~11774.4~~ 11421.5

BEARING

80 47 32 E

COMPLETED Nov. 22, 1980

ELEVATION 9924.97

DIP

- 59 40 32 N

ULTIMATE DEPTH 448.0'

| DEPTH FEET* | FORMATION | SAMPLE NO | FROM | TO | WIDTH | OZS Au |
|-------------|---|-----------|------|----|-------|--------|
| C - 25.0 | Casing in overburden, largely clay. | | | | | |
| 25.0-39.0 | Crano'd. greyish, coarse grained, some fractures developed at 50° to core axis. | | | | | |
| 39.0-39.7 | Andesitic tuff, banded at 40° to core. | | | | | |
| 39.7-207.0 | Crano'd. greyish, coarse grained, with some Qtz filled fractures that run at 50° to core. | | | | | |
| 26.0-26.0 | Crano'd. Two 2" Qtz. veins, one with 30% massive Py. looks good. | 3549 | | | .9 | .21 |
| 34.0-35.0 | Crano'd. Med. Q.C. alt'n. A 1/2" Qtz. Carb. vein, 2" Py. 2% PO. | 3550 | | | 1.0 | .13 |
| 39.5-40.3 | Contact between tuff and crano'd. A 1" and 1" Qtz. vein, 2" Py. | 3551 | | | .8 | .07 |
| 45.4-47.0 | Crano'd. A 1/2" Qtz. vein, med. Q.C. alt'n. 1% Py. 2% PO. | 3552 | | | .6 | .05 |
| 53.5-54.1 | Crano'd. A 1" Qtz. Carb. vein, 1% Py. | 3553 | | | .6 | .03 |
| 74.7-76.1 | Crano'd. A 3" and three 1/2" Qtz. veinlets at 60° to core, 3" Py. | 3554 | | | 1.4 | .02 |
| 59.0-59.6 | Crano'd. A 1/2" and a 1/4" Qtz. veinlet, 2% Py. | 3555 | | | .6 | .02 |
| 61.0-61.9 | Crano'd. A 1/2" and a 1" Qtz. veinlet, green Q.C. wall rock alt'n. with 4% Py. | 3556 | | | .9 | .05 |

DRILLED BY

Kenneth Whittington



SIGNED

C. J. Kuryliw

DIAMOND DRILL RECORD

WINDFALL OILS & MINES LTD.

HOLE NO. 80 - 29 SHEET NO. 2

LATITUDE _____ DATUM _____ STARTED _____
 DEPARTURE _____ BEARING _____ COMPLETED _____
 ELEVATION _____ DIP _____ ULTIMATE DEPTH _____

| DEPTH FEET. | FORMATION | SAMPLE NO | FROM | TO | WIDTH | OZS Au |
|-------------|---|-----------|------|----|-------|--------|
| 66.2-67.2 | Grano'd. strong Q.C. alt'n. 1 1/2" Qtz. Carb. veinlet, 5% Py. 2% PO. in wall rock. | 3557 | | | 1.0 | .06 |
| 68.7-69.5 | Grano'd. A 2" Qtz. Carb. vein, with light green Q.C. wall rock. alt'n. 2% coarse Py. in wall rock | 3558 | | | .8 | .03 |
| 74.0-74.7 | Grano'd. A 2" Qtz. Carb. vein, 5% Py. in vein. | 3559 | | | .7 | .81 |
| 75.2-76.0 | Grano'd. 50% irregular Qtz. 5% Py. in the Qtz. | 3560 | | | .8 | .06 |
| 79.0-79.7 | Grano'd. Two 1" Qtz. Carb. vein, 3% Py. 3% PO. in veins. | 3561 | | | .7 | .04 |
| 85.5-86.0 | Grano'd. A 3" glassy Qtz. vein, minor Py. | 3562 | | | .5 | .01 |
| 90.7-91.5 | Grano'd. Med. Q.C. alt'n. A 1/2" Qtz. Carb. veinlet 1% Py. 2% Po. | 3563 | | | .8 | .04 |
| 107.7-108.4 | Grano'd. Med. Q.C. alt'n. A 1/2" Qtz. veinlet, 2% Py. 1% Po. | 3564 | | | .7 | .08 |
| 117.5-118.2 | Grano'd. A 1/2" and a 1/4" Qtz. veinlet, 3% Po. 1% Py. | 3565 | | | .7 | Tr. |
| 128.0-128.9 | Grano'd. A 5" glassy Qtz. vein, 2% Py. 2% Po. in wall rock | 3566 | | | .9 | .03 |
| 140.0-140.6 | Grano'd. A 1/2" Qtz. vein, minor Py. | 3567 | | | .6 | Tr. |
| 167.0-167.7 | Grano'd. Two 1/8" Qtz. veinlets, with streaks of massive Py. and Po. | 3568 | | | .7 | .01 |
| 174.3-175.0 | Grano'd. A 1/2" glassy Qtz. vein, minor Py. | 3569 | | | .7 | .03 |
| 183.6-184.4 | Grano'd. A 2" and a 1/2" Qtz. vein, 1% Py. | 3570 | | | .8 | .06 |

DRILLED BY James D. Hamilton

SIGNED [Signature]

DIAMOND DRILL RECORD

WINDFALL OILS & MINES LTD.

HOLE NO. 80 - 28 SHEET NO. 3

| | | |
|-----------|---------|----------------|
| LATITUDE | DATUM | STARTED |
| DEPARTURE | BEARING | COMPLETED |
| ELEVATION | DIP | ULTIMATE DEPTH |

| DEPTH FEET | FORMATION | SAMPLE NO | FROM | TO | WIDTH | OZS Au | |
|-------------|---|-----------|------|----|-------|--------|-------|
| 198.0-199.5 | Grano'd. A 2" and two 1/2" Qtz. veinlets, minor Py. | 3571 | | | 1.5 | Tr. | |
| 204.5-205.0 | Grano'd. Two 1/2" Qtz. veinlets, 1% Py. | 3572 | | | .5 | Tr. | |
| 207.0-208.7 | Grano'd. A 5" glassy Qtz. vein, some rusty wall rock alt'n., minor Py. | 3573 | | | 1.7 | Tr. | |
| 214.2-215.2 | Grano'd. Two 2" Qtz. veinlets, minor Py. | 3574 | | | 1.0 | Tr. | |
| 228.4-229.3 | Grano'd. A 1" and two 1/2" Qtz. veinlets, 2% Py. | 3575 | | | .9 | Tr. | |
| 236.7-237.3 | Grano'd. A 1" glassy Qtz. vein, minor Py. | 3576 | | | .6 | .02 | |
| 238.8-239.4 | Grano'd. A 1/2" Qtz. vein, 1% Py. | 3577 | | | .6 | .02 | |
| 241.5-250.0 | Grano'd. A 1/2" Qtz. vein, 2% Py. | 3578 | | | .5 | Tr. | |
| 242.8-242.5 | Grano'd. A 1" Qtz. vein at 238.0 carries 2 fine specks of V.C. | 3579 | | | .7 | .18 | } .18 |
| | | | | | | .19 | |
| 252.8-253.4 | Grano'd. A 1" Qtz. vein, 3% Py. | 3580 | | | .6 | .03 | |
| 253.4-255.0 | Grano'd. rusty, med. Q.C. alt'n. 4% Py. | 3581 | | | 1.6 | .01 | |
| 255.0-256.4 | Grano'd. A 1" and three 1/2" Qtz. veinlets, rusty med. Q.C. alt'n. 5% Py. in wall rock. One 1/2" veinlet at 255.7 carries 50% massive Py. | 3582 | | | 1.4 | .21 | |
| 256.4-257.3 | Grano'd. rusty. A 3' glassy Qtz. vein. 1% Py. | 3583 | | | .9 | Tr. | |
| 261.0-262.0 | Grano'd. Three 1/2" Qtz. veinlets, 2% Py. | 3584 | | | 1.0 | .01 | |
| 262.0-263.3 | Grano'd. rusty, med. Q.C. alt'n. A 1/2" Carb. veinlet, 7% coarse Py. in wall rock. | 3585 | | | 1.3 | .01 | |
| 264.0-265.0 | Grano'd. Two 1/2" Qtz. veinlets, 3% Py. | 3586 | | | 1.0 | Tr. | |

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DIAMOND DRILL RECORD

WINDFALL OILS & MINES LTD.

HOLE NO. 80 - 28 SHEET NO. 4

LATITUDE

DATUM

STARTED

DEPARTURE

BEARING

COMPLETED

ELEVATION

DIP

ULTIMATE DEPTH

| DEPTH FEET | FORMATION | SAMPLE NO | FROM | TO | WIDTH | OZS Ag | |
|-------------|--|-----------|------|----|-------|--------|--|
| 265.6-266.9 | Grano'd. A $\frac{1}{2}$ " and a $\frac{1}{4}$ " Qtz. veinlet, 3% Py. | 3587 | | | 1.3 | .01 | |
| 267.7-268.5 | Grano'd. Two $\frac{1}{2}$ " Qtz. veinlets, 3% Py. | 3588 | | | .8 | TR. | |
| 270.0-271.2 | Grano'd. A 1" Qtz. veinlet, med. Q.C. alt'n. 2% Py. | 3589 | | | 1.2 | 102 | |
| 271.7-272.3 | Grano'd. Two $\frac{1}{2}$ " Qtz. veinlets, 2% Py. | 3590 | | | .6 | .01 | |
| 273.0-274.7 | Grano'd. Four 1" Qtz. veinlets, 3% coarse Py. | 3591 | | | 1.7 | .03 | |
| | Looks good. | | | | | | |
| 276.0-276.5 | Grano'd. A $\frac{1}{2}$ " Qtz. vein with some rusty wall rock alt'n. 2% Py. | 3592 | | | .5 | TR. | |
| 277.3-277.8 | Grano'd. A 3" Qtz. vein, 1% Py. | 3593 | | | .5 | TR. | |
| 278.5-279.0 | Grano'd. A 1" Qtz. vein, 3% Py. in wall rock. | 3594 | | | .5 | TR. | |
| 279.5-280.1 | Grano'd. A 1" Qtz. Carb. vein, 7% coarse Py. in wall rock. | 3595 | | | .6 | .05 | |
| 282.7-283.3 | Grano'd. A 1" Qtz. vein with rusty wall rock alt'n. 2% Py. | 3596 | | | .6 | .02 | |
| 284.7-286.0 | Grano'd. Med. Q.C. wall rock alt'n. rusty, a 3" and two $\frac{1}{2}$ " Qtz. veinlets, 5% coarse Py. | 3597 | | | 1.3 | TR. | |
| 207.0-286.0 | Grano'd. with blocky numerous Qtz. filled fractures that run at about 60 to core. These have rusty wall rock alt'n. along the Qtz. filled fractures, and some pyritic mineralization. | | | | | | |

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DIAMOND DRILL RECORD

WINDFALL OILS & MINES LTD.

HOLE NO. 80 - 28 SHEET NO. 5

LATITUDE

DATUM

STARTED

DEPARTURE

BEARING

COMPLETED

ELEVATION

DIP

ULTIMATE DEPTH

| DEPTH FEET | FORMATION | SAMPLE NO | FROM | TO | WIDTH | OZS Au |
|-------------|--|-----------|------|----|-------|--------|
| 286.0-445.7 | Grano'd. greenish grey, coarse grained with some well developed Qtz. filled fractures. | | | | | |
| 288.0-288.5 | Grano'd. A 1/2" Qtz. veinlet, 5% coarse Py. in wall rock. | 3598 | | | .5 | .20 |
| 291.0-291.5 | Grano'd. A 2" Qtz. vein, 3% Py. in wall rock. | 3599 | | | .5 | .01 |
| 296.0-297.0 | Grano'd. Three 1/2" Qtz. veinlets, 5% Py. | 3600 | | | 1.0 | .01 |
| 297.5-298.0 | Grano'd. A 1/2" Qtz. vein, minor Py. | 3601 | | | .5 | Tr. |
| 298.5-299.2 | Grano'd. strong Q.C. alt'n. 7% coarse Py. | 3602 | | | .7 | Tr. |
| 303.0-303.7 | Grano'd. A 1" Qtz. vein, 3% Py. | 3603 | | | .7 | .01 |
| 305.0-306.0 | Grano'd. A 2" and a 1/2" Qtz. vein, med. Q.C. alt'n 10% coarse Py. looks good. | 3604 | | | 1.0 | .08 |
| 309.5-310.8 | Grano'd. Three 1/2" Qtz. veinlets, med. Q.C. alt'n, 4% coarse Py. | 3605 | | | 1.3 | .05 |
| 312.6-314.2 | Grano'd. Two 1" and four 1/2" Qtz. veinlets, 7% coarse Py. looks good. | 3606 | | | 1.6 | .24 |
| 319.0-320.8 | Grano'd. A 2" and two 1" Qtz. veinlets, 2% Py. | 3607 | | | 1.8 | .02 |
| 323.0-323.5 | Grano'd. A 1/2" Qtz. vein, 3% Py. | 3608 | | | .5 | .01 |
| 327.9-328.6 | Grano'd. A 4" Qtz. vein, 3% Py. in wall rock. | 3609 | | | .5 | .02 |
| 329.4-330.6 | Grano'd. A 6" and a 1/2" Qtz. veinlet, 1% Py. | 3610 | | | 1.2 | .01 |
| 337.0-337.8 | Grano'd. A 1" Qtz. vein, 2% Py. | 3611 | | | .8 | Tr. |
| 341.3-343.3 | Grano'd. A 2" and a 1" Qtz. vein, 3% coarse Py. | 3612 | | | 2.0 | .02 |

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DIAMOND DRILL RECORD

WINDFALL OILS & MINES LTD.

HOLE NO. 80 - 28 SHEET NO. 6

LATITUDE

DATUM

STARTED

DEPARTURE

BEARING

COMPLETED

ELEVATION

DIP

ULTIMATE DEPTH

| DEPTH FEET | FORMATION | SAMPLE NO | FROM | TO | WIDTH | OZS AG |
|-------------|---|-----------|------|----|-------|--------|
| 343.3-344.2 | Grano'd. A 2" Qtz. vein, a strong Q.C. wall rock alt'n. with 10% coarse Py. | 3613 | | | .9 | .03 |
| 350.0-351.0 | Grano'd. A 4" Qtz. vein, and a 1" $\frac{1}{4}$ % coarse Py. in wall rock. | 3614 | | | 1.0 | .01 |
| 352.5-353.7 | Grano'd. Two 2" Qtz. veins, strong Q.C. wall rock alt'n. 7% coarse Py. | 3615 | | | 1.2 | .04 |
| 359.0-360.4 | Grano'd. Med. Q.C. alt'n. Four $\frac{1}{2}$ " Qtz. veinlets, 5% coarse Py. in streaks. | 3616 | | | 1.4 | TR. |
| 362.3-363.7 | Grano'd. A 7" and a 1" Qtz. veinlet, strong Q.C. alt'n. 3% coarse Py. | 3617 | | | 1.4 | TR. |
| 370.0-370.7 | Grano'd. A 3" Qtz. vein, 3% Py. | 3618 | | | .7 | TR. |
| 376.2-377.4 | Grano'd. Med. Q.C. alt'n. A 1" Qtz. vein, 5% coarse Py. | 3619 | | | 1.2 | .01 |
| 378.8-380.5 | Grano'd. A 2" and two $\frac{1}{2}$ " Qtz. veinlets, 5% massive Py. streaks. | 3620 | | | 1.7 | .01 |
| 384.0-385.8 | Grano'd. A 1" and three $\frac{1}{2}$ " Qtz. veinlets, 1% Py. | 3621 | | | 1.8 | TR. |
| 392.4-392.9 | Grano'd. A $\frac{1}{2}$ " Qtz. vein, 2% Py. | 3622 | | | .5 | .02 |
| 396.7-397.3 | Grano'd. A 1" Qtz. vein, minor Py. | 3623 | | | .6 | TR. |
| 406.0-406.7 | Grano'd. A $\frac{1}{2}$ " Qtz. vein, 1% Py. | 3624 | | | .7 | .05 |
| 412.8-414.2 | Grano'd. A 5" and a $\frac{1}{2}$ " Qtz. vein, 4% coarse Py. in wall rock. | 3625 | | | 1.4 | .02 |

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DIAMOND DRILL RECORD

WINDFALL OILS & MINES LTD.

HOLE NO. 80 - 29 SHEET NO. 1


LATITUDE 13245.22
 DEPARTURE 11310.22
 ELEVATION 9920.22

AXT CORE
 DATUM *Stored in Rack, Windfall*
 BEARING N 82° 50' E
 DIP - 59° 20'

STARTED Oct. 25, 1980
 COMPLETED Nov. 6, 1980
 ULTIMATE DEPTH 562.0'

| DEPTH FEET | FORMATION | SAMPLE NO | FROM | TO | WIDTH | OZS Au |
|-------------|--|-----------|------|----|-------|--------|
| 0 - 20.0 | Casing in overburden | | | | | |
| 20.0-219.0 | Grano'd. greenish grey med. grained, somewhat massive, Qtz. filled fractures are rare. | | | | | |
| 52.0-54.0 | Grano'd. Four $\frac{1}{4}$ " irregular Qtz. veinlets, 1% Py. | 3045 | | | 2.0 | .02 |
| 96.2-97.0 | Grano'd. A 5" Qtz. vein at 70° to core. 3% Py. along wall rock. | 3046 | | | .8 | Tr. |
| 115.8-116.5 | Grano'd. A $\frac{1}{4}$ " Qtz. Carb. veinlet with a streak of massive Py. | 3047 | | | .7 | Tr. |
| 122.4-123.0 | Grano'd. Two $\frac{1}{2}$ " Qtz. veinlets, 1% Py. | 3048 | | | .6 | .05 |
| 149.0-149.6 | Grano'd. A $\frac{1}{2}$ " Qtz. vein, 2% Py. 2% PO. | 3049 | | | .6 | .12 |
| 160.3-160.9 | Grano'd. A 1" Qtz. vein, 1% Py. | 3050 | | | .6 | .04 |
| 162.6-163.2 | Grano'd. A $\frac{1}{2}$ " Qtz. vein with streaks of massive Py and PO. | 3051 | | | .6 | .02 |
| 178.8-179.4 | Grano'd. A 1" Qtz. vein, 1% Py. 1% PO. | 3052 | | | .6 | .02 |
| 182.7-183.3 | Grano'd. A 1" Qtz. vein, 1% Py. 1% PO. | 3053 | | | .6 | .01 |
| 192.0-192.8 | Grano'd. A 3" Qtz. vein with some Py. along edges. | 3054 | | | .8 | .02 |
| 198.3-198.9 | Grano'd. A 1" Qtz. vein, minor Py. | 3055 | | | .6 | Tr. |
| 200.8-202.0 | Grano'd. Med. Q.C. alt'n. 1% Py. | 3056 | | | 1.2 | Tr. |
| 219.0-220.0 | Tuff grano'd. contact. A $\frac{1}{2}$ " and a $\frac{1}{4}$ " Qtz. veinlet 1% Py. | 3057 | | | 1.0 | .01 |

DRILLED BY *W. J. Kuryliw*

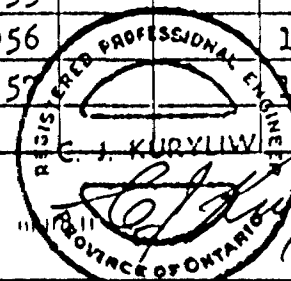

DIAMOND DRILL RECORD

WINDFALL OILS & MINES LTD.

HOLE NO. 80 - 29 SHEET NO. 2

LATITUDE _____ DATUM _____ STARTED _____
 DEPARTURE _____ BEARING _____ COMPLETED _____
 ELEVATION _____ DIP _____ ULTIMATE DEPTH _____

| DEPTH FEET | FORMATION | SAMPLE NO | FROM | TO | WIDTH | OZS Au |
|-------------|---|-----------|------|----|-------|--------|
| 219.0-249.0 | Tuff dark greyish with some amygdaloidal flecks banding at 10° to core axis. | | | | | |
| 249.0-325.0 | Grano'd. greenish grey, med. grained with some widely spaced Qtz. filled fractures. | | | | | |
| 249.5-250.9 | Grano'd. A ½" Qtz. veinlet with weak Q.C. alt'n. 2% Py. | 3058 | | | 1.4 | .01 |
| 254.0-255.5 | Grano'd. Two ¼" Qtz veinlets, 1% Py. 1% PO. | 3059 | | | 1.5 | .02 |
| 260.0-261.0 | Grano'd. Med. Q.C. alt'n. 1% Py. 1% PO. | 3060 | | | 1.0 | Tr. |
| 264.7-265.5 | Grano'd. Three ½" Qtz. veinlets, 2% Py. 1% PO. | 3061 | | | .8 | Tr. |
| 271.4-272.7 | Grano'd. A 1" and a 2" irregular Qtz. veinlet, 1% Py. | 3062 | | | 1.3 | Tr. |
| 276.4-277.0 | Grano'd. A 3" Qtz. vein, ½% Py. ½% PO. | 3063 | | | .6 | Tr. |
| 280.5-281.3 | Grano'd. A 4" Qtz. vein, rusty, 2% Py. 2% PO. | 3064 | | | .8 | .02 |
| 283.5-284.2 | Grano'd. A ½" Qtz. veinlet, 3% Py. | 3065 | | | .7 | .02 |
| 301.2-301.7 | Grano'd. A 2" Qtz. veinlet, minor Py. | 3066 | | | .5 | .01 |
| 307.5-308.0 | Grano'd. A 1" Qtz. vein, 3% Py. | 3067 | | | .5 | Tr. |
| 309.8-310.4 | Grano'd. A ½" Qtz. vein, 5% coarse Py. in vein. | 3068 | | | .6 | .03 |
| 313.0-313.5 | Grano'd. A 1" Qtz. vein, 3% Py. in wall rock. | 3069 | | | .5 | Tr. |
| 321.0-322.8 | Grano'd. Two ½" Qtz. veinlets, minor Py. | 3070 | | | 1.8 | Tr. |
| 324.3-325.0 | Grano'd. A ½" Qtz. veinlet, 1% Py. | 3071 | | | .7 | Tr. |
| 328.0-328.8 | Grano'd. Tuff contact, 7% coarse Py cubes. | 3072 | | | .8 | .03 |

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DIAMOND DRILL RECORD

WINDFALL OILS & MINES LTD.

HOLE NO. 80 - 29 SHEET NO. 3

LATITUDE _____ DATUM _____ STARTED _____
 DEPARTURE _____ BEARING _____ COMPLETED _____
 ELEVATION _____ DIP _____ ULTIMATE DEPTH _____

| DEPTH FEET | FORMATION | SAMPLE NO | FROM | TO | WIDTH | OZS Au |
|-------------|---|-----------|------|----|-------|--------|
| 325.0-335.5 | Finely banded tuff, dsrk greyish, with bands at 45° to core. | | | | | |
| 335.5- | Grano'd. greenish grey coarse grained, some widely spaced Qtz. filled fractures. | | | | | |
| 339.4-340.4 | Grano'd. Med. Q.C. alt'n. A 1" Qtz. vein, and a 1" massive Py. vein at 340.0 that carries about 20 fine specks of V.G. in the wall rock adjoining the massive Py. | 3073 | | | 1.0 | 3.59 |
| 343.0-343.6 | Grano'd. A 1" Qtz. Carb. veinlet, 2% Py. | 3074 | | | .6 | .04 |
| 347.5-348.6 | Grano'd. A 1" and a ½" Qtz. veinlet, 2% Py. 1% PO | 3075 | | | 1.1 | .03 |
| 351.0-351.8 | Grano'd. A 2" Qtz. vein 1% Py. 1% PO. | 3076 | | | .8 | .06 |
| 359.0-360.0 | Grano'd. Med. Q.C. alt'n. Four ½" Qtz. Carb. veinlets, 5% streaks of massive Py. 1% PO. Looks good. | 3077 | | | 1.0 | .03 |
| 369.0-369.8 | Grano'd. A ½" and a ¼" Qtz. veinlet, minor Py. | 3078 | | | .8 | Tr. |
| 375.8-377.1 | Grano'd. Strong Q.C. alt'n. 7% coarse Py. | 3079 | | | 1.3 | Tr. |
| 377.1-378.0 | Grano'd. Two ¼" Qtz. veinlets, 3% Py. | 3080 | | | .9 | Tr. |
| 384.8-385.8 | Grano'd. A 2" glassy Qtz. vein, 1% Py. | 3187 | | | 1.0 | .02 |
| 399.3-401.2 | Grano'd. Med. Q.C. alt'n. Two ½" Qtz. veinlets, 3% Py. | 3188 | | | 1.9 | .01 |

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DIAMOND DRILL RECORD

WINDFALL OILS & MINES LTD.

HOLE NO. 80 - 29 SHEET NO. 4

LATITUDE _____ DATUM _____ STARTED _____
 DEPARTURE _____ BEARING _____ COMPLETED _____
 ELEVATION _____ DIP _____ ULTIMATE DEPTH _____

| DEPTH FEET | FORMATION | SAMPLE NO | FROM | TO | WIDTH | OZS Au |
|-------------|---|-----------|------|----|-------|--------|
| 401.2-402.6 | Grano'd. strong Q.C. alt'n. A 2" and two $\frac{1}{2}$ " Qtz. Carb. veinlets, 5% coarse Py. | 3189 | | | 1.4 | .03 |
| 402.6-403.7 | Grano'd. strong Q.C. alt'n. Three $\frac{1}{2}$ " Qtz. veinlets, 3% coarse Py. | 3190 | | | 1.1 | Tr. |
| 404.3-405.0 | Grano'd. Med. Q.C. alt'n. A $\frac{1}{8}$ " streak of massive Py. | 3191 | | | .7 | Tr. |
| 407.0-408.3 | Grano'd. Strong Q.C. wall rock alt'n. Two 1" Qtz. veinlets, 3% Py. | 3192 | | | 1.3 | .02 |
| 408.3-410.0 | Grano'd. weak Q.C. alt'n. 4% coarse Py. | 3193 | | | 1.7 | Tr. |
| 415.0-415.7 | Grano'd. Med. Q.C. wall rock. Alt'n. 3% Py. | 3194 | | | .2 | Tr. |
| 418.5-419.2 | Grano'd. Med. Q.C. Alt'n. 1% Py. | 3195 | | | .7 | .15 |
| 422.5-423.2 | Grano'd. Med. Q.C. alt'n. A $\frac{1}{2}$ " Qtz. Carb. veinlet minor Py. | 3196 | | | .7 | Tr. |
| 446.8-447.7 | Grano'd. A 1" Qtz. veinlet, med. Q.C. wall rock alt'n. 3% Py. 1% PO. | 3197 | | | .9 | .01 |
| 453.0-453.7 | Grano'd. Med. Q.C. wall rock, alt'n. Two $\frac{1}{4}$ " Qtz. veinlets, 2% Py. 3% PO. | 3198 | | | .7 | Tr. |
| 457.0-458.8 | Grano'd. Med. Q.C. wall rock alt'n. Two $\frac{1}{2}$ " Qtz. veinlets, 2% Py. 2% PO. | 3199 | | | 1.8 | .01 |
| 479.5-480.4 | Grano'd. strong Q.C. alt'n. A 2" Qtz. vein. 5% coarse Py. | 3200 | | | .9 | .01 |

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DIAMOND DRILL RECORD

WINDFALL OILS & MINES LTD.

HOLE NO. 80 - 29 SHEET NO. 5

LATITUDE _____ DATUM _____ STARTED _____
 DEPARTURE _____ BEARING _____ COMPLETED _____
 ELEVATION _____ DIP _____ ULTIMATE DEPTH _____

| DEPTH FEET. | FORMATION | SAMPLE NO | FROM | TO | WIDTH | OZS Au |
|-------------|---|-----------|------|----|-------|--------|
| 489.0-489.6 | Grano'd. A 3" glassy Qtz. vein, 1% Py. | 3201 | | | .6 | .01 |
| 492.1-493.0 | Grano'd. A 6" glassy Qtz. vein, med. Q.C. wall rock alt'n. with 4% coarse Py. | 3202 | | | .9 | Tr. |
| 493.3-494.0 | Grano'd. Med. Q.C. alt'n. 2% Py. | 3203 | | | .7 | .01 |
| 498.5-500.7 | Grano'd. med. Q.C. wall rock alt'n. Two 1/4" Q.C. veinlets, 5% coarse Py. | 3204 | | | 2.2 | .01 |
| 505.0-505.6 | Grano'd. Two 1/8" Qtz. veinlets, 3% Py. | 3205 | | | .6 | .02 |
| 508.6-510.0 | Grano'd. Strong W.C. alt'n. 7% Py. | 3206 | | | 1.4 | .21 |
| 510.0-511.5 | Grano'd. Strong Q.C. alt'n. Two 1/8" Qtz. Carb. veinlets, 7% coarse Py. | 3207 | | | 1.5 | .04 |
| 512.5-514.7 | Grano'd. Three 1/8" Qtz. veinlets, minor Py. | 3208 | | | 2.2 | Tr. |
| 515.5-516.4 | Grano'd. Med. Q.C. alt'n. 4% coarse Py. | 3209 | | | .9 | Tr. |
| 521.8-523.5 | Grano'd. med. Q.C. alt'n. 4% Py. | 3210 | | | 1.7 | .02 |
| 523.5-525.5 | Grano'd. Strong Q.C. alt'n. 10% coarse Py. | 3211 | | | 2.0 | .03 |
| 531.5-532.6 | Grano'd. Strong Q.C. alt'n. with a 1/8" Qtz. Carb. vein, 7% coarse Py. | 3253 | | | 1.1 | .03 |
| 536.0-537.6 | Grano'd. Strong Q.C. alt'n. 7% coarse Py. | 3254 | | | 1.6 | .05 |
| 542.0-543.4 | Grano'd. strong Q.C. alt'n. with a 1/8" Qtz. vein, 7% coarse Py. | 3255 | | | 1.4 | .03 |
| 544.6-545.6 | Grano'd. weak Q.C. alt'n. 3% Py. | 3256 | | | 1.0 | Tr. |
| 549.0-550.2 | Grano'd. Two 1/8" Qtz. veinlets, 1% Py. | 3257 | | | 1.2 | Tr. |

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DIAMOND DRILL RECORD

WINDFALL OILS & MINES LTD.

B-Q CORE

HOLE NO. 80 - 30 SHEET NO. 1

LATITUDE *13217.0*

DATUM *Standard bench, Windfall*

STARTED Nov. 12, 1980

DEPARTURE *11318.0*

BEARING

COMPLETED Nov. 16, 1980

ELEVATION *2274.27*

DIP *59°41'*

ULTIMATE DEPTH 464.0'

| DEPTH FEET | FORMATION | SAMPLE NO | FROM | TO | WIDTH | OZS Au |
|------------|--|-----------|------|----|-------|--------|
| 0 - 29.0 | Casing in overburden. | | | | | |
| 29.0-300.5 | Grano'd. dark greyish, med. grained with some Qtz. filled fractures that run at 50 - 70° to core axis. | | | | | |
| 31.6-32.1 | Grano'd. A ½" Qtz. vein, 1% Fj. | 3476 | | | .5 | .01 |
| 33.0-33.6 | Grano'd. A 1½" Qtz. vein, 1% Py. | 3477 | | | .6 | TR |
| 44.5-46.5 | Grano'd. A 2" and a 1" Qtz. vein, 1% Py. | 3478 | | | 2.0 | TR. |
| 48.8-49.3 | Grano'd. A 1" Qtz. vein, 1% Py. | 3479 | | | .5 | TR. |
| 51.8-52.3 | Grano'd. A 1" Qtz. vein, 2% Py. | 3480 | | | .5 | TR. |
| 55.6-56.1 | Grano'd. A ½" Qtz. vein, 5% streaks of massive Py | 3481 | | | .5 | TR. |
| 57.8-58.3 | Grano'd. A 1" Qtz. vein, 3% streaks of massive Py | 3482 | | | 1.5 | TR. |
| 61.0-61.6 | Grano'd. A 1" Qtz. vein, 3% Py. | 3483 | | | .6 | .02 |
| 69.4-69.9 | Grano'd. A ½" Qtz. vein, that carries 5% Py. | 3484 | | | .5 | .08 |
| 72.7-73.4 | Grano'd. A 1" Qtz. vein, 3% Py. | 3485 | | | .7 | .01 |
| 68.0-69.7 | Grano'd. Four ½" Qtz. veinlets, 3% coarse Py. | 3486 | | | 1.7 | TR. |
| 82.3-83.0 | Grano'd. Two ½" Qtz. veinlets, 3% Py. | 3487 | | | .7 | TR. |
| 92.0-92.9 | Grano'd. strong Q.C. alt'n. Two 1" Qtz. veinlets, 5% coarse Py. | 3488 | | | .9 | .11 |
| 93.2-93.7 | Grano'd. A ½" Qtz. vein, with streaks of massive Py. | 3489 | | | .5 | TR. |
| 95.8-97.4 | Grano'd. Med. Q.C. alt'n. Two ½" Qtz. veinlets | | | | | |

DRILLED BY *[Signature]*



DIAMOND DRILL RECORD

WINDFALL OILS & MINES LTD.

HOLE NO. 80 - 30 SHEET NO. 2

LATITUDE DATUM STARTED

DEPARTURE BEARING COMPLETED

ELEVATION DIP ULTIMATE DEPTH

| DEPTH FEET. | FORMATION | SAMPLE NO | FROM | TO | WIDTH | OZS Au | |
|-------------|---|-----------|------|----|-------|--------|-------|
| | with streaks of massive Py. and PO. | 3490 | | | 1.6 | .03 | |
| 99.4-100.1 | Grano'd. A 1" Qtz. vein. 2% Py. | 3491 | | | .7 | TR. | |
| 105.4-106.5 | Grano'd. Three ½" Qtz. veinlets, 3% Py. 1% PO. | 3492 | | | 1.1 | .02 | |
| 113.5-114.0 | Grano'd. A ½" Qtz. vein, 1% Py. | 3493 | | | .5 | TR. | |
| 116.2-116.8 | Grano'd. A ½" Qtz. vein, 2% Py. | 3494 | | | .6 | TR. | |
| 119.5-120.5 | Grano'd. Two ½" Qtz. veinlets, 1% PO. 2% Py. | 3495 | | | 1.0 | .12 | |
| 128.3-129.5 | Grano'd. Three ½" Qtz. veinlets, One veinlet at | 3496 | | | 1.2 | .02 | } .03 |
| | 128.6 carries a speck of V.C. and a patch of | | | | | .03 | |
| | sphalerite. | | | | | .03 | |
| 134.3-134.8 | Grano'd. A 2" Qtz. vein, 1% Py. | 3497 | | | .5 | TR. | |
| 137.0-137.8 | Grano'd. Three ½" Qtz. veinlets, 2% Py. | 3498 | | | .8 | .02 | |
| 140.2-140.7 | Grano'd. A ½" Qtz. vein, 1% Py. | 3499 | | | .5 | TR. | |
| 146.0-147.4 | Grano'd. A 2" and a ½" Qtz. veinlet, 1% Py. | 3500 | | | 1.4 | TR. | |
| 148.5-150.0 | Grano'd. Streaks of massive Py. in the ½" vein at | 3501 | | | 1.5 | .01 | |
| | 149.7, | | | | | | |
| 155.0-155.6 | Grano'd. A 1" Qtz. vein, 2% Py. | 3502 | | | .6 | TR. | |
| 162.7-164.0 | Grano'd. Three ½" Qtz. veins, 3% Py. | 3503 | | | 1.3 | TR. | |
| 166.0-166.5 | Grano'd. A 1" Qtz. vein, 4% coarse Py. | 3504 | | | .5 | .13 | |
| 169.3-170.0 | Grano'd. A 3" Qtz. vein, 2% Py. | 3505 | | | .7 | .05 | |
| 172.0-172.7 | Grano'd. Med. Q.C. alt'n. A ½" Qtz. vein with | 3506 | | | .7 | .01 | |
| | streaks of massive Py. and some sphalerite. | | | | | | |

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SIGNED _____

DIAMOND DRILL RECORD

WINDFALL OILS & MINES LTD.

HOLE NO. 80 - 30 SHEET NO. 3

LATITUDE DATUM STARTED

DEPARTURE BEARING COMPLETED

ELEVATION DIP ULTIMATE DEPTH

| DEPTH FEET. | FORMATION | SAMPLE NO | FROM | TO | WIDTH | OZS Au | |
|-------------|--|-----------|------|----|-------|--------|--------|
| 177.6-178.2 | Grano'd. Two $\frac{1}{2}$ " Qtz. veinlets, 5% Py. | 3507 | | | .6 | .15 | |
| 193.5-194.2 | Grano'd. A $\frac{3}{4}$ " Qtz. veinlet at 60° to the core carries 50% massive Py. and about 30 specks of V.G. along the vein edges near the massive Py. | 3508 | | | .7 | 6.88 | } 6.83 |
| | Several coarse specks of galena. | | | | | 7.01 | |
| | | | | | | 6.60 | |
| 199.0-199.5 | Grano'd. A $\frac{1}{2}$ " Qtz. vein, 1% Py. | 3509 | | | .5 | .08 | |
| 201.0-201.6 | Grano'd. A $\frac{1}{2}$ " Qtz. vein, 1% Py. | 3510 | | | .6 | 1.57 | |
| 212.0-212.5 | Grano'd. A $\frac{1}{4}$ " Qtz. vein with massive Py. | 3511 | | | .5 | .12 | |
| 216.7-217.3 | Grano'd. A 3" Qtz. vein, 1% Py. | 3512 | | | .6 | .03 | |
| 218.7-219.3 | Grano'd. A $\frac{1}{2}$ " Qtz. vein, 2% Py. | 3513 | | | .6 | .02 | |
| 221.5-223.0 | Grano'd. A 2" and a $\frac{1}{2}$ " Qtz. veinlet, strong Qtz. Carb. alt'n. with large crystals of Py. looks good. | 3514 | | | 1.5 | .07 | |
| 234.7-235.5 | Grano'd. A 1" Qtz. vein, 3% Py. | 3515 | | | .8 | .14 | |
| 237.8-238.6 | Grano'd. Two $\frac{1}{2}$ " Qtz. veinlet, 1% Py. 1% PO. | 3516 | | | .8 | .01 | |
| 242.5-243.0 | Grano'd. A $\frac{1}{2}$ " Qtz. vein, 2% Py. along edge. | 3517 | | | .5 | .02 | |
| 251.5-253.0 | Grano'd. A 2" and a 1" Qtz. veinlet, 4% coarse Py. | 3518 | | | 1.5 | Tr. | |
| 261.2-263.2 | Grano'd. Med. Q.C. alt'n. Two $\frac{1}{2}$ " Qtz. veinlets, 3% Py. | 3519 | | | 2.0 | Tr. | |
| 265.7-266.3 | Grano'd. A 2" Qtz. vein with 10% streaks of massive Py. | 3520 | | | .6 | .26 | |

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DIAMOND DRILL RECORD

WINDFALL OILS & MINES LTD.

HOLE NO. 80 - 30 SHEET NO. 4

LATITUDE DATUM STARTED

DEPARTURE BEARING COMPLETED

ELEVATION DIP ULTIMATE DEPTH

| DEPTH FEET | FORMATION | SAMPLE NO | FROM | TO | WIDTH | OZS Au |
|-------------|--|-----------|------|----|-------|--------|
| 272.5-273.0 | Grano'd. A $\frac{1}{4}$ " vein of massive Py. looks good. | 3521 | | | .5 | .09 |
| 285.5-286.8 | Grano'd. Three $\frac{1}{2}$ " Qtz. veins each with streaks of massive Py. | 3522 | | | 1.3 | .07 |
| 288.8-289.6 | Grano'd. A $\frac{1}{4}$ " and a $\frac{1}{2}$ " Qtz. veinlet, with streaks of massive Py. and traces of sphalerite in each. | 3523 | | | .8 | TR. |
| 293.4-294.7 | Grano'd. strong Q.C. alt'n. 5% coarse Py. cubes. | 3524 | | | 1.3 | .06 |
| 300.5-311.2 | Feldspar porphyry dyke. 30% coarse feldspar pheno's. with a biotitic Qtz. Feldspar ground mass contacts at 45° to core. | | | | | |
| 311.2-464.0 | Grano'd. dark greyish, med. grained Qtz. filled fractures are not too well developed. | | | | | |
| 324.0-325.0 | Grano'd. Two $\frac{1}{2}$ " Qtz. veinlets, 3% Py. A speck of galena. | 3525 | | | 1.0 | TR. |
| 327.0-327.6 | Grano'd. A $\frac{3}{4}$ " Qtz. vein with a patch of massive Py and PO. | 3526 | | | .6 | .12 |
| 329.0-329.7 | Grano'd. Med. Q.C. alt'n. A $\frac{1}{2}$ " Qtz. veinlet, 1% Py. 2% PO. | 3527 | | | .7 | .03 |
| 361.0-361.8 | Grano'd. Med. Q.C. alt'n. A $1\frac{1}{2}$ " Qtz. vein, 4% coarse Py. | 3528 | | | .8 | .17 |
| 386.5-387.0 | Grano'd. A $\frac{1}{2}$ " Qtz. vein, 1% Py. | 3529 | | | .5 | TR. |
| 388.0-388.8 | Grano'd. A 6" Qtz. vein, 2% Py. along edges. | 3530 | | | .8 | TR. |

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DIAMOND DRILL RECORD

WINDFALL OILS & MINES LTD.

HOLE NO. 80 - 30 SHEET NO. 5

LATITUDE DATUM STARTED

DEPARTURE BEARING COMPLETED

ELEVATION DIP ULTIMATE DEPTH

| DEPTH FEET | FORMATION | SAMPLE NO | FROM | TO | WIDTH | OZS Au | |
|-------------|--|-----------|------|----|-------|--------|--------|
| 395.5-396.0 | Grano'd. A 1" Qtz. vein, 1% Py. 2% PO. | 3531 | | | .5 | TR. | |
| 403.0-403.5 | Grano'd. Two ½" Qtz. veins, 1% Py. | 3532 | | | .5 | .10 | |
| 406.5-407.5 | Grano'd. A 1" and a ¼" Qtz. veinlet, 3% Py. 1% PO | 3533 | | | 1.0 | TR. | |
| 410.2-411.0 | Grano'd. Med. Q.C. alt'n. A ½" Qtz. Carb. veinlet | 3534 | | | .8 | TR. | |
| | 4% Py. 1% PO. | | | | | | |
| 414.3-415.3 | Grano'd. Two ½" Qtz. veinlets, 2% Py. | 3535 | | | 1.0 | .01 | |
| 416.0-416.8 | Grano'd. Med. Q.C. alt'n. A 1" Qtz. Carb. veinlet | 3536 | | | .8 | .02 | |
| | 3% Py. 1% PO. | | | | | | |
| 412.0-421.8 | Grano'd. A 3" Qtz. vein with 2% coarse Py. along the edge. | 3537 | | | .8 | TR. | |
| 422.5-423.0 | Grano'd. A 4" glassy Qtz. vein, 1% Py. | 3538 | | | .5 | TR. | |
| 426.0-428.0 | Grano'd. A 4" and a 2" Qtz. vein, 3% coarse Py. | 3539 | | | 2.0 | TR. | |
| 428.0-430.2 | Grano'd. Two 2" Qtz. veins, 1% Py. | 3540 | | | 2.2 | TR. | |
| 435.5-436.1 | Grano'd. A 4" Qtz. vein, 4% coarse Py. in the vein. | 3541 | | | .6 | TR. | |
| 436.8-437.5 | Grano'd. A 5" glassy Qtz. vein, minor Py. | 3542 | | | .7 | .05 | |
| 441.0-441.7 | Grano'd. A 1" Qtz. vein with 7% streaks of massive Py. looks good. | 3543 | | | .7 | .04 | |
| 443.0-444.2 | Grano'd. A 4" glassy Qtz. vein and a ½" massive Py. vein at 443.2 carries 15 specks of fine V.G. and several large specks of galena. | 3544 | | | 1.2 | 3.23 | } 3.23 |
| | | | | | | 3.29 | |
| | | | | | | 3.16 | |

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SIGNED _____

[Handwritten Signature]

DIAMOND DRILL RECORD

WINDFALL OILS & MINES LTD.

BQ core

HOLE NO. 80 - 31 SHEET NO. 1

LATITUDE 13006.72

DATUM Stond in Rock Windfall

STARTED Aug. 12, 1980

DEPARTURE 10206.11

BEARING N 84° 47' E

COMPLETED Aug. 30, 1980


ELEVATION 9896.28

Collar - 59° 44'
@200' = 57°
@400' = 51° Azim 94.5°
114.5

ULTIMATE DEPTH 700.0'

| DEPTH FEET | FORMATION | SAMPLE NO | FROM | TO | WIDTH | OZS. Au |
|------------|--|-----------|------|----|-------|---------|
| 0 - 22.0 | Casing in clay overburden. | | | | | |
| 22.0-234.0 | Grano'd. Greeyish, med. grained, well fractured with QTZ. veinlets filling fractures at 60° to core, some weak Q.C. wall rock Alt'n. with some pyritic mineralization. | | | | | |
| 26.0-27.0 | Grano'd. A ½" QTZ. vein wit. med. Q.C. wall rock Alt'n. 3% coarse PY. | 1159 | | | 1.0 | Tr. |
| 27.0-27.7 | Grano'd. weak Q.C. Alt'n. ¾" QTZ. veinlets 2% coarse PY. | 1160 | | | .7 | Tr. |
| 30.7-31.6 | Grano'd. 2½" QTZ. veinlet 2% coarse PY | 1161 | | | .9 | Tr. |
| 32.5-33.3 | Grano'd. A 2" QTZ. vein with med. Q.C. wall rock Alt'n. 3% coarse PY. Three specks of fine V.G. at 33.0. | 1162 | | | .8 | .02 |
| 33.3-34.0 | Grano'd. 2½" QTZ. veinlet, ½% PY. | 1163 | | | .7 | Tr. |
| 35.3-36.0 | Grano'd. 2½" QTZ. veinlet, 1% PY. | 1164 | | | .7 | Tr. |
| 39.5-40.5 | Grano'd. A 2" QTZ. veinlet 1% PY. | 1165 | | | 1.0 | Tr. |
| 44.5-46.8 | Grano'd. A 1" and ¼" QTZ. veinlet at 50° to core, 1% coarse PY. | 1186 | | | 2.3 | .03 |
| 46.8-48.6 | Grano'd. 40% QTZ. veinlet, with 3% coarse PY. | 1187 | | | 1.8 | Tr. |
| 51.7-52.8 | Grano'd. 2½" QTZ. veinlet with 2" Q.C. wall rock Alt'n. each side that carries 10%, ¼" cubes PY. | 1188 | | | 1.1 | .03 |

DRILLED BY *[Signature]*

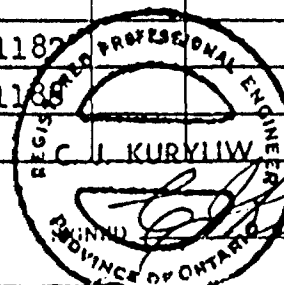

DIAMOND DRILL RECORD

WINDFALL OILS & MINES LTD.

HOLE NO. 80 - 31 SHEET NO. 2

LATITUDE _____ DATUM _____ STARTED _____
 DEPARTURE _____ BEARING _____ COMPLETED _____
 ELEVATION _____ DIP _____ ULTIMATE DEPTH _____

| DEPTH FEET | FORMATION | SAMPLE NO. | FROM | TO | WIDTH | OZS Au |
|------------|---|------------|------|----|-------|--------|
| 56.0-56.5 | Grano'd. A $\frac{1}{4}$ " QTZ. veinlet with some coarse PY. | 1189 | | | .5 | Tr. |
| 62.2-62.8 | Grano'd. A 2" QTZ. vein with some tourmaline, and 2% PO. in bleached wall rock. | 1253 | | | .6 | Tr. |
| 67.8-70.0 | Grano'd. A 3" and 2 $\frac{1}{2}$ " QTZ. veinlet at 65° to core Carry 2% PY. cubes in bleached wall rock. | 1254 | | | 2.2 | Tr. |
| 70.0-71.4 | Grano'd. bleached strong Q.C. Alt'n. A 1" and $\frac{1}{4}$ " QTZ. veinlet 5% cube PY. in wall rock. | 1255 | | | 1.4 | 0.23 |
| 71.4-72.8 | Grano'd. med. Q.C. Alt'n. 3 $\frac{1}{2}$ " QTZ. veinlet, 3% coarse PY. | 1256 | | | 1.4 | 0.05 |
| 72.8-73.6 | Grano'd. A 7" glassy QTZ. vein, some PY. in wall rock. | 1257 | | | .8 | Tr. |
| 73.6-75.1 | Grano'd. 3 $\frac{1}{2}$ " QTZ. veinlet, 2% PY. | 1258 | | | .5 | Tr. |
| 76.5-78.3 | Grano'd. 3 $\frac{1}{2}$ " QTZ. veinlet $\frac{1}{2}$ % PY. | 1259 | | | 1.8 | Tr. |
| 81.5-84.0 | Grano'd. A $\frac{1}{2}$ " and 2 $\frac{1}{4}$ " QTZ. veinlets, $\frac{1}{2}$ % PY. | 1260 | | | 2.5 | Tr. |
| 87.6-88.6 | Grano'd. A 5" QTZ. vein, 2% coarse PY. | 1261 | | | 1.0 | Tr. |
| 92.5-93.0 | Grano'd. 2 $\frac{1}{4}$ " QTZ. veinlets, strong Q.C. wall rock alt'n. 2% PY. 1% magnetite. | 1262 | | | .5 | Tr. |
| 95.4-97.0 | Grano'd. A 1" and 2 $\frac{1}{2}$ " QTZ. veinlet, $\frac{1}{2}$ % PY. | 1263 | | | 1.6 | Tr. |
| 97.0-97.9 | Grano'd. A 3" QTZ. Carb. vein, 2% PY. | 1264 | | | .9 | .01 |
| 97.9-99.5 | Grano'd. A 1" and $\frac{1}{2}$ " QTZ. veinlet, bleached, 2% PY. | 1265 | | | 1.6 | .01 |

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[Signature]

DIAMOND DRILL RECORD

WINDFALL OILS & MINES LTD.

HOLE NO. 80 - 31 SHEET NO. 3

LATITUDE _____ DATUM _____ STARTED _____
 DEPARTURE _____ BEARING _____ COMPLETED _____
 ELEVATION _____ DIP _____ ULTIMATE DEPTH _____

| DEPTH FEET | FORMATION | SAMPLE NO | FROM | TO | WIDTH | OZS Au |
|-------------|---|-----------|------|----|-------|--------|
| 99.5-100.5 | Grano'd. A 2" and a 1" QTZ. vein at 60° to core, 2% large cube PY. | 1266 | | | 1.0 | Tr. |
| 100.5-102.2 | Grano'd. 3½" QTZ. veinlets, 1% PY. | 1267 | | | 1.7 | Tr. |
| 102.2-103.8 | Grano'd. A ½" and 2¼" QTZ. veinlet, ½% PY. | 1268 | | | 1.6 | Tr. |
| 103.8-104.5 | Grano'd. A 6" glassy QTZ. vein, minor PY. | 1269 | | | .7 | Tr. |
| 105.5-107.2 | Grano'd. 4½" QTZ. veinlet, ½% PY. | 1270 | | | 1.7 | Tr. |
| 108.8-110.3 | Grano'd. 2½" QTZ. veinlet, 3% coarse PY. | 1271 | | | 1.5 | .01 |
| 111.7-114.3 | Grano'd. 4½" QTZ. veinlet, 3% coarse PY. in bleached wall rock. | 1272 | | | 2.6 | Tr. |
| 116.0-118.0 | Grano'd. 5½" QTZ. veinlet, with med. wall rock Alt'n. 3% cube PY. | 1273 | | | 2.0 | Tr. |
| 118.0-119.0 | Grano'd. A 5" glassy QTZ. vein, 2% PY. | 1274 | | | 1.0 | .02 |
| 119.3-121.7 | Grano'd. med. bleached Alt'n. 4½" QTZ. veinlet, ½% PY. | 1275 | | | 2.4 | Tr. |
| 121.7-122.9 | Grano'd. 5½" QTZ. veinlets, strong Q.C. wall rock. Alt'n. 5% coarse PY. | 1276 | | | 1.2 | 0.0333 |
| 122.9-123.7 | Grano'd. med. bleached Alt'n. minor QTZ. minor PY | 1277 | | | .6 | .01 |
| 123.7-126.0 | Grano'd. 4½" QTZ. veinlets strong bleached Alt'n. 3% coarse PY. | 1278 | | | 2.3 | .01 |
| 126.0-128.? | Grano'd. Two 1" and three ½" QTZ. veinlets, strong bleached Alt'n. 3% coarse PY. | 1279 | | | 2.2 | .01 |

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DIAMOND DRILL RECORD

WINDFALL OILS & MINES LTD.

HOLE NO. 80 - 31 SHEET NO. 4

LATITUDE _____ DATUM _____ STARTED _____
 DEPARTURE _____ BEARING _____ COMPLETED _____
 ELEVATION _____ DIP _____ ULTIMATE DEPTH _____

| DEPTH FEET | FORMATION | SAMPLE NO. | FROM | TO | WIDTH | OZS Au |
|-------------|--|------------|------|----|-------|--------|
| 128.2-131.0 | Grano'd. A 1" QTZ. veinlet, weak bleached Alt'n. 1% PY. | 1280 | | | 2.8 | Tr. |
| 131.0-132.8 | Grano'd. 4½" QTZ. veinlet, strong bleached, Alt'n. 3% coarse PY. | 1281 | | | 1.8 | Tr. |
| 132.8-134.2 | Grano'd. 2½" and 2¼" QTZ. veinlets, 1% PY. | 1282 | | | 1.4 | Tr. |
| 135.8-136.8 | Grano'd. A 1" QTZ. vein, strong bleached wall rock Alt'n. 7% coarse PY. | 1283 | | | 1.0 | .05 |
| 137.4-138.7 | Grano'd. A 1" and 2½" QTZ. veinlets, 3% PY. | 1284 | | | 1.3 | .04 |
| 138.7-140.0 | Grano'd. Two 3" QTZ. veinlets at 60° to core, with 3% coarse PY. | 1285 | | | 1.3 | .02 |
| 140.0-141.5 | Grano'd. A 1" and 2½" QTZ. veinlets, 2% coarse PY | 1286 | | | 1.5 | .02 |
| 141.5-144.0 | Grano'd. A 3" and 4½" QTZ. veinlets ½% PY. | 1287 | | | 2.5 | Tr. |
| 144.0-146.0 | Grano'd. A ½" and ¼" QTZ. veinlet, 1% coarse PY. | 1288 | | | 2.0 | Tr. |
| 146.0-147.2 | Grano'd. A 1" and 3½" QTZ. veinlets, 2% coarse PY. strong bleached Alt'n. | 1289 | | | 1.2 | .02 |
| 147.3-149.8 | Grano'd. 5½" QTZ. veinlets 2% PY. | 1290 | | | 2.5 | Tr. |
| 151.7-153.3 | Grano'd. A 5" and 3½" QTZ. veinlets, strong bleached Alt'n. 3% coarse PY. | 1291 | | | 1.6 | .01 |
| 153.3-155.2 | Grano'd. Five ¼" QTZ. veinlets, 2% coarse PY. | 1292 | | | 1.9 | Tr. |
| 155.2-157.6 | Grano'd. Three ¼" qtz. veinlets 1% PY. | 1293 | | | 2.4 | Tr. |
| 157.6-159.0 | Grano'd. dark greyish, coarse grained two ¼" QTZ. veinlets. | 1319 | | | 1.4 | Tr. |

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DIAMOND DRILL RECORD

WINDFALL OILS & MINES LTD.

HOLE NO. 80 - 31 SHEET NO. 5

LATITUDE _____ DATUM _____ STARTED _____
 DEPARTURE _____ BEARING _____ COMPLETED _____
 ELEVATION _____ DIP _____ ULTIMATE DEPTH _____

| DEPTH FEET | FORMATION | SAMPLE NO | FROM | TO | WIDTH | OZS Au |
|-------------|---|-----------|------|----|-------|--------|
| 159.0-161.8 | Grano'd. A 2" and five ½" QTZ. veinlets at 60° to core, 1% PY. | 1320 | | | 2.8 | Tr. |
| 161.8-163.7 | Grano'd. 30% QTZ. in veinlets, 5% coarse PY. looks good. | 1321 | | | 1.9 | fr. |
| 163.7-165.0 | Grano'd. Three ½" QTZ. veinlets, 2% coarse PY. | 1322 | | | 1.3 | .03 |
| 165.0-167.2 | Grano'd. Two ½" QTZ. veinlets, ½% PY. | 1323 | | | 2.2 | Tr. |
| 167.2-169.7 | Grano'd. Three ½" QTZ. veinlets 1% PY. ½ tourm. | 1324 | | | 2.5 | Tr. |
| 169.7-172.7 | Grano'd. 10% QTZ. in ½" veinlets, med. Q.C. wall rock Alt'n. 3% coarse PY. | 1325 | | | 3.0 | Tr. |
| 172.7-173.3 | Grano'd. A 1" and Three ½" QTZ. veinlets, 2% coarse PY. | 1326 | | | .6 | .04 |
| 173.3-174.1 | Grano'd. A 2" QTZ. Carb. vein carries a speck of V.G. at 173.7. The wall rock has strong Q.C. Alt'n. and 3% PY. | 1327 | | | .8 | .03 |
| 174.1-175.5 | Grano'd. strong Q.C. wall rock Alt'n. 7% coarse PY. | 1328 | | | 1.4 | .05 |
| 175.5-176.6 | Grano'd. A 6" QTZ. vein, 2% PY. | 1329 | | | 1.1 | .02 |
| 176.6-179.5 | Grano'd. Three ½" QTZ. veinlets 1% coarse PY. | 1330 | | | 2.9 | Tr. |
| 179.5-181.0 | Grano'd. Three ½" QTZ. veinlets, med. Q.C. Alt'n. 5% coarse PY. | 1331 | | | 1.5 | .02 |
| 181.0-182.9 | Grano'd. dark greyish, coarse grained minor QTZ., minor PY. | 1332 | | | 1.9 | Tr. |

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DIAMOND DRILL RECORD

WINDFALL OILS & MINES LTD.

HOLE NO. 80 - 31 SHEET NO. 6

LATITUDE _____ DATUM _____ STARTED _____
 DEPARTURE _____ BEARING _____ COMPLETED _____
 ELEVATION _____ DIP _____ ULTIMATE DEPTH _____

| DEPTH FEET | FORMATION | SAMPLE NO. | FROM | TO | WIDTH | OZS. Au |
|-------------|--|------------|------|----|-------|---------|
| 182.9-185.0 | Grano'd. Three $\frac{1}{2}$ " QTZ. veinlets, at 60° to core 1% PY. | 1333 | | | 2.1 | .01 |
| 185.0-188.4 | Grano'd. dark greyish, minor QTZ. $\frac{1}{2}$ % PY. | 1334 | | | 3.4 | Tr. |
| 188.4-191.0 | Grano'd. dark greyish, minor QTZ. minor PY. | 1335 | | | 2.6 | Tr. |
| 191.0-193.4 | Grano'd. A 3" and a 2" and three $\frac{1}{2}$ " QTZ. veinlets 5% coarse PY. in wall rock. | 1336 | | | 2.4 | .02 |
| 193.4-195.5 | Grano'd. Two $\frac{1}{2}$ " QTZ. veinlets $\frac{1}{2}$ % PY. | 1337 | | | 2.1 | Tr. |
| 195.5-198.0 | Grano'd. dark greyish, three $\frac{1}{2}$ " QTZ. veinlets $\frac{1}{2}$ % PY. | 1338 | | | 2.5 | Tr. |
| 198.0-198.7 | Grano'd. A 3" glassy QTZ. vein, 1% PY. in wall rock. | 1339 | | | .2 | Tr. |
| 198.7-200.4 | Grano'd. dark greyish, minor QTZ. $\frac{1}{2}$ % PY. | 1340 | | | 1.7 | Tr. |
| 200.4-201.4 | Grano'd. 20% QTZ. in fractures, 3% coarse PY. some reddish hematitic Q.C. Alt'n. looks good. | 1341 | | | 1.0 | .02 |
| 201.4-202.4 | Grano'd. strong Q.C. Alt'n. 10% QTZ. in numerous fractures, 3% PY. | 1342 | | | 2.0 | Tr. |
| 203.4-205.5 | Grano'd. dark greyish, minor QTZ., minor PY. | 1343 | | | 2.1 | Tr. |
| 205.5-206.8 | Grano'd. strong Q.C. Alt'n. hematitic 10% QTZ. in fractures, 3% coarse PY. a speck of chalco. | 1344 | | | 1.3 | .03 |
| 206.8-208.5 | Grano'd. Two 1" QTZ. veinlet and two $\frac{1}{2}$ ". 2% PY. | 1345 | | | 1.7 | Tr. |

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DIAMOND DRILL RECORD

WINDFALL OILS & MINES LTD.

HOLE NO. 80 - 31 SHEET NO. 7

LATITUDE _____ DATUM _____ STARTED _____
 DEPARTURE _____ BEARING _____ COMPLETED _____
 ELEVATION _____ DIP _____ ULTIMATE DEPTH _____

| DEPTH FEET | FORMATION | SAMPLE NO. | FROM | TO | WIDTH | OZS Au |
|-------------|---|------------|------|----|-------|--------|
| 208.5-210.0 | Grano'd. Two 3" QTZ. veinlets, strong Q.C. Alt'n 5% coarse PY. looks good. | 1346 | | | 1.5 | Tr. |
| 210.0-212.0 | Grano'd. Two 1/2" QTZ. veinlets, 1% PY. | 1347 | | | 2.0 | Tr. |
| 212.0-214.0 | Grano'd. Three 1/2" QTZ. veinlets 1% PY. | 1348 | | | 2.0 | Tr. |
| 216.7-217.6 | Grano'd. 3/4" QTZ. veinlet with 50% massive PY, looks good. | 1349 | | | .9 | Tr. |
| 217.6-220.0 | Grano'd. med. Q.C. Alt'n. Three 1/2" QTZ. veinlet 1% PY. | 1350 | | | 2.4 | Tr. |
| 220.0-221.0 | Grano'd. 30% QTZ. in veinlets 5% coarse PY, looks good. | 1351 | | | 1.0 | .01 |
| 221.0-222.7 | Grano'd. Two, three" QTZ. veinlets with some 1/2" veinlets 2% PY. | 1352 | | | 1.7 | Tr. |
| 222.7-223.6 | Grano'd. looks barren. | 1353 | | | .9 | Tr. |
| 223.6-225.5 | Grano'd. med. Q.C. Alt'n. Five 1/2" QTZ. veinlets, 5% PY. | 1354 | | | 1.9 | .02 |
| 225.5-228.0 | Grano'd. minor QTZ. minor PY. | 1355 | | | 2.5 | Tr. |
| 228.0-228.8 | Grano'd. A 1" massive PY. vein, carries several specks of V.G. in QTZ. on its edge at 228.4. The veinlet of PY. runs at 60° to core axis. | 1356 | | | .8 | 0.29 |
| 228.8-229.9 | Grano'd. A 3" QTZ. veinlet in med. Q.C. wall rock Alt'n. | 1357 | | | 1.1 | .01 |

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DIAMOND DRILL RECORD

WINDFALL OILS & MINES LTD.

HOLE NO. 80 - 31 SHEET NO. 8

LATITUDE _____ DATUM _____ STARTED _____
 DEPARTURE _____ BEARING _____ COMPLETED _____
 ELEVATION _____ DIP _____ ULTIMATE DEPTH _____

| DEPTH FEET | FORMATION | SAMPLE NO | FROM | TO | WIDTH | OZS Au |
|-------------|--|-----------|------|----|-------|--------|
| 229.9-233.0 | Grano'd. several $\frac{1}{4}$ " QTZ. veinlets, 2% coarse PY. | 1358 | | | 3.1 | .01 |
| 233.0-234.0 | Grano'd. Strong Q.C. Alt'n. 20% QTZ. 2% PY. | 1359 | | | 1.0 | Tr. |
| 234.5-237.0 | Feldspar porphyry dyke. Four $\frac{1}{2}$ " QTZ. veinlets, 1% PY. | 1360 | | | 2.5 | Tr. |
| 240.0-242.0 | Feldspar porphyry. Three $\frac{1}{4}$ " QTZ. veinlets $\frac{1}{2}$ % PY | 1361 | | | 2.0 | .02 |
| 242.0-243.4 | Feldspar porphyry 60% QTZ. in 2" veinlets, 2% coarse PY. | 1362 | | | 1.4 | .07 |
| 243.4-246.3 | Feldspar porphyry, 10% QTZ. in fractures, 2% coarse PY. | 1363 | | | 2.9 | Tr. |
| 234.5-246.3 | Feldspar porphyry dyke, 30% coarse feldspar phenos. Well fractured with QTZ. veinlets and some PY. | | | | | |
| 246.3-266.2 | Grano'd. well fractured and filled with QTZ. veinlets, mineralized with coarse PY. | | | | | |
| 246.3-248.7 | Grano'd. strong Q.C. Alt'n. 20% QTZ. 5% coarse PY. | 1364 | | | 2.4 | .03 |
| 248.7-250.5 | Grano'd. strong Q.C. Alt'n. 15% QTZ. 5% coarse | 1365 | | | 1.8 | .01 |
| 250.5-252.5 | Grano'd. strong Q.C. Alt'n. 50%, 5% coarse PY. looks good. | 1366 | | | 2.0 | .02 |
| 252.5-254.0 | Grano'd. strong pink Q.C. Alt'n. 20% QTZ. 4% coarse PY. | 1367 | | | 1.5 | Tr. |

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DIAMOND DRILL RECORD

WINDFALL OILS & MINES LTD.

HOLE NO. 80 - 31 SHEET NO. 9

LATITUDE _____ DATUM _____ STARTED _____
 DEPARTURE _____ BEARING _____ COMPLETED _____
 ELEVATION _____ DIP _____ ULTIMATE DEPTH _____

| DEPTH FEET | FORMATION | SAMPLE NO. | FROM | TO | WIDTH | OZS. Au |
|-------------|--|------------|------|----|-------|---------|
| 254.0-256.0 | Grano'd. A $\frac{1}{2}$ " QTZ veinlet, $\frac{1}{2}$ % PY. | 1368 | | | 2.0 | Tr. |
| 256.0-258.0 | Grano'd. med. Q.C. Alt'n. 10% QTZ. in veinlets, 5% PY. | 1369 | | | 2.0 | .06 |
| 258.0-260.0 | Grano'd. Three 2" QTZ. veinlets, at 60° to core, 2% coarse PY. | 1370 | | | 2.0 | .02 |
| 260.0-261.6 | Grano'd. Two $\frac{1}{2}$ " QTZ. veinlets, 2% coarse PY. | 1371 | | | 1.6 | Tr. |
| 261.6-264.6 | Grano'd. dark greyish, minor QTZ. minor PY. | 1372 | | | 3.0 | Tr. |
| 264.6-266.2 | Grano'd. A 1" QTZ. veinlet $\frac{1}{2}$ % PY. | 1373 | | | 1.6 | Tr. |
| 263.2-273.0 | The feldspar porphyry dyke, carries 30% coarse feldspar phenos. (269.5 - 270.0 biotitic lamprophyre dyke, cuts through the feldspar porphyry). | | | | | |
| 273.0-275.2 | Grano'd. A 1" and three $\frac{1}{2}$ " QTZ. veinlets at 70° to core, 2% coarse PY. | 1374 | | | 2.2 | Tr. |
| 275.2-276.7 | Grano'd. Two $\frac{1}{2}$ " QTZ. veinlets, 1% PY. | 1375 | | | 1.5 | Tr. |
| 276.7-278.0 | Grano'd. strong Q.C. Alt'n. 30% QTZ. in veinlets, 7% coarse PY. looks good. | 1376 | | | 1.3 | .05 |
| 279.5-281.0 | Grano'd. A 1" and Two $\frac{1}{2}$ " QTZ. veinlets, 2% PY. | 1377 | | | 1.5 | .01 |
| 282.0-283.0 | Grano'd. Two $\frac{1}{2}$ " QTZ. veinlets, 1% PY. | 1378 | | | 1.0 | .01 |
| 284.3-285.8 | Grano'd. A 1" QTZ. veinlet, $\frac{1}{2}$ % PY. | 1379 | | | 1.5 | Tr. |
| 273.0-285.8 | Grano'd. med. to coarse grained numerous QTZ. | | | | | |

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DIAMOND DRILL RECORD

WINDFALL OILS & MINES LTD.

HOLE NO. 8C - 31 SHEET NO. 10

LATITUDE _____ DATUM _____ STARTED _____
 DEPARTURE _____ BEARING _____ COMPLETED _____
 ELEVATION _____ DIP _____ ULTIMATE DEPTH _____

| DEPTH FEET | FORMATION | SAMPLE NO | FROM | TO | WIDTH | OZS Au |
|-------------|---|-----------|------|----|-------|--------|
| | filled fractures at 60° to core, with some coarse PY. in wall rock. | | | | | |
| 285.8-292.5 | Feldspar porphyry, dyke, 40% coarse feldspar phenos in a biotite feldspar matrix. | | | | | |
| 290.5-291.7 | Feldspar porphyry. Three $\frac{1}{8}$ " QTZ. veinlets, 1% PY. | 1380 | | | 1.2 | Tr. |
| 292.0-294.7 | Grano'd. A 1" and two $\frac{1}{8}$ " QTZ. veinlet, 1% PY. | 1381 | | | 2.7 | .01 |
| 294.7-297.0 | Grano'd. Two $\frac{1}{8}$ " QTZ. veinlets, minor PY. | 1382 | | | 2.3 | .01 |
| 297.0-299.0 | Grano'd. med. Q.C. alt'n. three $\frac{1}{8}$ " QTZ. veinlet, 2% PY. | 1383 | | | 2.0 | .01 |
| 299.0-301.5 | Grano'd. weak Q.C. alt'n. Two $\frac{1}{8}$ " QTZ. veinlet, $\frac{1}{8}$ % PY. | 1384 | | | 2.5 | Tr. |
| 302.0-303.0 | Grano'd. A 3" and three $\frac{1}{8}$ " QTZ. veinlets, $\frac{1}{8}$ % PY. | 1385 | | | 1.0 | Tr. |
| 304.8-306.5 | Grano'd. Three $\frac{1}{8}$ " QTZ. veinlets, 1% PY. | 1386 | | | 1.7 | .02 |
| 310.0-314.4 | Grano'd. Two $\frac{1}{8}$ " QTZ. veinlet, 2% PY. | 1387 | | | 1.2 | .02 |
| 316.4-317.1 | Grano'd. A $\frac{1}{8}$ " QTZ. veinlet, 1% coarse PY. | 1388 | | | .7 | Tr. |
| 318.0-318.5 | Grano'd. A $\frac{1}{8}$ " QTZ. veinlet with massive PY. | 1389 | | | .5 | Tr. |
| 321.7-324.4 | Grano'd. A 1" and two $\frac{1}{8}$ " QTZ. veinlets, 2% coarse PY. | 1390 | | | 2.7 | Tr. |
| 324.4-327.0 | Grano'd. A 3" and a 1" QTZ. veinlet with some coarse PY. and tourmaline. | 1391 | | | 2.6 | .03 |

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DIAMOND DRILL RECORD

WINDFALL OILS & MINES LTD.

HOLE NO. 20 - 31 SHEET NO. 11

LATITUDE _____ DATUM _____ STARTED _____
 DEPARTURE _____ BEARING _____ COMPLETED _____
 ELEVATION _____ DIP _____ ULTIMATE DEPTH _____

| DEPTH FEET | FORMATION | SAMPLE NO | FROM | TO | WIDTH | OZ. Au |
|-------------|--|-----------|------|----|-------|--------|
| 332.0-332.9 | Grano'd. A 3" QTZ. veinlet, 2% coarse PY. in wall rock. | 1407 | | | .9 | Tr. |
| 333.3-335.1 | Grano'd. Two 1/4" QTZ. veinlet, minor PY. | 1408 | | | 1.8 | Tr. |
| 337.1-337.9 | Grano'd. A 5" QTZ. vein at 70° to core, 2% coarse PY. | 1409 | | | .8 | Tr. |
| 339.0-339.6 | Grano'd. A 1/2" QTZ. vein at 70° to core, 2% PY. | 1410 | | | .6 | Tr. |
| 343.8-344.8 | Grano'd. Two 1/4" QTZ. veinlets, 2% coarse PY. | 1411 | | | 1.0 | Tr. |
| 346.4-347.7 | Grano'd. Three 1/2" QTZ. veinlets, with some coarse PY. in them. | 1412 | | | 1.3 | Tr. |
| 350.3-351.5 | Grano'd. Two 1/2" QTZ. veinlets, minor PY. | 1413 | | | 1.2 | Tr. |
| 353.4-355.3 | Grano'd. A 3" QTZ. vein at 70° to core. Two 1/4" QTZ. veins, 2% PY. | 1414 | | | 1.9 | Tr. |
| 356.4-357.0 | Grano'd. 1/2" QTZ. veinlet, minor PY. | 1415 | | | .6 | Tr. |
| 359.2-360.0 | Grano'd. A 3/4" QTZ. vein, minor PY. | 1416 | | | .8 | Tr. |
| 360.8-367.0 | Grano'd. Two 1/2" veins at 70°, 3% PY. in wall rock alt'n. | 1417 | | | 1.2 | .03 |
| 362.0-363.0 | Grano'd. A 1/2" QTZ. veinlet, minor PY. | 1418 | | | 1.0 | Tr. |
| 368.2-369.2 | Grano'd. 30% QTZ. in veinlets at 70°, strong wall rock alt'n. with 3% PY, 1% PO. at 367.5, specks of altaite and galena in QTZ. Looks good | 1419 | | | 1.0 | .01 |

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WINDFALL OILS & MINES LTD.

HOLE NO 80 - 31 SHEET NO. 12

LATITUDE _____ DATUM _____ STARTED _____
 DEPARTURE _____ BEARING _____ COMPLETED _____
 ELEVATION _____ DIP _____ ULTIMATE DEPTH _____

| DEPTH FEET | FORMATION | SAMPLE NO. | FROM | TO | WIDTH | OZS. Au |
|-------------|---|------------|------|----|-------|---------|
| 373.8-375.0 | Grano'd. A 2" QTZ. vein at 70° to core, med. wall rock, alt'n, 5% PY. | 1420 | | | 1.2 | Tr. |
| 377.0-377.6 | Grano'd. Two ½" QTZ. veinlets with some coarse PY. | 1421 | | | .6 | Tr. |
| 379.5-380.3 | Grano'd. A 3" QTZ. vein at 70° to core, with strong wall rock alt'n. that carries 2% PY, 1% PO. at 380.0. Three fine specks of V.G. at border of veinlet. | 1422 | | | .8 | .08 |
| 382.2-383.4 | Grano'd. Med. Q.C. alt'n., four ¼" QTZ. veinlets med. Q.C. alt'n. 2% PY, 2% PO. | 1423 | | | 1.2 | Tr. |
| 383.4-385.2 | Grano'd. Four ¼" QTZ. veinlets, 2% PY. | 1424 | | | 1.8 | Tr. |
| 382.8-387.4 | Grano'd. A 1" and two ⅜" QTZ. veinlets at 70° to core, med. wall rock alt'n. 3% coarse PY. | 1425 | | | 1.6 | .01 |
| 388.2-389.5 | Grano'd. One 2" and two ⅜" QTZ. veinlets, med. wall rock alt'n. 2% PY. and 2% PO. | 1426 | | | 1.3 | 1.3 |
| 391.4-392.2 | Grano'd. A 2" and a ⅜" QTZ. vein, 1% PY. | 1427 | | | .8 | Tr. |
| 396.1-397.0 | Grano'd. A 1" and a ⅜" QTZ. vein at 65° to core, 2% coarse PY. | 1428 | | | .9 | .05 |
| 398.0-398.5 | Grano'd. A 2" QTZ. vein, 1% coarse PY. | 1429 | | | .5 | Tr. |
| 401.2-401.7 | Grano'd. A 1" QTZ. vein, 1% PY. | 1430 | | | .5 | Tr. |
| 402.5-403.0 | Grano'd. A ¾" QTZ. vein, 1% PY. | 1431 | | | .5 | Tr. |

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WINDFALL OILS & MINES LTD.

HOLE NO. 80 - 31 SHEET NO. 14

LATITUDE _____ DATUM _____ STARTED _____
 DEPARTURE _____ BEARING _____ COMPLETED _____
 ELEVATION _____ DIP _____ ULTIMATE DEPTH _____

| DEPTH FEET | FORMATION | SAMPLE NO | FROM | TO | WIDTH | OZS Au | |
|-------------|---|-----------|------|----|-------|--------|--|
| 449.8-450.7 | Grano'd. Two $\frac{1}{2}$ " QTZ. veins at 60° to core, minor PY. | 1454 | | | .9 | Tr. | |
| 451.5-453.0 | Andesitic tuff, 20% QTZ. Carb. 2% PO. 1% PY. | 1455 | | | 1.5 | Tr. | |
| 454.7-457.4 | Grano'd. A 1" QTZ. vein at 60° to core, strong Q.C. wall rock alt'n. carries 5% PY. | 1456 | | | .7 | .04 | |
| 462.5-463.0 | Grano'd. A $\frac{1}{2}$ " QTZ. vein, with strong wall rock alt'n. that carries 5% PO. 2% PY. A speck of sphalerite in the QTZ. vein. | 1457 | | | .5 | Tr. | |
| 463.0-463.5 | Grano'd. A $\frac{1}{2}$ " QTZ. vein, with med. Q.C. wall rock alt'n. that carries 2% PY. | 1458 | | | .5 | .01 | |
| 465.4-466.0 | Grano'd. A $\frac{1}{2}$ " QTZ. veinlet, med. Q.C. alt'n. 1% PY. | 1459 | | | .6 | Tr. | |
| 469.5-470.0 | A 1" QTZ. veinlet at 60° to core, 1% PY. | 1460 | | | .5 | Tr. | |
| 473.0-473.5 | Grano'd. Two $\frac{1}{4}$ " QTZ. veinlets, 3% coarse PY. | 1461 | | | .5 | Tr. | |
| 476.0-476.6 | Grano'd. A $\frac{1}{2}$ " QTZ. vein, 1% PY. | 1462 | | | .6 | Tr. | |
| 480.5-481.1 | Grano'd. A 1" QTZ. vein, med. wall rock alt'n. 1% coarse PY. | 1463 | | | .6 | Tr. | |
| 483.6-484.1 | Grano'd. A $\frac{1}{2}$ " QTZ. vein, 1% PY. | 1464 | | | .5 | .01 | |
| 489.0-489.8 | Grano'd. A 1" QTZ. vein, strong Q.C. wall rock alt'n. 5% coarse PY. | 1465 | | | .8 | .06 | |
| 496.5-497.0 | Grano'd. A $\frac{1}{2}$ " QTZ. vein, 3% coarse PY. | 1466 | | | .5 | .03 | |

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DIAMOND DRILL RECORD

WINDFALL OILS & MINES LTD.

HOLE NO. 80 - 31 SHEET NO. 15

LATITUDE _____ DATUM _____ STARTED _____
 DEPARTURE _____ BEARING _____ COMPLETED _____
 ELEVATION _____ DIP _____ ULTIMATE DEPTH _____

| DEPTH FEET | FORMATION | SAMPLE NO | FROM | TO | WIDTH | OZS Au |
|-------------|---|-----------|------|----|-------|--------|
| 498.0-498.7 | Grano'd. A 2" QTZ. vein with strong wall rock alt'n. 1% PY. | 1467 | | | .7 | .10 |
| 503.5-505.0 | Grano'd. 1/2" and two 1/8" QTZ. veinlets, 1/2% PO. 1% PY. | 1543 | | | 1.5 | Tr. |
| 506.6-509.0 | Grano'd. A 1/2" and two 1/8" QTZ. veinlet to 55° to core, 1% PY. | 1544 | | | 2.4 | Tr. |
| 510.0-510.7 | Grano'd. A 1" QTZ. vein with 2% coarse PY. | 1545 | | | 0.7 | .02 |
| 511.8-515.0 | Grano'd. Two 1/2" QTZ. veinlets, some wall rock alt'n. 1/2% PY. | 1546 | | | 3.2 | Tr. |
| 518.2-519.4 | Grano'd. A 2" QTZ. vein with large cubes of PY. in wall rock and a speck of V.G. at 518.5. | 1547 | | | 1.2 | .07 |
| 527.7-528.4 | Grano'd. fault breccia with 30% QTZ. minor PY. | 1548 | | | 0.7 | .06 |
| 531.3-532.0 | Grano'd. A 1" QTZ. vein at 60° to core, 1% PY. | 1549 | | | 0.7 | .06 |
| 292.5-528.0 | Grano'd. medium to coarse grained, greyish with some QTZ. filled fractures at 60° - 70° to core. | | | | | |
| 528.0-545.0 | Grano'd. in part fault zone breccia with a breccia fault at 528.0 that runs at 30° to core and a chloritic black - line fault at 40° to core at 542.0 feet, vuggy breccia zone from 533.0 - 536.0 feet. | | | | | |

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DIAMOND DRILL RECORD

WINDFALL OILS & MINES LTD.

HOLE NO. 80 - 31 SHEET NO. 16

LATITUDE DATUM STARTED

DEPARTURE BEARING COMPLETED

ELEVATION DIP ULTIMATE DEPTH

| DEPTH FEET | FORMATION | SAMPLE NO | FROM | TO | WIDTH | GRS Au |
|-------------|--|-----------|------|----|-------|--------|
| 545.0-567.0 | Grano'd. greyish medium to coarse grained, massive except for a vuggy breccia zone from 557.0 to 559.0. | | | | | |
| 545.0-548.0 | Grano'd. several 1/8" QTZ. filled fractures. | 1550 | | | 3.0 | Tr. |
| 567.0-578.5 | Tuff grano'd. contact at 567.0 is 10° to core and at 578.5 is at 70° to core. Tuff is dark-greenish andesitic composition with calcitic flecks and hairline fractures. | | | | | |
| 578.5-591.0 | Grano'd. medium QTZ. Carb. alt'n. 3% PY. | | | | | |
| 591.0-598.0 | Feldspar porphyry dyke with coarse feldspar and QTZ. phenocrysts and minor PY. | | | | | |
| 586.4-588.0 | Grano'd. strong Q.C. alt'n, pinkish, 3% coarse PY. | 1551 | | | 1.6 | .01 |
| 588.0-589.8 | Grano'd. strong pink Q.C. alt'n. with some narrow QTZ. veinlets at 70° to core, 5% coarse, cubed PY. | 1552 | | | 1.8 | .02 |
| 589.8-591.0 | Grano'd. minor Q.C. alt'n. 1% PY. | 1553 | | | 2.2 | .01 |
| 598.0-610.0 | Andesitic tuff, dark greyish with calcitic flecks | | | | | |
| 610.0- | Grano'd. dark greyish, fine to med. grained, fractured with some QTZ. veinlets. | | | | | |

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DIAMOND DRILL RECORD

WINDFALL OILS & MINES LTD.

HOLE NO. 80 - 31 SHEET NO. 17

LATITUDE DATUM STARTED

DEPARTURE BEARING COMPLETED

ELEVATION DIP ULTIMATE DEPTH

| DEPTH FEET | FORMATION | SAMPLE NO | FROM | TO | WIDTH | OZS Au |
|-------------|---|-----------|------|----|-------|--------|
| 620.5-621.5 | Grano'd. A $\frac{1}{4}$ " QTZ. Carb. veinlet with strong Q.C. wall rock alt'n. which carries 3% coarse PY. | 1554 | | | 1.0 | Tr. |
| 623.8-624.4 | Grano'd. A $\frac{1}{4}$ " QTZ. veinlet with streaks of massive PY. | 1555 | | | 0.6 | .03 |
| 625.0-625.6 | Grano'd. A 1" Q.C. veinlet at 70° to core, $\frac{1}{4}$ % PY. | 1556 | | | 0.6 | Tr. |
| 630.3-631.3 | Grano'd. two $\frac{1}{4}$ " QTZ. veinlets, 2% coarse PY. | 1557 | | | 1.0 | Tr. |
| 634.7-636.2 | Grano'd. Two 2" QTZ. veinlets at 70° TO CORE 1% PY. | 1558 | | | 1.5 | Tr. |
| 637.0-637.6 | Grano'd. A 1" and a $\frac{1}{4}$ " QTZ. veinlet, minor PY. | 1559 | | | 0.6 | Tr. |
| 642.1-643.0 | Grano'd. A 6" glassy QTZ. vein at 70° to core, some coarse, PY along borders. | 1560 | | | 0.9 | Tr. |
| 643.7-645.7 | Grano'd. Three $\frac{1}{4}$ " QTZ. veinlets, with some coarse PY. in immediate wall rock. | 1561 | | | 2.0 | .03 |
| 647.0-647.5 | Grano'd. A $\frac{1}{4}$ " QTZ. veinlet $\frac{1}{4}$ % PY. | 1562 | | | 0.5 | Tr. |
| 650.2-650.9 | Grano'd. A 2" QTZ. vein with 3% PY. in wall rock | 1563 | | | 0.7 | Tr. |
| 653.2-653.9 | Grano'd. A $\frac{1}{4}$ " QTZ. vein, 2% PY. | 1564 | | | 0.7 | .01 |
| 657.7-659.4 | Grano'd. Two 2" QTZ. veins at 70° to core, 3% coarse PY. | 1592 | | | 1.7 | Tr. |
| 662.8-663.4 | Grano'd. A $\frac{1}{2}$ " QTZ. vein at 70° to core, $\frac{1}{2}$ % PY. | 1593 | | | 2.6 | .03 |

DRILLED BY _____

SIGNED 

HOLE No. 80 - 31

| Footage | Dip | Bearing | Azim | Footage | Horiz | Vert. |
|---------|---------|------------|------|-----------|-------|-------|
| Collar | -59°44' | N 84°47' E | | 0-100' | 50.4 | 86.4 |
| 200' | -57° | S-89½°E | 94½ | 100'-300' | 108.9 | 167.7 |
| 400' | -51° | S-70½°E | 114½ | 300'-500' | 125.9 | 155.4 |
| 600' | -46° | S-69°E | 113 | 500 - 700 | | |

DIAMOND DRILL RECORD

WINDFALL OILS & MINES LTD.

B-Q CORE

HOLE NO. 80 - 32 SHEET NO. 1

LATITUDE 12958.73

DATEM *Stored in rack, Windfall.*

STARTED Sept. 1, 1980

DEPARTURE 10186.32

BEARING S. 75° E

COMPLETED Sept. 4., 1980


ELEVATION 9899.88

DIP - 60°
- 47 1/2°

ULTIMATE DEPTH 458.0

| DEPTH FEET | FORMATION | SAMPLE NO | FROM | TO | WIDTH | OZS. Au |
|-------------|--|-----------|------|----|-------|---------|
| 0 - 36.0 | Casing in overburden, clay. | | | | | |
| 36.0-223.0 | Grano'd. dark greyish, fine to med. grained, massive, almost no cross fracturing developed, only some rare irregular Carb. Stringers run along the core. | | | | | |
| 42.3-43.4 | Grano'd. an irregular Qtz. Carb. stringers along core 1/8" Qtz. veinlet, minor Py. | 1637 | | | 1.1 | .01 |
| 97.0-98.7 | Grano'd. some irregular Qtz. Carb. veining along core, minor Py. | 1638 | | | 1.7 | Tr. |
| 220.0-223.0 | Grano'd. cut by a fault that is filled with Qtz. sericite, some weak Qtz. Carb. Alt'n. minor Qtz. minor Py. | 1639 | | | 3.0 | Tr. |
| 223.0-224.0 | Qtz. Sericite dyke, that crosses the core at 30°. This represents a fault zone, with minor Qtz. Carb. Alt'n. in grano'd. | | | | | |
| 224.0-320.5 | Grano'd. dark, greyish med. grained, massive fracturing is absent to rare, At 258.0' breccia fault runs at 70° to core. Some light bleached Alt'n. of wall rock. | | | | | |
| 246.7-248.2 | Grano'd. An irregular 3" Qtz vein runs at 30° to core, and a 1/2" Qtz. filled fracture vein | 1640 | | | | 5 |

DRILLED BY *[Signature]*

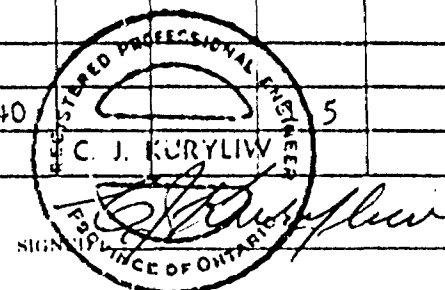

DIAMOND DRILL RECORD

WINDFALL OILS & MINES LTD.

HOLE NO. 80 - 32 SHEET NO. 2

LATITUDE DATUM STARTED

DEPARTURE BEARING COMPLETED

ELEVATION DIP ULTIMATE DEPTH

| DEPTH FEET | FORMATION | SAMPLE NO. | FROM | TO | WIDTH | OZS Au |
|-------------|---|------------|------|----|-------|--------|
| | runs at 70° to core. minor Py. | | | | | |
| 257.3-259.3 | Grano'd. bleached, minor Qtz. Carb. Alt'n. | 1641 | | | 2.0 | Tr. |
| | minor Py. | | | | | |
| 271.0-272.0 | Grano'd. A 1/4" irregular Qtz. Carb. vein runs | 1642 | | | 1.0 | Tr. |
| | at 20° to core, minor Py. | | | | | |
| 312.6-320.4 | Grano'd. bleached vuggy, minor Qtz. Carb. Alt'n | 1647 | | | 2.8 | Tr. |
| | 3% Py. | | | | | |
| 320.5-323.2 | Feldspar porphyry dyke, sericitic in part. | | | | | |
| | 20% coarse feldspar phenocrysts. | | | | | |
| 323.2-332.2 | Grano'd. dark greyish med. grained, massive. | | | | | |
| 332.2-345.0 | Feldspar porphyry dyke. 30% coarse feldspar | | | | | |
| | phenocrysts up to 5mm. diameter. Contacts at | | | | | |
| | 60° to core. | | | | | |
| 345.0-458.0 | Grano'd. dark greyish, med. grained, massive, | | | | | |
| | fractures are very rare. | | | | | |
| 333.8-336.0 | Feldspar porphyry. 5% Qtz. in fractures 2% Py. | 1648 | | | 2.2 | Tr. |
| 350.5-351.0 | Grano'd. A 1/4" vein of massive Py. with Qtz. | 1649 | | | .5 | .60 |
| | Traces of chalco. | | | | | |
| 364.2-364.7 | Grano'd. A 1/4" glassy Qtz. veinlet, at 60° to | 1650 | | | .5 | .04 |
| | core, minor Py. | | | | | |
| 371.7-372.2 | Grano'd. Two 1/8" Qtz. veinlets at 50° to core. | 1651 | | | .5 | .01 |
| | Minor Py. | | | | | |

DRILLED BY

CPK

HOLE 80 - 32

| Footage | Dip. | Bearing | Azim. | Footage | Horiz. | Vert. |
|---------|-------|------------|-------|-----------|--------|-------|
| Collar | | | | 0-100' | | |
| 200' | -66°? | N-122°-E | 126°? | 100'-300' | | |
| 400' | -47½° | N-111° - E | 115° | 300'-458' | | |

DIAMOND DRILL RECORD

WINDFALL OILS & MINES LTD.

3Q Core

HOLE NO. 80 - 33 SHEET NO. 1


LATITUDE 13058.66
 DEPARTURE 10184.00
 ELEVATION 9899.69

DATUM Stored in rock, Windfall
 BEARING S 68° 53' E
 DIP -56° 59'

STARTED _____
 COMPLETED Sept. 7, 1980
 ULTIMATE DEPTH 74.0'

| DEPTH FEET | FORMATION | SAMPLE NO. | FROM | TO | WIDTH | OZS Au |
|------------|--|------------|------|----|-------|--------|
| 0 - 24.0 | Casing in clay overburden. | | | | | |
| 24.0-74.0 | Grano'd. greyish, med. to coarse, grained, fractured, with Qtz. filling the fractures at 60° to core, Some cube Py. mineralization in wall rock of Qtz. fractures. NOTE: This hole was abandoned at 74.0' because the bit, shell and core barrel were burned into the rock. | | | | | |
| 25.0-26.0 | Grano'd. A 1" and a 1/2" Qtz. veinlet, with med. Q.C. alt'n. 3% cube Py. | 1709 | | | 1.0 | .02 |
| 28.3-29.0 | Grano'd. A 1" Qtz. vein with 1% Py. | 1710 | | | .7 | Tr. |
| 29.5-31.0 | Grano'd. A 1" and two 1/2" Qtz. veinlets with med. Q.C. alt'n. 4% coarse Py. | 1711 | | | 1.5 | .09 |
| 36.1-37.2 | Grano'd. A 1" Qtz. vein, med. Q.C. wall rock alt'n. 3% Py. | 1712 | | | 1.1 | .02 |
| 42.6-44.4 | Grano'd. Two 1/2" Qtz. veinlets, med. Q.C. alt'n 1% Py. | 1713 | | | 1.8 | Tr. |
| 47.4-48.0 | Grano'd. A 1" Qtz. vein, at 70° to core, 4% Py. | 1714 | | | .6 | Tr. |
| 49.5-51.0 | Grano'd. Three 1" Qtz. veinlets, 1% Py. | 1715 | | | 1.5 | Tr. |
| 61.0-61.2 | Grano'd. A 1" Qtz. vein at 60° to core, minor Py. | 1716 | | | ? | .02 |

DRILLED BY *W. J. King*

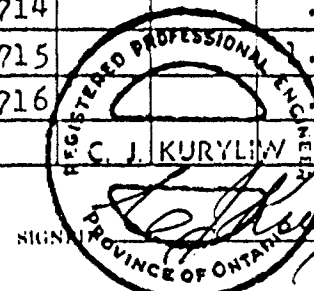

SIGNATURE

HOLE 80 - 33

| Dip | Bearing | Footage |
|-------|----------|---------|
| - 57° | S - 67°E | 0 - 74' |

DIAMOND DRILL RECORD

WINDFALL OILS & MINES LTD.

B Q CORE

HOLE NO. 80 - 33/SHEET NO. 1

LATITUDE 13058.71

DATUM Standard rock, Windfall

STARTED Sept. 8, 1980

DEPARTURE 10183.76

BEARING S. 63° 02' E

COMPLETED Sept. 18, 1980

ELEVATION 9899.71

DIP -62° 29'

ULTIMATE DEPTH 488.1'

| DEPTH FEET | FORMATION | SAMPLE NO. | FROM | TO | WIDTH | OZS Au |
|------------|--|------------|------|----|-------|--------|
| 0 - 23.0 | Casing in clay overburden. | | | | | |
| 24.5-25.3 | Grano'd. strong Q.C. alt'n. with 7% coarse cubes Py. A 1" Qtz. vein at 50' to core, carries 20% magnetite. | 1782 | | | .8 | Tr. |
| 25.3-26.3 | Grano'd. A 3" and a 1/2" glassy Qtz. vein at 60' to the core. 7% coarse cubes of Py. in strong Q.C. wall rock alt'n. | 1783 | | | 1.0 | .02 |
| 28.6-29.8 | Grano'd. A 2" Qtz. vein, 1% Py, 1% PO. | 1784 | | | 1.2 | .01 |
| 29.8-31.5 | Grano'd. Two 1" and one 1/2" Qtz. vein with 3% PO. and 2% Py. | 1785 | | | 1.7 | .06 |
| 36.3-37.7 | Grano'd. A 1" Qtz. Carb. vein with 3% magnetite. 7% coarse cubes of Py. in strong Q.C. wall rock alt'n. | 1786 | | | 1.4 | .01 |
| 43.0-44.8 | Grano'd. A 1" and a 1/2" Qtz. veinlet, 2% Py. 1% PO. | 1787 | | | 1.8 | Tr. |
| 48.3-50.1 | Grano'd. Two 1" Qtz. veins, 2% Py. Trace chalco. | 1788 | | | 1.8 | Tr. |
| 50.7-51.7 | Grano'd. Two 1" Qtz. veins at 50' to core, 2% Py. Traces of chalco Py. | 1789 | | | 1.0 | Tr. |
| 58.6-59.6 | Grano'd. Strong Q.C. wall rock alt'n., 3% Py. | 1790 | | | 1.0 | Tr. |
| 61.7-62.2 | Grano'd. A 1/2" Qtz. vein, 2% Py. | 1791 | | | .5 | Tr. |
| 65.0-66.0 | Grano'd. A 7" Qtz. vein, glassy, at 30" to core, 1% Py. | 1792 | | | 1.0 | 1.79 |

DRILLED BY [Signature]



SIGNED [Signature]
PROVINCE OF ONTARIO

DIAMOND DRILL RECORD

WINDFALL OILS & MINES LTD.

HOLE NO. 80 - 33A SHEET NO. 2

LATITUDE _____ DATUM _____ STARTED _____
 DEPARTURE _____ BEARING _____ COMPLETED _____
 ELEVATION _____ DIP _____ ULTIMATE DEPTH _____

| DEPTH FEET | FORMATION | SAMPLE NO | FROM | TO | WIDTH | UN Au |
|-------------|---|-----------|------|----|-------|-------|
| 70.5-71.0 | Grano'd. A $\frac{1}{2}$ " Qtz. vein, minor Py. | 1793 | | | .5 | .01 |
| 75.7-76.2 | Grano'd. Two $\frac{1}{4}$ " Qtz. veinlets, 1% Py. | 1794 | | | .5 | .01 |
| 92.5-94.0 | Grano'd. An 8" Qtz. vein with some large cubes of Py. in vein. | 1795 | | | 1.5 | Tr. |
| 98.0-99.4 | Grano'd. Two 1" Qtz. veins with strong Q.C. wall rock alt'n. 3% Py. | 1796 | | | 1.4 | .01 |
| 106.5-107.0 | Grano'd. A $\frac{1}{2}$ " Qtz. vein at 70" to core, 1% Py. | 1797 | | | .5 | .01 |
| 110.4-111.0 | Grano'd. A $\frac{1}{2}$ " Qtz. vein, 2% Py. 1% PO. and trace of chalco in vein. | 1798 | | | .6 | Tr. |
| 115.0-115.8 | Grano'd. Two $\frac{1}{4}$ " Qtz. veinlets, one veinlet at 115.5 carries massive Py. with several fine specks of V.G. | 1799 | | | .8 | .82 |
| 116.6-117.2 | Grano'd. Two $\frac{1}{4}$ " Qtz. veinlets, 2% Py. | 1800 | | | 1.1 | .01 |
| 117.2-119.6 | Grano'd. A 1" and a $\frac{1}{4}$ " Qtz. veinlet, at 60" to core, 1% Py. | 1801 | | | 1.9 | Tr. |
| 120.8-121.6 | Grano'd. A 1" Qtz. vein with med. wall rock alt'n., 1% Py. | 1802 | | | .8 | Tr. |
| 123.0-123.9 | Grano'd. A 2" Qtz. vein, with med. wall rock alt'n., 2% Py. | 1803 | | | .9 | Tr. |
| 127.5-128.9 | Grano'd. Four $\frac{1}{4}$ " Qtz. veinlets, 1% Py. | 1804 | | | 1.4 | Tr. |
| 130.4-132.0 | Grano'd. Several 1/8" Qtz. veinlets, 1% Py. | 1805 | | | 1.6 | Tr. |

DRILLED BY _____

SIGNED _____

[Handwritten Signature]

DIAMOND DRILL RECORD

WINDFALL OILS & MINES LTD.

HOLE NO. 80-33A SHEET NO. 3

LATITUDE _____ DATUM _____ STARTED _____
 DEPARTURE _____ BEARING _____ COMPLETED _____
 ELEVATION _____ DIP _____ ULTIMATE DEPTH _____

| DEPTH FEET | FORMATION | SAMPLE NO. | FROM | TO | WIDTH | OZS Au |
|-------------|--|------------|------|----|-------|--------|
| 135.0-136.0 | Grano'd. Two $\frac{1}{2}$ " Qtz. veinlets, 2% Py. | 1806 | | | 1.0 | Tr. |
| 136.0-137.2 | Grano'd. A 5" massive Py. vein at 60° to core, carries several fine specks of V.G. in Qtz. bordering the Py. and also in hairline Qtz. filled fractures in the Py. V.G. at 136.7 | 1807 | | | 1.2 | 6.25 |
| 137.2-138.7 | Grano'd. Three $\frac{1}{2}$ " Qtz. veinlets, 2% Py. | 1808 | | | 1.5 | .01 |
| 138.7-140.3 | Grano'd. Four $\frac{1}{4}$ " Qtz. veinlets, 3% dissem. Py. looks good. | 1809 | | | 1.6 | Tr. |
| 142.0-142.8 | Grano'd. A $\frac{1}{2}$ " Qtz. vein, with med. Q.C. wall rock alt'n. 3% Py. | 1810 | | | .8 | Tr. |
| 146.8-147.3 | Grano'd. Three $\frac{1}{2}$ " Qtz. veinlets, 5% Py. | 1811 | | | .5 | Tr. |
| 150.3-151.1 | Grano'd. A $\frac{1}{2}$ " Qtz. vein at 50° to core carries 4% coarse Py. and several specks of V.G. along its border at 150.5'. | 1812 | | | .8 | .63 |
| 151.1-154.0 | Grano'd. Two 1" and two $\frac{1}{2}$ " Qtz. veinlets with med. W.C. wall rock alt'n. that carries 3% coarse Py. | 1813 | | | 2.9 | .07 |
| 158.5-159.5 | Grano'd. A 1" Qtz. veinlet, with strong Q.C. wall rock alt'n. 3% Py. | 1814 | | | 1.0 | Tr. |
| 159.5-160.7 | Grano'd. An 8" glassy Qtz. vein with large cubes of Py. | 1815 | | | 1.2 | .04 |

DRILLED BY _____

MINED BY *LFH*

DIAMOND DRILL RECORD

WINDFALL OILS & MINES LTD.

HOLE NO. 80-33A SHEET NO. 4

LATITUDE _____ DATUM _____ STARTED _____
 DEPARTURE _____ BEARING _____ COMPLETED _____
 ELEVATION _____ DIP _____ ULTIMATE DEPTH _____

| DEPTH FEET | FORMATION | SAMPLE NO | FROM | TO | WIDTH | OZS Au |
|-------------|--|-----------|------|----|-------|--------|
| 160.7-163.0 | Grano'd., minor Qtz. minor Py. Looks barren. | 1816 | | | 2.3 | Tr. |
| 163.0-163.8 | Grano'd. A 3" Qtz. vein with 4% massive Py. Traces of chalco and sphalerite, and at least 30 specks of V.G. along the edge of the vein at 163.4. The vein runs at 60° to core axis | 1817 | | | .8 | 12.63 |
| 167.0-169.0 | Grano'd. Two ½" Qtz. Carb. veinlets that carry 5% Py. | 1818 | | | 1.0 | Tr. |
| 173.5-174.5 | Grano'd. Two 1" Qtz. veinlets, 3% Py. Traces of sphalerite. | 1819 | | | 1.0 | .02 |
| 174.5-175.4 | Grano'd. A 3" Qtz. vein, 2% Py. | 1820 | | | .9 | .03 |
| 175.4-176.8 | Grano'd. Six ¼" Qtz. veinlets, 2% coarse Py. | 1821 | | | 1.4 | .12 |
| 182.0-183.0 | Grano'd. A 2" and a 1" Qtz. veinlet at 60° to core, the 1" Qtz. veinlet at 182.3 heavily mineralized with dark brown sphalerite and galena and 30% massive Py. It also carries a coarse speck of V.G. assay for gold and silver. | 1822 | | | 1.0 | 2.24 |
| 183.0-183.9 | Grano'd. Three 1/8" Qtz. stringers, 1% Py. | 1823 | | | .9 | Tr. |
| 183.9-185.2 | Grano'd. A 1" and three ½" Qtz. veinlets, with strong Q.C. wall rock alt'n., 5% coarse Py. The 1" vein at 184.2 carries several specks of V.G. next to a large grain of chalco. | 1824 | | | 1.3 | .14 |

DRILLED BY _____

SIGNED _____

DIAMOND DRILL RECORD

WINDFALL OILS & MINES LTD.

HOLE NO. 80-33A SHEET NO. 5

LATITUDE _____ DATUM _____ STARTED _____
 DEPARTURE _____ BEARING _____ COMPLETED _____
 ELEVATION _____ DIP _____ ULTIMATE DEPTH _____

| DEPTH FEET | FORMATION | SAMPLE NO. | FROM | TO | WIDTH | OZS Au |
|-------------|--|------------|------|----|-------|--------|
| 185.2-185.7 | Grano'd. minor Qtz. minor Py. | 1825 | | | .5 | Tr. |
| 185.7-187.3 | Grano'd. Several $\frac{1}{2}$ " Qtz. veinlets with strong Q.C. wall rock alt'n. 5% Py. | 1826 | | | 1.6 | .01 |
| 23.0-115.0 | Grano'd. med. to coarse grained, greyish, with a number of Qtz. filled fractures that run at 50° to 70° to core axis. From 115.0 - (180.0) the Qtz. veins are often mineralized heavily with Py. and in some cases sphalerite, galena and chalco Py. Associated with the base metal mineralization are several veins that carry V.G. | | | | | |
| 188.7-190.4 | Grano'd. Two $\frac{1}{2}$ " Qtz. veinlets, minor Py. | 1827 | | | 1.7 | Tr. |
| 193.5-195.9 | Grano'd. three $\frac{1}{2}$ " Qtz. veinlets, $\frac{1}{2}$ % Py. | 1828 | | | 2.4 | Tr. |
| 195.9-197.5 | Grano'd. A 1" Qtz. vein, with two $\frac{1}{2}$ " Qtz. veins, 2% coarse Py. | 1829 | | | 1.6 | .07 |
| 198.2-199.2 | Grano'd. A 1" Qtz. vein, 2% coarse Py. | 1830 | | | 1.0 | Tr. |
| 205.5-207.7 | Grano'd. Three $\frac{1}{2}$ " Qtz. veinlets, 2% coarse Py. near veins. | 1831 | | | 2.2 | Tr. |
| 209.3-209.9 | Grano'd. Two $\frac{1}{2}$ " Qtz. veinlets, 2% Py. | 1832 | | | .6 | Tr. |
| 212.0-213.0 | Grano'd. strong Q.C. alt'n., 5% Py. | 1833 | | | 1.0 | Tr. |
| 213.0-214.1 | Grano'd. minor Q.C. alt'n. 1% Py. | 1834 | | | 1.1 | .01 |
| 214.1-215.2 | Grano'd. A 2" Qtz. vein with 7% coarse Py. | 1835 | | | 1.1 | .04 |

DILLED BY _____

SIGNED _____

6JK

DIAMOND DRILL RECORD

WINDFALL OILS & MINES LTD.

HOLE NO. 80 - 33A SHEET NO. 6

LATITUDE _____ DATUM _____ STARTED _____
 DEPARTURE _____ BEARING _____ COMPLETED _____
 ELEVATION _____ DIP _____ ULTIMATE DEPTH _____

| DEPTH FEET | FORMATION | SAMPLE NO. | FROM | TO | WIDTH | OZS Au |
|-------------|--|------------|------|----|-------|--------|
| 215.2-217.2 | Grano'd. Three $\frac{1}{2}$ " Qtz. veins at 65° to core, 2% coarse Py. | 1836 | | | 2.0 | .02 |
| 217.2-218.4 | Grano'd. Three $\frac{1}{2}$ " Qtz. veinlets, 2% coarse Py. | 1837 | | | 1.2 | Tr. |
| 218.4-219.7 | Grano'd. minor Qtz. minor Py. | 1838 | | | 1.3 | Tr. |
| 219.7-220.9 | Grano'd. A 2" and three $\frac{1}{2}$ " Qtz. veinlets, 4% coarse Py. | 1839 | | | 1.2 | .02 |
| 222.4-223.9 | Grano'd. A 1" and three $\frac{1}{2}$ " Qtz. veinlets, 3% coarse Py. | 1840 | | | 1.5 | Tr. |
| 223.9-225.3 | Grano'd. A 1" and a $\frac{1}{2}$ " Qtz. veinlet, 1% Py. | 1841 | | | 1.4 | Tr. |
| 227.5-229.6 | Grano'd. A fault breccia zone with weak Q.C. alt'n. 2% Py. | 1842 | | | 2.1 | Tr. |
| 231.0-231.8 | Grano'd. A 2" Qtz. veinlet, 1% Py. | 1843 | | | .8 | Tr. |
| 231.8-232.7 | Grano'd. A 10" glassy Qtz. vein at 60° to core, 2% Py. in wall rock, two specks of V.G. at 232.5' in a narrow pyritic fracture in the vein wall rock. | 1844 | | | .9 | .09 |
| 232.7-234.4 | Grano'd. dark, greyish, minor Qtz. minor Py. | 1845 | | | 1.7 | Tr. |
| 234.4-238.2 | Grano'd. A 1" Qtz. vein at 60° to core, 4% coarse Py. | 1846 | | | .8 | Tr. |
| 235.2-237.4 | Grano'd. minor Qtz. minor Py. | 1847 | | | 2.2 | Tr. |
| 237.4-238. | Grano'd. Four $\frac{1}{2}$ " Qtz. veins, 3% Py. | 1848 | | | 1.5 | Tr. |

DRILLED BY _____

SIGNED _____

[Handwritten Signature]

DIAMOND DRILL RECORD

WINDFALL OILS & MINES LTD.

HOLE NO. 80 - 33A SHEET NO. 8

LATITUDE _____ DATUM _____ STARTED _____
 DEPARTURE _____ BEARING _____ COMPLETED _____
 ELEVATION _____ DIP _____ ULTIMATE DEPTH _____

| DEPTH FEET | FORMATION | SAMPLE NO. | FROM | TO | WIDTH | OZS Au |
|-------------|--|------------|------|----|-------|--------|
| 115.0-185.0 | Grano'd. med. to coarse grained, well fractured, and filled with Qtz. veinlets, the veinlets carry coarse Py. and several sections, carry V.G. usually associated, with traces of base metal, sulphides, chalco Py. sphalerite, and galena. | | | | | |
| 185.0-259.5 | Grano'd. med. to coarse grained greyish, well fractured, with numerous Qtz. veins and pyritic mineralization, largely in Qtz. carbonitized wall rock. The fractures run at 60° to 75° to core, no base metal sulphites were recognized and V.G. is rare. | | | | | |
| 259.5-263.0 | Feldspar porphyry dyke with contacts at 50° to core. | | | | | |
| 263.0-265.5 | Grano'd. | | | | | |
| 265.5-266.5 | Feldspar porphyry dyke. | | | | | |
| 266.5- | Grano'd. dark greyish to greenish grey, med. to coarse grained with Qtz. filled fractures and some Py. mineralization in Qtz. carbonitized wall rock. | | | | | |

DRILLED BY _____

SIGNED _____

C. J. H.

DIAMOND DRILL RECORD

WINDFALL OILS & MINES LTD.

HOLE NO. 80 - 33A SHEET NO. 9

LATITUDE _____ DATUM _____ STARTED _____
 DEPARTURE _____ BEARING _____ COMPLETED _____
 ELEVATION _____ DIP _____ ULTIMATE DEPTH _____

| DEPTH FEET | FORMATION | SAMPLE NO. | FROM | TO | WIDTH | OZS Au |
|-------------|---|------------|------|----|-------|--------|
| 269.3-270.2 | Grano'd. A 5" glassy Qtz. vein at 60° to core, ½% Py. | 1881 | | | .9 | Tr. |
| 270.2-272.9 | Grano'd. Two ¼" Qtz. veinlets, 1% Py. | 1882 | | | 2.7 | Tr. |
| 273.0-273.8 | Grano'd. A 1" Qtz. Carb. vein, minor Py. | 1883 | | | .8 | Tr. |
| 276.0-276.5 | Grano'd. Three ¼" Qtz. veinlets, 2% Py. | 1884 | | | .5 | Tr. |
| 283.5-286.0 | Grano'd. An 8" and a 2" glassy Qtz. vein, 2% coarse Py. | 1885 | | | 2.5 | Tr. |
| 286.0-288.7 | Grano'd. Five ¼" Qtz. veinlets, 1% Py. | 1886 | | | 2.7 | Tr. |
| 292.0-292.9 | Grano'd. A ½" and a ¼" Qtz. veinlets, 2% coarse Py. | 1887 | | | .9 | Tr. |
| 296.0-297.5 | Grano'd. One 2" and three ½" Qtz. veinlets, 3% Py. | 1888 | | | 1.5 | .01 |
| 298.8-299.3 | Grano'd. A 1" Qtz. vein and a ¼" massive Py. vein at 70° to core. | 1889 | | | .5 | .05 |
| 299.3-301.3 | Grano'd. Four ¼" Qtz. veinlets, 2% Py. | 1890 | | | 2.0 | Tr. |
| 301.3-303.3 | Grano'd. An 8" and a 2" glassy Qtz. vein at 70° to core, 2% coarse Py. | 1891 | | | 2.0 | .01 |
| 306.0-307.0 | Grano'd. Strong Q.C. alt'n. 3% large Py. cubes up to ¼" square. | 1892 | | | 1.0 | Tr. |
| 307.5-309.5 | Grano'd. Six ¼" Qtz. veinlets at 70° to core, 2% Py. | 1893 | | | 2.0 | Tr. |

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DIAMOND DRILL RECORD

WINDFALL OILS & MINES LTD.

HOLE NO. 80 -33A SHEET NO. 10

LATITUDE _____ DATUM _____ STARTED _____
 DEPARTURE _____ BEARING _____ COMPLETED _____
 ELEVATION _____ DIP _____ ULTIMATE DEPTH _____

| DEPTH FEET | FORMATION | SAMPLE NO | FROM | TO | WIDTH | OZS Au |
|-------------|---|-----------|------|----|-------|--------|
| 311.0-311.9 | Grano'd. Two $\frac{1}{8}$ " Qtz. veinlets, 3% coarse Py. | 1894 | | | .9 | .01 |
| 313.0-314.5 | Grano'd. A 6" glassy Qtz. veinlet, 1% Py. | 1895 | | | 1.5 | .01 |
| 318.0-320.3 | Grano'd. Four $\frac{1}{8}$ " Qtz. veinlets, 2% Py. | 1896 | | | 2.3 | Tr. |
| 323.0-325.4 | Grano'd. Four $\frac{1}{8}$ " Qtz. veinlets, 3% coarse Py. | 1897 | | | 2.4 | Tr. |
| 326.5-328.0 | Grano'd. A 3" and a 2" Qtz. vein at 60° to the core, 2% Py. | 1898 | | | 1.5 | Tr. |
| 328.4-329.7 | Grano'd. Two 1" and three $\frac{1}{8}$ " Qtz. veinlets, med. Q.C. wall rock alt'n, 2% Py. | 1899 | | | 1.3 | .05 |
| 330.3-332.0 | Grano'd. A $\frac{1}{8}$ " and a $\frac{1}{4}$ " Qtz. veinlet, 2% Py. One fine speck of galena in the vein at 330.7 | 1900 | | | 1.7 | .01 |
| 335.0-337.3 | Grano'd. A 2" and four $\frac{1}{8}$ " Qtz. veinlets, weak Q.C. alt'n, 2% Py. 1% PO. A speck of galena in Qtz. at 336.5 | 1901 | | | 2.3 | Tr. |
| 339.2-340.6 | Grano'd. Two 2" Qtz. veins, with med. Q.C. wall rock alt'n, 3% coarse Py. in wall rock, some black tourmaline. | 1902 | | | 1.4 | Tr. |
| 341.8-343.2 | Grano'd. Five $\frac{1}{8}$ " Qtz. veinlets at 70° to core, med. green Q.C. wall rock alt'n, 2% Py. | 1903 | | | 1.4 | Tr. |
| 344.0-345.5 | Grano'd. A 1" and two $\frac{1}{8}$ " Qtz. veinlets, 1% Py. | 1904 | | | 1.5 | Tr. |
| 345.5-346.3 | Grano'd. Three $\frac{1}{8}$ " Qtz. veinlets, with heavy black tourmaline, minor Py. | 1905 | | | .8 | Tr. |

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WINDFALL OILS & MINES LTD.

HOLE NO. 80 - 33A SHEET NO. 11

LATITUDE _____ DATUM _____ STARTED _____
 DEPARTURE _____ BEARING _____ COMPLETED _____
 ELEVATION _____ DIP _____ ULTIMATE DEPTH _____

| DEPTH FEET | FORMATION | SAMPLE NO | FROM | TO | WIDTH | OZS Au |
|-------------|---|-----------|------|----|-------|--------|
| 347.0-348.0 | Grano'd. A 2" and a ½" Qtz. veinlet, with two chloritic faults that run at 60° to the core. | 1906 | | | 1.0 | .02 |
| 348.0-349.0 | Grano'd. A 3" Qtz. Carb. vein with med. Q.C. wall rock alt'n. 3% Py. | 1907 | | | 1.0 | .02 |
| 349.6-352.5 | Grano'd. Four ¼" Qtz. veinlets. 1% Py. | 1908 | | | 2.9 | Tr. |
| 352.5-354.2 | Grano'd. Strong Q.C. alt'n. 20% Qtz. 2% Py. and black tourmaline. | 1909 | | | 1.7 | .03 |
| 354.2-355.8 | Grano'd. Three ¼" Qtz. veinlets, minor Py. | 1910 | | | 1.6 | .03 |
| 355.8-357.0 | Grano'd. A four" and two ¼" Qtz. veinlets, 3% coarse Py. | 1911 | | | 1.2 | .01 |
| 358.7-360.6 | Grano'd. A 5" and a 3" Qtz. veins at 60° to core, 1% Py. | 1912 | | | 1.9 | Tr. |
| 362.3-363.7 | Grano'd. Four ¼" Qtz. veinlets, 1% Py. | 1913 | | | 1.4 | Tr. |
| 364.0-365.0 | Grano'd. Two ¼" Qtz. veinlets, minor Q.C. alt'n. 1% Py. | 1919 | | | 1.0 | .02 |
| 365.0-366.0 | Grano'd. A ¼" vein of massive Py. and a 3" Qtz. vein each at 60° to the core. | 1920 | | | 1.0 | .10 |
| 366.0-369.3 | Grano'd. Five ¼" Qtz. veinlets, 1% Py. | 1921 | | | 3.3 | .01 |
| 369.3-370.7 | Grano'd. A 5" and two ¼" Qtz. veinlets, 2% Py. | 1922 | | | 1.4 | .01 |
| 370.7-373.3 | Grano'd. dark greyish, three ¼" Qtz. veinlets, minor Py. | 1923 | | | 2.6 | Tr. |

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DIAMOND DRILL RECORD

WINDFALL OILS & MINES LTD.

HOLE NO. 80 - 33A SHEET NO. 12

LATITUDE _____ DATUM _____ STARTED _____
 DEPARTURE _____ BEARING _____ COMPLETED _____
 ELEVATION _____ DIP _____ ULTIMATE DEPTH _____

| DEPTH FEET | FORMATION | SAMPLE NO | FROM | TO | WIDTH | OZS Au |
|-------------|---|-----------|------|----|-------|--------|
| 373.3-374.6 | Grano'd. Three $\frac{1}{2}$ " Qtz. veinlets, med. Q.C. alt'n 2% Py. | 1924 | | | 1.3 | Tr. |
| 378.3-379.7 | Grano'd. Two $\frac{1}{2}$ " Qtz. veinlets, minor Py. | 1925 | | | 1.4 | .01 |
| 399.7-381.0 | Grano'd. A 3" and a two 1" Qtz. veinlets, med. Q.C. alt'n. 2% Py. | 1926 | | | 1.3 | .01 |
| 382.3-383.3 | Grano'd. Two $\frac{1}{2}$ " Qtz. veinlets, med. Q.C. alt'n. 3% Py. | 1927 | | | 1.0 | Tr. |
| 386.6-388.0 | Grano'd. A 4" and a 1" Qtz. veinlets, 1% Py. | 1928 | | | 1.4 | Tr. |
| 389.7-391.7 | Grano'd. Three $\frac{1}{2}$ " Q.C. veinlets, 2% Py. | 1929 | | | 2.0 | Tr. |
| 392.7-394.4 | Grano'd. Two 1" Qtz. veinlets, 2% Py. | 1930 | | | 1.7 | Tr. |
| 396.7-398.0 | Grano'd. A 1" and two $\frac{1}{2}$ " Qtz. veinlets, 2% Py. | 1931 | | | 1.3 | Tr. |
| 398.9-399.5 | Grano'd. A $\frac{1}{2}$ " Qtz. veinlet, with 50% massive Py. in veinlet, and a trace of galena. | 1932 | | | .6 | .04 |
| 401.2-401.8 | Grano'd. A $\frac{1}{2}$ " Qtz. veinlet, 1% Py. | 1933 | | | .6 | Tr. |
| 403.0-403.8 | Grano'd. A 1" and two $\frac{1}{2}$ " Qtz. veinlets, med. Q.C. alt'n. 4% Py. | 1937 | | | .8 | Tr. |
| 408.2-409.2 | Grano'd. A 1" and a $\frac{1}{2}$ " Qtz. veinlets, med. Q.C. alt'n. 2% Py. | 1938 | | | 1.0 | Tr. |
| 409.2-410.2 | Grano'd. A $\frac{1}{2}$ " Qtz. vein, at 409.9, carries 2% galena, 1% Py. and a speck of V.G. | 1939 | | | 1.0 | .08 |

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DIAMOND DRILL RECORD

WINDFALL OILS & MINES LTD.

HOLE NO. 80 - 33A SHEET NO. 13

LATITUDE _____ DATUM _____ STARTED _____
 DEPARTURE _____ BEARING _____ COMPLETED _____
 ELEVATION _____ DIP _____ ULTIMATE DEPTH _____

| DEPTH FEET | FORMATION | SAMPLE NO | FROM | TO | WIDTH | OZS. Au |
|-------------|---|-----------|------|----|-------|---------|
| 410.2-411.4 | Grano'd. Two 1/8" Qtz. veinlets, minor Py. | 1940 | | | 1.2 | Tr. |
| 415.5-416.4 | Grano'd. A 1/2" and two 1/4" Qtz. veinlets with me. Q.C. wall rock alt'n. 2% Py. 1% PO. traces of galena and one fine speck of V.C. at 416.1. | 1941 | | | .9 | Tr. |
| 417.4-418.8 | Grano'd. A 1/2" Qtz. veinlet med. Q.C. alt'n. 2% Py. | 1942 | | | 1.4 | Tr. |
| 418.8-419.9 | Grano'd. A 3/4" and two 1/2" Qtz. veinlets, med. Q.C. alt'n. 1% Py. minor galena. | 1943 | | | 1.1 | Tr. |
| 421.5-422.8 | Grano'd. A 1/2" and three 1/8" Qtz. veinlets with coarse streaks of Py. at 50° to core and Qtz. veinlets at 60° to core. A patch of coarse V.C. at 422.3, a coarse patch of V.C. at the intersection of a pyritic and a Qtz. veinlet, several specks of galena. | 1944 | | | 1.3 | .45 |
| 423.4-423.9 | Grano'd. A 1/8" pyritic veinlet. | 1945 | | | .5 | Tr. |
| 428.9-430.6 | Grano'd. Strong Q.C. alt'n. A 1" Qtz. veinlet and 7% coarse Py. cubes. | 1946 | | | 1.7 | .09 |
| 434.3-434.9 | Grano'd. A 1/8" pyritic Qtz. veinlet at 30° to core. | 1947 | | | .6 | Tr. |
| 438.8-439.8 | Grano'd. Two 1/8" pyritic Qtz. veinlets at 40° to core. | 1948 | | | 1.0 | Tr. |

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C.F.K.

HOLE 80 - 33 A

Tro Pari Tests

| Footage | Dip | Bearing | Azim. | Footage | Horiz. | Vert. |
|---------|-------|---------|-------|-----------|--------|-------|
| Collar | -62½' | S-63° E | | 0-100' | | |
| 200' | -59° | S-74° E | 118° | 100' 300' | | |
| 400' | -58° | S-70° E | 114° | 300'-488' | | |

DIAMOND DRILL RECORD

WINDFALL OILS & MINES LTD.

BQ CORE

HOLE NO. 80 - 34 SHEET NO. 1

LATITUDE 13055.73

DATUM Stored in core rack, Windfall

STARTED Sept. 19, 1980

DEPARTURE 10232.90

BEARING S 69° 27' E

COMPLETED Sept. 25, 1980

ELEVATION 9899.10


DIP -64° 22'

ULTIMATE DEPTH 1148.0'

| DEPTH FEET. | FORMATION | SAMPLE NO | FROM | TO | WIDTH | OZS Au |
|-------------|--|-----------|------|----|-------|--------|
| 0 - 23.0 | Overburden. | | | | | |
| 23.0-42.0 | Grano'd. greyish, med. to coarse. grained, fractures are rare. | | | | | |
| 42.0- | Grano'd. med. to coarse grained, well developed fracturing with numerous Qtz filled veins that carry pyritic mineralization. | | | | | |
| 37.2-37.7 | Grano'd. A 1/4" Qtz. veinlet at 60° to core, 1% Py. | 2012 | | | .5 | Tr. |
| 42.5-44.2 | Grano'd. Several 1/4" Qtz. veinlets, med. Q.C. alt'n. 2% Py. | 2013 | | | .7 | Tr. |
| 45.0-46.5 | Grano'd. A 10" glassy Qtz. vein at 60° to core, 1% Py. in wall rock. | 2014 | | | 1.5 | Tr. |
| 54.5-56.0 | Grano'd. A 2" and two 1/4" Qtz. veinlets, 3% Py. | 2015 | | | 1.5 | .23 |
| 52.0-52.7 | Grano'd. A 1/2" Qtz. vein, 2% Py. | 2016 | | | .7 | .02 |
| 58.5-60.6 | Grano'd. Four 1/4" Qtz. veinlets and one 1/8" veinlet of massive Py. cut at 60° to core. | 2017 | | | 2.1 | Tr. |
| 61.8-62.7 | Grano'd. Three 1/4" Qtz. veinlets, 1% Py. | 2018 | | | .7 | Tr. |
| 63.4-65.4 | Grano'd. A 1" and two 1/4" Qtz. veinlets, 1% Py. | 2019 | | | 2.0 | Tr. |
| 66.3-67.2 | Grano'd. strong Q.C. alt'n. 5% coarse Py. | 2020 | | | .9 | .01 |
| 67.7-69.3 | Grano'd. Two 1/4" Qtz. veinlets, med. Q.C. alt'n. 1% Py. | 2021 | | | .6 | Tr. |

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DIAMOND DRILL RECORD

WINDFALL OILS & MINES LTD.

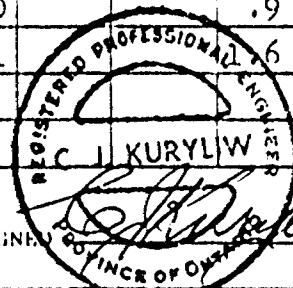
HOLE NO. 80 - 34 SHEET NO. 2

LATITUDE _____ DATUM _____ STARTED _____
 DEPARTURE _____ BEARING _____ COMPLETED _____
 ELEVATION _____ DIP _____ ULTIMATE DEPTH _____

| DEPTH FEET | FORMATION | SAMPLE NO. | FROM | TO | WIDTH | OZS Au |
|------------|--|------------|------|----|-------|--------|
| 71.0-72.5 | Grano'd. strong Q.C. alt'n. several $\frac{1}{2}$ " Qtz. veinlets, 5% coarse Py. | 2022 | | | 1.5 | Tr. |
| 72.5-74.5 | Grano'd. Three $\frac{1}{4}$ " Qtz. veinlets, med. Q.C. alt'n. 3% Py. | 2023 | | | 2.0 | Tr. |
| 75.0-75.7 | Grano'd. A 5" Qtz. veinlet, glassy, 1% Py. in wall rock. | 2024 | | | .7 | Tr. |
| 77.2-78.4 | Grano'd. Four $\frac{1}{4}$ " Qtz. veinlets, One fine speck of galena, 2% Py. | 2025 | | | 1.2 | .10 |
| 79.3-80.3 | Grano'd. A 1" and a $\frac{1}{2}$ " Qtz. veinlets, 2% Py. | 2026 | | | 1.0 | Tr. |
| 80.3-82.0 | Grano'd. Three $\frac{1}{4}$ " Qtz. veinlets, 2% Py. 1% PO. | 2027 | | | 1.7 | Tr. |
| 86.2-87.9 | Grano'd. A 2" Qtz. veinlet at 60" to core, 2% Py. and a speck of chalco. | 2028 | | | 1.7 | .05 |
| 87.9-88.9 | Grano'd. Two 3" and two $\frac{1}{4}$ " Qtz. veinlets at 60" to core. Strong Q.C. wall rock alt'n. 4% coarse Py. in wall rock. | 2029 | | | 1.0 | Tr. |
| 88.9-90.0 | Grano'd. 60% Qtz. in veinlets with light greenish Q.C. wall rock alt'n. 7% Py. looks good. | 2030 | | | 1.1 | Tr. |
| 90.0-90.9 | Grano'd. Three $\frac{1}{4}$ " Qtz. veinlets, 1% Py. | 2031 | | | .9 | .01 |
| 92.0-93.0 | Grano'd. A 3" Qtz. veinlet with 3% coarse Py. | 2032 | | | 1.0 | .02 |
| 93.4-95.2 | Grano'd. A 3" and a 2" Qtz. veinlet. med. Q.C. wall rock alt'n. 5% dissim. Py. | 2033 | | | 1.8 | Tr. |

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DIAMOND DRILL RECORD

WINDFALL OILS & MINES LTD.

HOLE NO. 80 - 34 SHEET NO. 3

LATITUDE _____ DATUM _____ STARTED _____
 DEPARTURE _____ BEARING _____ COMPLETED _____
 ELEVATION _____ DIP _____ ULTIMATE DEPTH _____

| DEPTH FEET | FORMATION | SAMPLE NO. | FROM | TO | WIDTH | OZS. Au | |
|-------------|--|------------|------|----|-------|---------|--|
| 95.6-98.3 | Grano'd. Four $\frac{1}{4}$ " Qtz. veinlets, 5% coarse Py. | 2034 | | | 2.7 | Tr. | |
| 98.9-99.8 | Grano'd. A 2" Qtz. vein at 60" to core with stron | 2035 | | | .9 | .13 | |
| | Q.C. wall rock alt'n. 5% coarse Py. and a fine speck of V.G. at 99.3. | | | | | | |
| 101.5-103.2 | Grano'd. Three $\frac{1}{4}$ " Qtz. veinlet, some Q.C. wall rock alt'n. 2% Py. | 2036 | | | 1.7 | Tr. | |
| 104.8-105.8 | Grano'd. A 2" Qtz. vein with med. Q.C. wall rock alt'n. 4% Py. in wall rock. | 2037 | | | 1.0 | Tr. | |
| 107.2-108.4 | Grano'd. A 1" and a $\frac{1}{4}$ " Qtz. veinlet, med. Q.C. alt'n. 4% coarse Py. | 2038 | | | 1.2 | .06 | |
| 108.8-110.6 | Grano'd. Five $\frac{1}{4}$ " Qtz. veinlets, 3% Py. | 2039 | | | 1.8 | Tr. | |
| 110.6-111.8 | Grano'd. An 8" Qtz. veinlet, 7% coarse Py. looks good. | 2040 | | | 1.2 | .03 | |
| 111.8-113.1 | Grano'd. Several 1/8" Qtz. veinlets, 2% Py. | 2041 | | | 1.3 | Tr. | |
| 114.0-116.0 | Grano'd. A 5" and three $\frac{1}{4}$ " Qtz. veinlets, 4% coarse Py. | 2042 | | | 2.0 | .02 | |
| 116.0-117.0 | Grano'd. A $\frac{1}{2}$ " Qtz. veinlet, 2% Py. | 2043 | | | 1.0 | Tr. | |
| 118.4-119.6 | Grano'd. Three $\frac{1}{2}$ " Qtz. veinlets, 3% coarse Py. | 2044 | | | 1.2 | Tr. | |
| 120.0-121.3 | Grano'd. 30% Qtz. in veinlets, 2% Py. | 2045 | | | 1.3 | Tr. | |
| 122.5-123.0 | Grano'd. A $\frac{1}{2}$ " Qtz. veinlet, $\frac{1}{2}$ % Py. | 2046 | | | .5 | Tr. | |
| 124.0-126.0 | Grano'd. Five $\frac{1}{4}$ " Qtz. veinlets, 2% Py. | 2047 | | | 2.0 | Tr. | |

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DIAMOND DRILL RECORD

WINDFALL OILS & MINES LTD.

HOLE NO. 80 - 34 SHEET NO. 4

LATITUDE _____ DATUM _____ STARTED _____

DEPARTURE _____ BEARING _____ COMPLETED _____

ELEVATION _____ DIP _____ ULTIMATE DEPTH _____

| DEPTH FEET | FORMATION | SAMPLE NO | FROM | TO | WIDTH | OZS. Au |
|-------------|---|-----------|------|----|-------|---------|
| 127.0-128.3 | Grano'd. Three $\frac{1}{2}$ " Qtz. veinlets with black chlorite - tourmaline, 2% Py. | 2048 | | | 1.3 | Tr. |
| 130.5-131.0 | Grano'd. A 1" Qtz. vein with 3% Py. | 2049 | | | .5 | .02 |
| 132.0-133.0 | Grano'd. A 1" and three $\frac{1}{2}$ " Qtz. veinlets, 2% Py. | 2050 | | | 1.0 | .02 |
| 133.0-134.0 | Grano'd. Three $\frac{1}{2}$ " Qtz. veinlets, minor Py. | 2051 | | | 1.0 | .01 |
| 135.0-136.0 | Grano'd. Two $\frac{1}{2}$ " Qtz. veinlets, 1% Py. | 2052 | | | 1.0 | Tr. |
| 139.0-140.3 | Grano'd. A 6" and a 1" glassy Qtz. vein, 1% Py. | 2053 | | | 1.3 | .01 |
| 142.0-142.8 | Grano'd. A $\frac{1}{2}$ " Qtz. vein $\frac{1}{2}$ % Py. | 2054 | | | .8 | Tr. |
| 143.7-145.5 | Grano'd. Three $\frac{1}{2}$ " Qtz. veinlets, 2% Py. | 2055 | | | 1.8 | Tr. |
| 145.5-148.0 | Grano'd. A 1" and a $\frac{1}{2}$ " Qtz. veinlet, 3% coarse Py. | 2056 | | | 2.5 | Tr. |
| 149.8-150.3 | Grano'd. Two $\frac{1}{2}$ " Qtz. veinlets, 1% Py. | 2057 | | | .5 | Tr. |
| 151.8-153.8 | Grano'd. Two 1" and two $\frac{1}{2}$ " Qtz. veinlets, minor Py. | 2058 | | | 2.0 | .01 |
| 156.5-157.2 | Grano'd. A $\frac{1}{2}$ " Carb. vein, 5% coarse Py. | 2059 | | | .7 | .01 |
| 157.2-159.3 | Grano'd. Three $\frac{1}{2}$ " Qtz. veinlets, 2% Py. | 2060 | | | 2.1 | Tr. |
| 160.6-162.8 | Grano'd. Four $\frac{1}{2}$ " Qtz. veinlets, 1% Py. | 2061 | | | 2.2 | Tr. |
| 164.5-166.0 | Grano'd. Four 1" Qtz. veinlets at 60" to core, 4% coarse Py, A trace of sphalerite, looks good. | 2062 | | | 1.5 | Tr. |
| 166.0-167.5 | Grano'd. A 3" Qtz. vein, glassy, minor Py. | 2063 | | | 1.5 | Tr. |
| 167.5-169.0 | Grano'd. Two 1" Qtz. veinlets, 2% coarse Py. | 2064 | | | 1.5 | Tr. |

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DIAMOND DRILL RECORD

WINDFALL OILS & MINES LTD.

HOLE NO. 80 - 34 SHEET NO. 5

LATITUDE _____ DATUM _____ STARTED _____
 DEPARTURE _____ BEARING _____ COMPLETED _____
 ELEVATION _____ DIP _____ ULTIMATE DEPTH _____

| DEPTH FEET | FORMATION | SAMPLE NO | FROM | TO | WIDTH | OZS Au |
|-------------|---|-----------|------|----|-------|--------|
| 169.5-170.5 | Grano'd. Two $\frac{1}{2}$ " Qtz. veinlets, 1% Py. | 2065 | | | 1.0 | Tr. |
| 174.2-174.8 | Grano'd. A $\frac{1}{2}$ " massive Py. veinlet at 70° to core. | 2066 | | | .6 | .31 |
| 175.7-176.3 | Grano'd. Two $\frac{1}{2}$ " Qtz. veinlets, 2% Py. | 2067 | | | .6 | .02 |
| 178.4-179.6 | Grano'd. Three 2" Qtz. veinlets, strong Q.C. | 2068 | | | 1.2 | .01 |
| | wall rock alt'n. light greenish, 4% coarse Py. | | | | | |
| | Looks good | | | | | |
| 184.0-186.5 | Grano'd. A 4" and a two 1" Qtz. veinlets, 1% Py. | 2069 | | | 2.5 | Tr. |
| 193.0-194.0 | Grano'd. Three $\frac{1}{2}$ " Qtz. veinlets, 2% Py. | 2070 | | | 1.0 | Tr. |
| 194.0-195.3 | Grano'd. Two $\frac{1}{2}$ " Qtz. veinlets, 2% Py. | 2119 | | | 1.3 | Tr. |
| 196.5-199.0 | Grano'd. Three $\frac{1}{2}$ " Qtz. veinlets, 1% coarse Py. | 2120 | | | 2.5 | Tr. |
| 199.0-199.8 | Grano'd. A 3" Qtz. veinlet, qt 55° to core. | 2121 | | | .8 | 3.43 |
| | A streak of about 20 specks of <u>V.G.</u> along the edge of the vein and wall rock, 2% Py. | | | | | |
| 199.8-200.6 | Grano'd. A 1" Qtz. vein, 3% Py. | 2122 | | | .8 | Tr. |
| 201.0-203.0 | Grano'd. A 5" and two $\frac{1}{2}$ " Qtz. veins $\frac{1}{2}$ % Py. | 2123 | | | 2.0 | Tr. |
| 206.3-207.6 | Grano'd. A 2" and a 1" Qtz. veinlet, 3% Py. | 2124 | | | 1.3 | .01 |
| 210.0-212.2 | Grano'd. A 2" and two $\frac{1}{2}$ " Qtz. veinlets, 2% Py. | 2125 | | | 2.2 | Tr. |
| 216.6-218.0 | Grano'd. Three $\frac{1}{2}$ " Q.C. veinlets, med. Q.C. alt'n. | 2126 | | | 1.4 | .01 |
| | 3% Py. | | | | | |
| 218.0-220.0 | Grano'd. A 3" and a two " Qtz. veinlet, strong Q.C. alt'n. 7% massive Py. looks good. | 2127 | | | 2.0 | .07 |

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DIAMOND DRILL RECORD

WINDFALL OILS & MINES LTD.

HOLE NO. 80 - 3/4 SHEET NO. 6

LATITUDE _____ DATUM _____ STARTED _____
 DEPARTURE _____ BEARING _____ COMPLETED _____
 ELEVATION _____ DIP _____ ULTIMATE DEPTH _____

| DEPTH FEET | FORMATION | SAMPLE NO | FROM | TO | WIDTH | OZS Au |
|-------------|---|-----------|------|----|-------|--------|
| 220.7-221.8 | Grano'd. A 5" and a 1/2" Qtz. veinlet, 2% Py. | 2128 | | | 1.1 | Tr. |
| 223.0-225.1 | Grano'd. A 1" and three 1/2" Qtz. veinlets, 1% Py. | 2129 | | | 2.1 | Tr. |
| 228.4-230.0 | Grano'd. Three 1/2" Qtz. veinlets, med. Q.C. alt'n. | 2130 | | | 1.6 | Tr. |
| | 4% coarse Py. | | | | | |
| 230.0-231.0 | Grano'd. A 5" Qtz. vein with some coarse Py. and two specks of V.G. near Py. in vein. | 2131 | | | 1.0 | .36 |
| 231.0-232.5 | Grano'd. Two 1/2" Qtz. veinlets, 2% Py. | 2132 | | | 1.5 | Tr. |
| 232.5-234.5 | Grano'd. A 1" and a 1/2" Qtz. veinlet, 1% Py. | 2103 | | | 2.0 | .06 |
| 234.5-237.5 | Grano'd. Four 1/2" and several 1/4" Qtz. veinlets, 3% coarse Py. | 2104 | | | 3.0 | .02 |
| 237.5-239.8 | Grano'd. Three 1/2" Qtz. veinlets, 1% Py. | 2105 | | | 2.3 | Tr. |
| 239.8-242.1 | Grano'd. Four 1/2" Qtz. veinlets, med. Q.C. alt'n. 3% coarse Py. | 2106 | | | 2.3 | Tr. |
| 242.1-244.2 | Grano'd. A 2" and three 1/2" Qtz. veinlets, 2% Py. | 2107 | | | 2.1 | Tr. |
| 244.2-246.0 | Grano'd. Three 1" Qtz. veinlets, med. Q.C. alt'n. 3% coarse Py. | 2108 | | | 1.8 | Tr. |
| 247.0-248.4 | Grano'd. Two 1/2" Qtz. veinlets, 1% Py. | 2109 | | | 1.4 | Tr. |
| 250.4-251.5 | Grano'd. A 1" Q.C. vein, med. Q.C. alt'n. 4% coarse Py. | 2110 | | | 1.1 | Tr. |
| 251.5-253.0 | Grano'd. A 1/2" Qtz. vein, med. Q.C. alt'n. 2% Py. | 2111 | | | 1.5 | Tr. |

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DIAMOND DRILL RECORD

WINDFALL OILS & MINES LTD.

HOLE NO. 80 - 3/4 SHEET NO. 7

LATITUDE _____ DATUM _____ STARTED _____
 DEPARTURE _____ BEARING _____ COMPLETED _____
 ELEVATION _____ DIP _____ ULTIMATE DEPTH _____

| DEPTH FEET | FORMATION | SAMPLE NO | FROM | TO | WIDTH | OZS Au |
|-------------|---|-----------|------|----|-------|--------|
| 253.0-255.0 | Grano'd. Five $\frac{1}{8}$ " Q.C. veinlets at 70' to core, med. Q.C. alt'n. 3% coarse Py. | 2112 | | | 2.0 | Tr. |
| 255.0-257.3 | Grano'd. A 1" and three $\frac{1}{8}$ " Qtz. veinlets, 3% PY. | 2113 | | | 2.3 | Tr. |
| 257.3-258.4 | Grano'd. Two $\frac{1}{4}$ " Qtz. veinlets, weak Q.C. alt'n. 2% coarse Py. | 2114 | | | 1.1 | .01 |
| 259.0-260.5 | Grano'd. A 3" and two $\frac{1}{8}$ " Qtz. veinlets, 5% coarse Py. | 2115 | | | 1.5 | .02 |
| 261.0-263.0 | Grano'd. Four $\frac{1}{4}$ " Qtz. veinlets, med. Q.C. alt'n. 2% Py. | 2116 | | | 2.0 | Tr. |
| 265.3-266.0 | Grano'd. A 1" Qtz. vein, 2% Py. | 2117 | | | .7 | Tr. |
| 269.3-270.4 | Grano'd. A 1" Qtz. Carb. vein, med. Q.C. alt'n. 4% coarse Py. | 2118 | | | 1.1 | .03 |
| 273.0-274.4 | Grano'd. A 1" and Two $\frac{1}{4}$ " Qtz. veinlets, 1% coarse Py. | 2141 | | | 1.4 | Tr. |
| 274.4-275.6 | Grano'd. Two $\frac{1}{4}$ " Qtz. veinlets, minor Py. | 2142 | | | 1.2 | Tr. |
| 275.6-276.7 | Grano'd. A 3" Qtz. vein with med. Q.C. alt'n. 3% coarse Py. some black tourmaline. | 2143 | | | 1.1 | .01 |
| 277.4-278.2 | Grano'd. Two $\frac{1}{4}$ " Qtz. veins, 2% coarse Py. | 2144 | | | .8 | Tr. |
| 280.1-280.9 | Grano'd. A $\frac{1}{8}$ " and two $\frac{1}{8}$ " Qtz. veinlets, minor Py. | 2145 | | | .8 | Tr. |
| 282.7-283.7 | Grano'd. Two $\frac{1}{4}$ " Qtz. veinlets, strong Q.C. alt'n. 5% coarse Py. | 2146 | | | 1.0 | Tr. |

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DIAMOND DRILL RECORD

WINDFALL OILS & MINES LTD.

HOLE NO. 80 - 34 SHEET NO. 8

LATITUDE _____ DATUM _____ STARTED _____
 DEPARTURE _____ BEARING _____ COMPLETED _____
 ELEVATION _____ DIP _____ ULTIMATE DEPTH _____

| DEPTH FEET | FORMATION | SAMPLE NO. | FROM | TO | WIDTH | OZS Au |
|-------------|--|------------|------|----|-------|--------|
| 284.5-285.2 | Grano'd. Two $\frac{1}{4}$ " Qtz. veinlets, med. Q.C. alt'n. 2% Py. | 2147 | | | 1.0 | Tr. |
| 285.8-288.3 | Grano'd. A 3" and five $\frac{1}{2}$ " Qtz. veinlets, 2% Py. | 2148 | | | 2.5 | Tr. |
| 288.3-290.6 | Grano'd. $\frac{1}{2}$ " and four $\frac{1}{4}$ " Qtz. veinlets, 1% coarse Py. | 2149 | | | 1.3 | Tr. |
| 291.0-311.0 | Feldspar porphyry dyke. 30% feldspar phenocrysts up to 6mm. in diameter, some Qtz. filled cross fractures. | | | | | |
| 311.0-316.6 | Grano'd. dark greyish, med. grained with some Qtz. filled fractures. | | | | | |
| 316.6-317.5 | Feldspar porphyry dyke as above. | | | | | |
| 317.5-330.5 | Grano'd. dark greyish, med. grained, numerous Qtz. filled cross fractures at 70° to core axis. | | | | | |
| 291.4-292.1 | Feldspar porphyry. 50% Qtz. 2% Py. | 2150 | | | .7 | .02 |
| 292.2-299.2 | Feldspar porphyry dyke. Four $\frac{1}{2}$ " Qtz. veinlets, 1% Py. | 2151 | | | 2.0 | Tr. |
| 300.4-300.9 | Feldspar porphyry dyke $\frac{1}{2}$ " Qtz. veinlet, minor Py. | 2152 | | | .5 | Tr. |
| 307.8-308.5 | Feldspar porphyry. A 2" and a $\frac{1}{2}$ " Qtz. veinlet, minor Py. | 2153 | | | .7 | .01 |
| 309.8-311.5 | Feldspar porphyry dyke. Three $\frac{1}{2}$ " Qtz. veinlets, 1% Py. | 2154 | | | 1.7 | Tr. |

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DIAMOND DRILL RECORD

WINDFALL OILS & MINES LTD.

HOLE NO. 80 - 34 SHEET NO. 9

LATITUDE _____ DATUM _____ STARTED _____
 DEPARTURE _____ BEARING _____ COMPLETED _____
 ELEVATION _____ DIP _____ ULTIMATE DEPTH _____

| DEPTH FEET | FORMATION | SAMPLE NO. | FROM | TO | WHYTH | OZS Au |
|-------------|---|------------|------|----|-------|--------|
| 312.2-313.0 | Grano'd. Two $\frac{1}{4}$ " Qtz. veinlets, 2% Py. | 2155 | | | .8 | .17 |
| 313.0-314.0 | Grano'd. Three $\frac{1}{4}$ " Qtz. veinlets, 1% Py. | 2156 | | | 1.0 | .02 |
| 315.4-317.0 | Grano'd. Four $\frac{1}{4}$ " Qtz. veinlets, minor Py. | 2157 | | | 1.6 | Tr. |
| 317.3-318.0 | Grano'd. Two $\frac{1}{4}$ " Qtz. veinlets, minor Py. | 2158 | | | .7 | Tr. |
| 320.0-322.0 | Grano'd. Two 1" and four $\frac{1}{4}$ " Qtz. veinlets, in a parallel series at 70° to core, 2% coarse Py. | 2159 | | | 2.0 | Tr. |
| 325.7-326.3 | Grano'd. A $\frac{1}{4}$ " glassy Qtz. vein, minor Py. | 2160 | | | .6 | Tr. |
| 329.4-330.5 | Grano'd. A $\frac{1}{4}$ " Qtz. veinlet, 2% coarse Py. | 2161 | | | .1 | Tr. |
| 333.1-334.0 | Grano'd. A $\frac{1}{4}$ " Qtz. Carb. vein, 2% coarse Py. | 2162 | | | .9 | Tr. |
| 330.5-391.0 | Banded Grano'd. The Grano'd. is composed of a series of uniform multiple alternating banding, composed of bands of dark greyish, fine grained grano'd. that alternates with greyish, med. to coarse grained grano'd. The bands are uniformly $\frac{1}{4}$ " to 2" thick and these runs across the core at 50° to the core axis. The darker fine grained bands appear to have chilled contacts which suggests that the darker finer grained grano'd. was injected into the coarser grained grano'd. The uniformity of the banding widths is pressing the Qtz. filled cross fractures, cut across both | | | | | |

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DIAMOND DRILL RECORD

WINDFALL OILS & MINES LTD.

HOLE NO. 80 - 34 SHEET NO. 10

LATITUDE _____ DATUM _____ STARTED _____
 DEPARTURE _____ BEARING _____ COMPLETED _____
 ELEVATION _____ DIP _____ ULTIMATE DEPTH _____

| DEPTH FEET | FORMATION | SAMPLE NO | FROM | TO | WIDTH | OZS Au |
|-------------|---|-----------|------|----|-------|--------|
| | sets of bands at 70° to the core axis, and the Qtz. filled fractures cut across the bands at 46° to the plane of the bands. | | | | | |
| 336.2-337.2 | Banded grano'd. with two ½" clear grey Qtz. veinlets, One at 336.5 A Qtz veinlet carries numerous specks of V.G. (20) along the wall rock of the veinlet. | 2163 | | | 1.0 | .83 |
| 337.2-338.5 | Grano'd. A ½" Carb. vein, 2% Py. | 2164 | | | 1.3 | .01 |
| 339.8-341.4 | Grano'd. A 1" and a ½" Qtz. veinlet, 1% Py. | 2165 | | | 1.6 | Tr. |
| 342.2-342.9 | Grano'd. A ½" Q.C. vein, strong Q.C. alt'n. 5% coarse Py. | 2166 | | | .7 | .01 |
| 343.2-343.7 | Grano'd. A ½" Qtz. vein, 2% Py. | 2167 | | | .5 | Tr. |
| 344.7-345.3 | Grano'd. A 1" Qtz. vein, 2% Py. | 2168 | | | .6 | .08 |
| 349.3-349.9 | Grano'd. A 1" Qtz. vein, 2% Py. | 2169 | | | .6 | .16 |
| 351.4-352.9 | Grano'd. Three ½" Qtz. veinlets, 1% Py. | 2170 | | | 1.5 | .01 |
| 356.8-357.5 | Grano'd. Two ½" Qtz. veinlets, minor Py. | 2171 | | | .7 | .03 |
| 373.0-373.5 | Grano'd. A ½" Qtz. vein, ½% Py. | 2172 | | | .5 | .04 |
| 374.1-375.5 | Grano'd. Med. Q.C. alt'n. 3% Py. | 2173 | | | 1.4 | .02 |
| 375.5-377.0 | Grano'd. Strong Q.C. alt'n. Two ½" Qtz. veinlets, 4% coarse Py. | 2174 | | | 1.5 | .50 |
| 377.0-378.6 | Grano'd. Med. Q.C. alt'n. 3% Py. | 2175 | | | 1.6 | .24 |

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DIAMOND DRILL RECORD

WINDFALL OILS & MINES LTD.

HOLE NO. 80 - 34 SHEET NO. 11

LATITUDE _____ DATUM _____ STARTED _____
 DEPARTURE _____ BEARING _____ COMPLETED _____
 ELEVATION _____ DIP _____ ULTIMATE DEPTH _____

| DEPTH FEET | FORMATION | SAMPLE NO. | FROM | TO | WIDTH | OZS Au |
|-------------|--|------------|------|----|-------|--------|
| 379.2-381.5 | Grano'd. A $\frac{1}{4}$ " and three 1" Qtz. veinlets, 1% PO., 1% Py. | 2176 | | | 2.3 | .01 |
| 383.0-383.5 | Grano'd. A $\frac{1}{4}$ " Qtz. vein, 1% Py. | 2177 | | | .5 | .15 |
| 388.1-388.7 | Grano'd. A $\frac{1}{4}$ " Qtz. vein, 1% Py. 1% PO. | 2178 | | | .6 | Tr. |
| 389.1-390.5 | Grano'd. 50% Qtz. veinlets, glassy, $\frac{1}{2}$ % Py. | 2179 | | | 1.4 | .01 |
| 392.5-393.2 | Grano'd. A $\frac{1}{4}$ " glassy Qtz. vein, minor Py. | 2180 | | | .7 | .01 |
| 398.7-399.2 | Grano'd. A 1" Qtz. vein, 1% Py. | 2181 | | | .5 | Tr. |
| 402.2-402.7 | Grano'd. A $\frac{1}{4}$ " Qtz. vein, minor Py. | 2182 | | | .5 | Tr. |
| 410.1-411.1 | Grano'd. Four $\frac{1}{4}$ " Qtz. veinlets, 3% coarse Py. | 2183 | | | 1.0 | .02 |
| 418.6-419.3 | Grano'd. A $\frac{1}{4}$ " Qtz. vein, with massive Py. along edges, looks good. | 2184 | | | .7 | .25 |
| 421.0-422.0 | Grano'd. A 1" and two $\frac{1}{4}$ " Qtz. veinlets, 1% PO., 1% Py. and a trace of chalco. | 2185 | | | 1.0 | .40 |
| 391.0- | Grano'd. dark greyish, fine to med. gr. lined, uniformly grained throughout, no banding. | | | | | |
| 425.3-425.8 | Grano'd. A $\frac{1}{4}$ " Qtz. veinlet, minor Py. | 2212 | | | .5 | .04 |
| 429.8-430.3 | Grano'd. A $\frac{1}{4}$ " Qtz. vein, 2% PO. 1% Py. | 2213 | | | .5 | .06 |
| 445.0-448.0 | Andesitic tuff dark greenish, finely banded at 30" to core. This hole has wandered into the foot wall and was stopped. | | | | | |
| | END OF HOLE AT 448.0' | | | | | |

DIGGED BY _____

SIGNED _____

E. J. Kuylen

HOLE 80 -34

Tro Pari Tests

| Footage | Dip | Bearing | Azim. | Footage | Horiz. | Vert. |
|---------|-----|---------|-------|-----------|--------|-------|
| Collar | | | 118° | 0-100' | | |
| 200' | -58 | | 119° | 100'-300' | | |
| 400' | | | | 300'- | | |

DIAMOND DRILL RECORD

WINDFALL OILS & MINES LTD.

HOLE NO. 80 - 35 SHEET NO. 1
(50' W. of 80-33)

LATITUDE 13049.32

DATUM *BQ Core stored in rack. Windfall*

STARTED Sept. 25, 1980

DEPARTURE 10280.63

BEARING S 68° 56' E

COMPLETED Oct. 4, 1980

ELEVATION 9900.51


DIP -59° 45'

ULTIMATE DEPTH 428.0'

| DEPTH FEET. | FORMATION | SAMPLE NO | FROM | TO | WIDTH | OZS Au |
|-------------|--|-----------|------|----|-------|--------|
| 0 - 19.0 | Casing in clay overburden. | | | | | |
| 19.0- | Grano'd. greyish, med. grained with numerous Qtz. filled fractures at 60-70" to core axis. These fractures are well mineralized with coarse Py. along the wall rock. | | | | | |
| 19.5-20.5 | Grano'd. A 6" glassy Qtz. vein with some coarse Py. in wall rock. | 2232 | | | 1.0 | .01 |
| 21.8-23.0 | Grano'd. Two 1" Qtz. veinlets, one with 30% massive Py. looks good. | 2233 | | | 1.2 | .10 |
| 23.0-24.8 | Grano'd. Five 1/8" Qtz. veinlets, 3% Py. | 2234 | | | 1.8 | .08 |
| 27.4-28.2 | Grano'd. Four 1/2" Qtz. veinlets, minor Py. | 2235 | | | 1.8 | .02 |
| 31.3-31.8 | Grano'd. A 1/2" Qtz. vein with 7% massive Py in vein, three specks of <u>U.C.</u> with Py. at 31.5 | 2236 | | | .5 | .70 |
| 33.2-35.2 | Grano'd. Four 1/2" Qtz. veinlets, 2% Py. | 2237 | | | 2.0 | Tr. |
| 36.0-37.2 | Grano'd. A 5" glassy Qtz. vein, and a 1/2" Qtz. vein, 3% Py. in wall rock. | 2238 | | | 1.2 | .02 |
| 38.4-39.0 | Grano'd. A 1/2" Qtz. vein, 2% Py. | 2239 | | | .6 | .01 |
| 39.8-41.2 | Grano'd. Three 1/2" Qtz. veinlets, minor Py. | 2240 | | | 1.4 | Tr. |
| 43.0-43.5 | Grano'd. A 3/4" Qtz. vein with 2% Py. | 2241 | | | .5 | Tr. |
| 44.2-46.2 | Grano'd. Three 1/2" Qtz. veinlets, 2% Py. | 2242 | | | .5 | Tr. |

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DIAMOND DRILL RECORD

WINDFALL OILS & MINES LTD.

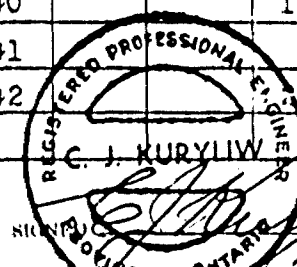HOLE NO. 80 -35 SHEET NO. 2

LATITUDE _____ DATUM _____ STARTED _____
 DEPARTURE _____ BEARING _____ COMPLETED _____
 ELEVATION _____ DIP _____ ULTIMATE DEPTH _____

| DEPTH FEET | FORMATION | SAMPLE NO | FROM | TO | WIDTH | OZS Au |
|-------------|---|-----------|------|----|-------|--------|
| 47.0-48.4 | Grano'd., a strong Q.C. alt'n. three 1" Qtz. veinlets, 2% coarse Py. some black tourmaline. | 2243 | | | 1.4 | Tr. |
| 49.7-50.2 | Grano'd. A 1/2" Qtz. vein, 2% Py. minor chalco. | 2244 | | | .5 | Tr. |
| 54.2-55.2 | Grano'd. Two 1/4" Qtz. veinlets, minor Py. | 2245 | | | 1.0 | Tr. |
| 56.8-58.4 | Grano'd. A 6" and a 3" Qtz. vein with strong Q.C. wall rock alt'n. 2% Py. | 2246 | | | 1.6 | Tr. |
| 64.3-65.2 | Grano'd. A 2" glassy Qtz. vein, minor Py. | 2247 | | | .9 | Tr. |
| 66.5-67.0 | Grano'd. Two 1/8" Qtz. veinlets, 1% Py. | 2248 | | | .5 | Tr. |
| 73.0-74.2 | Grano'd. Two 2" Qtz. veinlets with med. Q.C. wall rock alt'n. 1% PO. 3% Py. in wall rock. | 2249 | | | 1.2 | Tr. |
| 76.2-77.0 | Grano'd. A 1" and two 1/2" Qtz. veinlets, 1% Py. | 2250 | | | .8 | Tr. |
| 80.5-81.2 | Grano'd. A 1" and two 1/4" Qtz. veinlets, 1% Py. | 2251 | | | .7 | Tr. |
| 88.3-88.9 | Grano'd. A 2" Qtz. vein, 5% coarse Py. | 2252 | | | .6 | .06 |
| 89.4-91.0 | Grano'd. A 2" and two 1/2" Qtz. veinlets, med. Q.C. alt'n. 2% coarse Py. | 2253 | | | 1.6 | Tr. |
| 91.7-94.0 | Grano'd. A 5" and three 1/2" Qtz. veinlets, with some weak Q.C. alt'n. 3% coarse Py. | 2254 | | | 2.3 | .08 |
| 95.1-96.0 | Grano'd. Two 1/2" Qtz. veinlets, 2% coarse Py. | 2255 | | | .9 | Tr. |
| 98.2-99.3 | Grano'd. Four 1/2" Qtz. veinlets, 1% Py. | 2256 | | | 1.1 | Tr. |
| 100.8-102.3 | Grano'd. Four 1/2" Qtz. veinlets, two with streaks of massive Py. | 2257 | | | 1.5 | Tr. |

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DIAMOND DRILL RECORD
WINDFALL OILS & MINES LTD.


HOLE NO. 80 - 35 SHEET NO. 3

LATITUDE _____ DATUM _____ STARTED _____
 DEPARTURE _____ BEARING _____ COMPLETED _____
 ELEVATION _____ DIP _____ ULTIMATE DEPTH _____

| DEPTH FEET | FORMATION | SAMPLE NO | FROM | TO | WGT | OZS Au |
|-------------|---|-----------|------|----|-----|--------|
| 104.3-104.9 | Grano'd. A 1/2" Qtz. vein, with streaks of massive Py. | 2258 | | | .6 | Tr. |
| 106.4-107.0 | Grano'd. Two 1/2" Qtz. veinlets, minor Py. | 2259 | | | .6 | Tr. |
| 107.7-108.7 | Grano'd. A 7" glassy Qtz. vein, minor Py. on edges. | 2260 | | | 1.0 | Tr. |
| 115.3-116.1 | Grano'd. A 2" Qtz. vein, with a hairline fracture at the side, 1% Py and one fine speck of V.C. at 115.6. | 2261 | | | .8 | .07 |
| 116.8-117.6 | Grano'd. A 1/2" Qtz. vein at 70° to core with three specks of fine V.C. along its edge at 117.0. | 2274 | | | .8 | .15 |
| 118.4-119.5 | Grano'd. 50% Qtz. in veinlets, 1% Py. | 2275 | | | 1.1 | Tr. |
| 122.0-123.0 | Grano'd. A 1/2" and two 1/4" Qtz. veinlets, minor Py. | 2276 | | | 1.0 | Tr. |
| 123.7-125.4 | Grano'd. Two 1/4" Qtz. veinlets, minor Py. | 2277 | | | 1.7 | .01 |
| 125.4-126.4 | Grano'd. A 6" glassy Qtz. vein, 3% coarse Py. | 2278 | | | 1.0 | .02 |
| 127.0-128.0 | Grano'd. Two 1/4" Qtz. veinlets, 2% coarse Py. | 2279 | | | 1.0 | Tr. |
| 129.1-131.7 | Grano'd. Four 1/4" Qtz. veinlets, 2% coarse Py. | 2280 | | | 1.6 | Tr. |
| 135.1-135.9 | Grano'd. A 3" and a 1" Qtz. veinlet with med. Q.C. wall rock alt'n. at 135.4, the 1" Qtz. veinlet has an area of massive Py. that carries 3 specks of V.C. within the Py. | 2281 | | | .8 | .18 |
| 136.3-136.9 | Grano'd. A 1/2" Qtz. vein, 1% Py. | 2282 | | | .6 | Tr. |

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DIAMOND DRILL RECORD

WINDFALL OILS & MINES LTD.

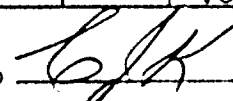HOLE NO. 80 - 35. SHEET NO. 4

LATITUDE _____ DATUM _____ STARTED _____
 DEPARTURE _____ BEARING _____ COMPLETED _____
 ELEVATION _____ DIP _____ ULTIMATE DEPTH _____

| DEPTH FEET | FORMATION | SAMPLE NO. | FROM | TO | WIDTH | OZS. Au |
|-------------|--|------------|------|----|-------|---------|
| 139.0-140.0 | Grano'd. 50, 0+ in veinlets, 3% Py. Med. Q.C. alt'n. | 2283 | | | 2.0 | Tr. |
| 145.8-148.2 | Grano'd. Six 1/4" Qtz. veinlets, 3% Py. | 2284 | | | 2.4 | Tr. |
| 149.1-150.6 | Grano'd. A 5" and a 1" vein, 2% Py. | 2285 | | | 1.5 | Tr. |
| 151.8-153.1 | Grano'd. A 1" Qtz. vein, 2% Py. | 2286 | | | 1.3 | Tr. |
| 153.8-154.3 | Grano'd. A 1/2" Qtz. vein, minor Py. | 2287 | | | .5 | Tr. |
| 154.3-154.8 | Grano'd. A 1/2" Qtz. vein with strong hematitic alt'n. | 2262 | | | .5 | Tr. |
| 155.2-157.7 | Grano'd. A 1" and a 1/2" Qtz. veinlets, 1% Py. | 2263 | | | 2.0 | Tr. |
| 157.7-158.6 | Grano'd. A 1/2" veinlet, 1% coarse Py. | 2264 | | | .9 | Tr. |
| 158.6-159.5 | Grano'd. A 4" and a 1/2" Qtz. veinlet at 70° to core, 3% coarse Py. at 158.9, the 1/2" veinlet carries about 20 fine specks of V.C. along the wall rock edge of vein. | 2265 | | | .9 | .98 |
| 159.5-160.3 | Grano'd. looks barren. | 2266 | | | .8 | Tr. |
| 160.3-161.2 | Grano'd. A 2" Qtz. vein, 2% coarse Py. | 2267 | | | .9 | Tr. |
| 161.2-163.0 | Grano'd. Three 1/8" Qtz. veinlets, minor Py. | 2268 | | | 1.8 | Tr. |
| 163.0-164.0 | Grano'd. A 1" Carb. vein with 5% coarse Py. and a speck of altaite, looks good. | 2269 | | | 1.0 | Tr. |
| 164.0-165.0 | Grano'd. Med. grained, greyish, looks barren. | 2270 | | | 1.0 | Tr. |
| 165.0-167.2 | Grano'd. Three 1/4" Qtz. veinlets, 2% coarse Py. | 2271 | | | 2.2 | Tr. |

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DIAMOND DRILL RECORD

WINDFALL OILS & MINES LTD.

HOLE NO. 80 - 35 SHEET NO. 5

LATITUDE _____ DATUM _____ STARTED _____
 DEPARTURE _____ BEARING _____ COMPLETED _____
 ELEVATION _____ DIP _____ ULTIMATE DEPTH _____

| DEPTH FEET | FORMATION | SAMPLE NO | FROM | TO | WIDTH | OZS Au |
|-------------|--|-----------|------|----|-------|--------|
| 167.2-169.0 | Grano'd. One 3" and four 1" Qtz. veinlets, 3% Py. | 2272 | | | 1.8 | Tr. |
| 170.7-171.5 | Grano'd. A 1" and a 1/2" Qtz. veinlet, 3% Py. | 2273 | | | .8 | Tr. |
| 174.6-175.6 | Grano'd. Med. Q.C. alt'n. 5% coarse Py. | 2288 | | | 1.0 | .04 |
| 175.6-176.8 | Grano'd. Three 2" Qtz. veinlets, strong Q.C. | 2289 | | | 1.2 | .07 |
| | alt'n. 10% coarse Py. several fine specks of V.C. in two patches along the edge of Qtz. at 176.2 | | | | | |
| 176.8-178.6 | Grano'd. A 1/2" and two 1/4" Qtz. veinlets, 1% Py. | 2290 | | | 1.8 | Tr. |
| 181.6-183.3 | Grano'd. A 6" and three 1/2" Qtz. veinlets, 3% coarse Py. | 2291 | | | 1.7 | Tr. |
| 184.4-186.0 | Grano'd. A 2" and two 1" Qtz. veinlets, 3% coarse Py. Traces of chalco. | 2292 | | | 1.6 | .02 |
| 186.0-188.3 | Grano'd. Three 1/2" Qtz. veinlets, 1% Py. | 2293 | | | 2.3 | Tr. |
| 190.5-191.6 | Grano'd. Three 1/2" Qtz. veinlets, 3% coarse Py. | 2294 | | | 1.1 | Tr. |
| 193.9-194.6 | Grano'd. A 5" glassy Qtz. vein, at 60° to core, minor Py. | 2377 | | | .7 | Tr. |
| 195.3-196.0 | Grano'd. Two 1/2" Qtz. veinlets, 2% Py. | 2378 | | | .7 | Tr. |
| 197.8-199.2 | Grano'd. Three 1/2" Qtz. veinlets, med. Q.C. alt'n. 2% coarse Py. | 2379 | | | 1.4 | .03 |
| 199.7-201.5 | Grano'd. Four 1/2" Qtz. veinlets, 1% Py. | 2380 | | | 1.8 | Tr. |
| 203.8-205.3 | Grano'd. A four " and two 1" Qtz. veinlets, 4% coarse Py. | 2381 | | | 1.5 | .03 |

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DIAMOND DRILL RECORD

WINDFALL OILS & MINES LTD.

HOLE NO. 80 - 35 SHEET NO. 6

LATITUDE _____ DATUM _____ STARTED _____
 DEPARTURE _____ BEARING _____ COMPLETED _____
 ELEVATION _____ DIP _____ ULTIMATE DEPTH _____

| DEPTH FEET | FORMATION | SAMPLE NO | FROM | TO | WIDTH | OZS Au |
|-------------|--|-----------|------|----|-------|--------|
| 208.4-209.6 | Grano'd. A 2" and three $\frac{1}{8}$ " Qtz. veinlets, 3% coarse Py. | 2332 | | | 1.2 | .01 |
| 210.4-211.2 | Grano'd. A 4" glassy Qtz. vein with 3% Py. in wall rock. | 2383 | | | .8 | Tr. |
| 212.5-214.0 | Grano'd. Four $\frac{1}{2}$ " glassy Qtz. veins, 3% Py. | 2384 | | | 1.5 | Tr. |
| 214.6-216.2 | Grano'd. Two $\frac{1}{4}$ " and two $\frac{1}{8}$ " Qtz. veinlets, 2% Py. | 2385 | | | 1.6 | Tr. |
| 216.7-218.3 | Grano'd. A 1" and three $\frac{1}{8}$ " Qtz. veinlets, 1% Py. | 2386 | | | 1.6 | Tr. |
| 218.8-220.6 | Grano'd. Four $\frac{1}{4}$ " Qtz. veinlets, 1% Py. | 2387 | | | 1.8 | Tr. |
| 221.3-221.9 | Grano'd. Two $\frac{1}{4}$ " Qtz. veinlets, minor Py. | 2388 | | | .6 | Tr. |
| 222.8-224.2 | Grano'd. A 5" and two 1" Qtz. veinlets at 60" to core, 4% coarse Py. a single speck of V.G. at 223.0' in a $\frac{1}{8}$ " vein. | 2389 | | | 1.4 | .05 |
| 227.0-227.8 | Grano'd. Four $\frac{1}{4}$ " Qtz. veinlets, minor Py. | 2390 | | | .8 | .10 |
| 228.5-229.6 | Grano'd. Med. Q.C. alt'n. Four $\frac{1}{4}$ " Qtz. veinlets, 2% Py. | 2391 | | | 1.1 | Tr. |
| 230.0-231.3 | Grano'd. Three $\frac{1}{8}$ " Qtz. veinlets, minor Py. | 2392 | | | .3 | Tr. |
| 233.0-233.9 | Grano'd. A 3" glassy Qtz. vein, minor Py. | 2393 | | | .9 | .01 |
| 235.5-236.3 | Grano'd. Two $\frac{1}{4}$ " Qtz. vein, 2% coarse Py. | 2394 | | | .8 | Tr. |
| 238.1-239.1 | Grano'd. A 1" and a $\frac{1}{2}$ " Qtz. veinlet, 1% Py. | 2395 | | | 1.0 | .04 |
| 242.0-242.5 | Grano'd. A $\frac{1}{2}$ " glassy Qtz. vein, 2% Py. | 2396 | | | .5 | Tr. |
| 243.6-244.2 | Grano'd. A 1" Qtz. vein, minor Py. | 2397 | | | .6 | .03 |

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DIAMOND DRILL RECORD

WINDFALL OILS & MINES LTD.

HOLE NO. 80 - 35 SHEET NO. 7

LATITUDE _____ DATUM _____ STARTED _____
 DEPARTURE _____ BEARING _____ COMPLETED _____
 ELEVATION _____ DIP _____ ULTIMATE DEPTH _____

| DEPTH FEET | FORMATION | SAMPLE NO. | FROM | TO | WIDTH | OZS Au | |
|-------------|--|------------|------|----|-------|--------|--|
| 244.6-245.2 | Grano'd. A 1" Qtz. Carb. veinlet, 5% coarse Py. | 2398 | | | .6 | .03 | |
| 248.5-249.0 | Grano'd. A 1" Qtz. vein, minor Py. | 2399 | | | .5 | .83 | |
| 250.0-250.5 | Grano'd. Med. Q.C. alt'n. 5% coarse Py. | 2400 | | | .5 | .77 | |
| 252.4-253.3 | Grano'd. Two 1" Qtz. veinlets, 2% coarse Py. | 2401 | | | .9 | .25 | |
| 259.3-260.0 | Grano'd. A 3/4" massive Py. vein with med. Q.C. | 2402 | | | .7 | .07 | |
| | wall rock alt'n. | | | | | | |
| 262.0-262.5 | Grano'd. A 1/2" Qtz. veinlet with some massive Py. | 2403 | | | .5 | .02 | |
| 263.4-264.0 | Grano'd. A 3" glassy Qtz. vein, with a streak of | 2404 | | | .6 | .66 | |
| | massive Py. along its centre that carries 3 fine | | | | | | |
| | specks of <u>V.G.</u> at 263.7. | | | | | | |
| 268.0-268.7 | Grano'd. Strong Q.C. alt'n. 5% coarse Py. | 2405 | | | .7 | Tr. | |
| 271.0-271.5 | Grano'd. A 1" glassy Qtz. vein, minor Py. | 2406 | | | .5 | .07 | |
| 275.5-277.0 | Grano'd. Three 1" glassy Qtz. veinlets at 70° to | 2407 | | | 1.5 | Tr. | |
| | core, minor Py. | | | | | | |
| 282.2-283.0 | Grano'd. Two 1/2" Qtz. veinlets, one with massive | 2408 | | | .8 | .03 | |
| | Py. | | | | | | |
| 288.5-297.5 | Feldspar porphyry dyke. 30% coarse feldspar pheno | | | | | | |
| | crysts. contacts at 70° to core. | | | | | | |
| 305.5-306.4 | Grano'd. Two 1/2" Qtz. veinlets, 2% coarse Py. | 2409 | | | .9 | .04 | |
| 306.3-307.0 | Grano'd. Med. Q.C. alt'n. 5% coarse Py. | 2410 | | | .7 | Tr. | |
| 310.6-312.3 | Grano'd. Two 1/2" Qtz. veinlets, 1% Py. | 2411 | | | 1.7 | .04 | |

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DIAMOND DRILL RECORD

WINDFALL OILS & MINES LTD.

HOLE NO. 80 -35 SHEET NO. 8

LATITUDE _____ DATUM _____ STARTED _____
 DEPARTURE _____ BEARING _____ COMPLETED _____
 ELEVATION _____ DIP _____ ULTIMATE DEPTH _____

| DEPTH FEET | FORMATION | SAMPLE NO | FROM | TO | WIDTH | OZS. Au |
|-------------|---|-----------|------|----|-------|---------|
| 319.1-320.6 | Grano'd. Two $\frac{1}{2}$ " Qtz. veinlets, 1% Py. | 2412 | | | 1.5 | .02 |
| 323.3-324.2 | Grano'd. Two $\frac{1}{2}$ " Qtz. veinlets, 2% Py. | 2413 | | | .9 | .03 |
| 333.0-333.6 | Grano'd. Two $\frac{1}{2}$ " Qtz. veinlets, minor Py. | 2414 | | | .6 | Tr. |
| 352.0-352.5 | Grano'd. A 4" glassy Qtz. vein, minor Py. | 2415 | | | .5 | Tr. |
| 360.0-360.5 | Grano'd. A 1" glassy Qtz. vein, minor Py. | 2416 | | | .5 | .25 |
| 364.0-364.5 | Grano'd. A 1" Qtz. vein that carries 5% streaks of massive Py. | 2417 | | | .5 | 1.12 |
| 297.5-396.0 | Grano'd. dark greyish, fine to med. grained, The fracturing is not as well developed. The grano'd. is more massive. | | | | | |
| 384.6-385.1 | Grano'd. A 2" glassy Qtz. vein, minor Py. | 2451 | | | .5 | Tr. |
| 391.3-392.0 | Grano'd. A 6" glassy Qtz. vein, minor Py. | 2452 | | | .7 | Tr. |
| 396.0-397.0 | Feldspar porphyry dyke, coarse grained, pinkish due to alt'n. | | | | | |
| 397.0-400.7 | Grano'd. greyish, med. grained. | | | | | |
| 400.7-403.3 | Feldspar porphyry dyke, coarse grained, contacts at 60° to core. | | | | | |
| 403.3-403.0 | Grano'd. greyish, fine grained. partly alt'n. to siricitic. | | | | | |
| 413.0-414.5 | Feldspar porphyry dyke, coarse grained. | | | | | |

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C. J. K.

HOLE 80 - 35

| Footage | Dip | Bearing | Azim. | Footage | Horis. | Vert. |
|---------|---------|------------|-------|---------|--------|-------|
| Collar | -59°45' | S-68°56' E | | 0-100' | | |
| 200' | -58° | S E | 122° | 100-300 | | |
| 400' | -55° | S E | 119½° | 300 | | |

DIAMOND DRILL RECORD

WINDFALL OILS & MINES LTD.

BQ Core

HOLE NO. PO - 36 SHEET NO. 1

LATITUDE 13058.04

DATUM stored in rack windfall

STARTED Sept. 24, 1980

DEPARTURE 10135.37

BEARING S 67° 15' E

COMPLETED Oct. 13, 1980


ELEVATION 9898.03

DIP -66° 28'

ULTIMATE DEPTH 577.4'

| DEPTH FEET. | FORMATION | SAMPLE NO | FROM | TO | WIDTH | OZS Au |
|-------------|--|-----------|------|----|-------|--------|
| 0 - 20.0 | Overburden | | | | | |
| 20.0- | Grano'd. Med. to coarse grained well fractured with numerous Qtz. filled fractures at 70° to core and pyritic mineralization throughout. | | | | | |
| 20.0-21.7 | Grano'd. Four $\frac{1}{8}$ " Qtz. veinlets, 1% Py. | 2186 | | | 1.7 | .01 |
| 21.7-23.0 | Grano'd. Two $\frac{1}{8}$ " Qtz. veinlets, 1% Py. | 2187 | | | 1.3 | Tr. |
| 24.8-26.2 | Grano'd. Three $\frac{1}{8}$ " Qtz. veinlets, 2% Py. | 2188 | | | 1.4 | .01 |
| 27.0-28.7 | Grano'd. A 2" and three $\frac{1}{8}$ " Qtz. veinlets, med. Q.C. alt'n. 1% Py. | 2189 | | | 1.7 | Tr. |
| 28.7-30.0 | Grano'd. A 10" glassy Qtz. vein, 3% coarse Py. in wall rock and specks of galena along edge of vein. | 2190 | | | 1.3 | .01 |
| 31.0-32.7 | Grano'd. Three $\frac{1}{8}$ " Qtz. veinlets, 1% Py. | 2191 | | | 1.7 | Tr. |
| 33.1-33.6 | Grano'd. A $\frac{1}{8}$ " Qtz. veinlet, 2% coarse Py. | 2192 | | | .5 | Tr. |
| 37.0-38.6 | Grano'd. Four $\frac{1}{8}$ " Qtz. veinlets, minor Py. | 2193 | | | 1.6 | Tr. |
| 39.3-40.0 | Grano'd. Two $\frac{1}{8}$ " Qtz. veinlets, 2% Py. | 2194 | | | .7 | Tr. |
| 41.0-42.0 | Grano'd. Two $\frac{1}{8}$ " Qtz. veinlets, 2% Py. | 2195 | | | 1.0 | Tr. |
| 43.8-45.6 | Grano'd. A 2" and two $\frac{1}{8}$ " Qtz. veinlets, 2% coarse Py. | 2196 | | | 1.8 | Tr. |
| 45.6-47.1 | Grano'd. Four $\frac{1}{8}$ " Qtz. veinlets, 3% coarse Py. | 2197 | | | 1.5 | Tr. |
| 47.1-48.5 | Grano'd. A 10" glassy Qtz. vein, 3% coarse Py. | 2198 | | | 1.4 | Tr. |

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DIAMOND DRILL RECORD

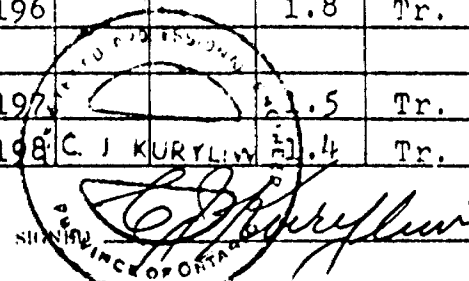WINDFALL OILS & MINES LTD.


HOLE NO. 80 - 36 SHEET NO. 2

LATITUDE _____ DATUM _____ STARTED _____
 DEPARTURE _____ BEARING _____ COMPLETED _____
 ELEVATION _____ DIP _____ ULTIMATE DEPTH _____

| DEPTH FEET | FORMATION | SAMPLE NO | FROM | TO | WIDTH | OZS Au |
|------------|--|-----------|------|----|-------|--------|
| 48.5-50.0 | Grano'd. A 2" Qtz. vein with coarse Py. and tourmaline. | 2199 | | | 1.5 | .02 |
| 50.6-51.5 | Grano'd. Three $\frac{1}{4}$ " Qtz. veinlets, 1% Py. | 2200 | | | .9 | Tr. |
| 53.0-54.0 | Grano'd. A 10" glassy Qtz. vein, coarse Py. and tourmaline along edges. | 2201 | | | 1.0 | Tr. |
| 55.3-57.2 | Grano'd. A 1" and a $\frac{1}{2}$ " Qtz. vein, 1% Py. | 2202 | | | 1.9 | Tr. |
| 58.1-58.6 | Grano'd. A 1" Qtz. vein, 1% Py. | 2203 | | | .5 | Tr. |
| 58.6-59.6 | Grano'd. Two $\frac{1}{4}$ " Qtz. veinlets, minor Py. | 2214 | | | 1.0 | .02 |
| 59.6-60.3 | Grano'd. A 1" massive Py. vein at 60' to core, looks good. | 2215 | | | .7 | 6.30 |
| 60.3-61.3 | Grano'd. A 2" glassy Qtz. vein, minor Py. | 2216 | | | 1.0 | .12 |
| 61.3-62.3 | Grano'd. Three $\frac{1}{4}$ " Qtz. veinlets, 1% Py. | 2217 | | | 1.0 | .05 |
| 63.3-65.4 | Grano'd. Four $\frac{1}{4}$ " Qtz. veinlets, 2% Py. | 2218 | | | 2.1 | .06 |
| 71.5-72.9 | Grano'd. Strong Q.C. alt'n. A 2" Qtz. vein, 5% coarse Py. | 2219 | | | 1.4 | .10 |
| 72.9-75.0 | Grano'd. A 1" glassy Qtz. vein, 1% Py. | 2220 | | | 2.1 | .02 |
| 76.0-77.4 | Grano'd. Strong Q.C. alt'n. that approaches vein appearance, 5% coarse Py. Looks good. | 2221 | | | 1.4 | .11 |
| 77.4-78.1 | Grano'd. Strong Q.C. alt'n. Three $\frac{1}{4}$ " Q.C. veinlet 7% coarse Py. with numerous fine specks of <u>Y.C.</u> at 77.7' at 78.0 and 78.1. | 2222 | | | 1.0 | 1.89 |

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DIAMOND DRILL RECORD

WINDFALL OILS & MINES LTD.

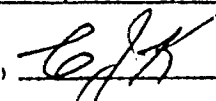HOLE NO. 80 - 36 SHEET NO. 3

LATITUDE _____ DATUM _____ STARTED _____
 DEPARTURE _____ BEARING _____ COMPLETED _____
 ELEVATION _____ DIP _____ ULTIMATE DEPTH _____

| DEPTH FEET | FOCINATION | SAMPLE NO | FROM | TO | WIDTH | OZS Au |
|-------------|---|-----------|------|----|-------|--------|
| 78.4-79.5 | Grano'd. Strong Q.C. alt'n. with a 1" and a 1/2" Qtz. veinlet, 7% coarse Py. and a speck of V.C. at 79.2' | 2223 | | | 1.1 | .66 |
| 79.5-80.9 | Grano'd. weak Q.C. alt'n. A 1/2" Qtz. veinlet. 2% Py. 1% PO. | 2224 | | | 1.4 | .02 |
| 82.0-82.9 | Grano'd. Three 1/2" Qtz. veinlets, 2% Py. | 2225 | | | .9 | .29 |
| 82.9-83.6 | Grano'd. A 1" and a 1/2" Qtz. vein, 7% coarse Py. A speck of V.C. within a 1/2" cube of Py. at 83.3' | 2226 | | | .7 | .29 |
| 83.6-84.4 | Grano'd. Two 1/2" Qtz. veinlets, 1% Py. | 2227 | | | .8 | .02 |
| 85.6-87.0 | Grano'd. A 1" and three 1/2" Qtz. veinlets, 1% Py. | 2228 | | | 1.4 | .01 |
| 87.0-89.0 | Grano'd. Three 1/2" Qtz. veinlets, 1% Py. | 2229 | | | 2.0 | .02 |
| 89.0-90.8 | Grano'd. Strong Q.C. alt'n. A 3" and three 1/2" Qtz. veinlets, 5% coarse Py., looks good. | 2230 | | | 1.8 | .19 |
| 94.2-95.8 | Grano'd. Two 1" and three 1/2" Qtz. veinlets, 2% Py. | 2231 | | | 1.6 | .02 |
| 95.8-97.3 | Grano'd. Two 1" Qtz. veinlets, med. Q.C. alt'n. 4% coarse Py. | 2295 | | | 1.5 | Tr. |
| 100.3-101.8 | Grano'd. Three 1/2" Qtz. veinlets, 2% Py. | 2296 | | | 1.5 | Tr. |
| 101.8-103.0 | Grano'd. Two 3" Qtz. veins with 4% coarse Py. in wall rock, looks good | 2297 | | | 1.2 | Tr. |
| 103.4-104.6 | Grano'd. A 2" and a 1" Qtz. Carb. veinlet, 3% coarse Py. | 2298 | | | 1.2 | Tr. |

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DIAMOND DRILL RECORD

WINDFALL OILS & MINES LTD.

HOLE NO. 80 - 36 SHEET NO. 4

LATITUDE DATUM STARTED

DEPARTURE BEARING COMPLETED

ELEVATION DIP ULTIMATE DEPTH

| DEPTH FEET | FORMATION | SAMPLE NO | FROM | TO | WIDTH | OZS. Au |
|-------------|--|-----------|------|----|-------|---------|
| 104.6-106.3 | Grano'd. A 2" and three 1/2" Qtz. veinlets, 1% Py. | 2299 | | | 1.7 | .02 |
| 106.3-108.0 | Grano'd. A 2" and three 1/2" Qtz. veinlets, 3% coarse Py. | 2300 | | | 1.7 | Tr. |
| 109.5-110.9 | Grano'd. Three 1/2" Qtz. veinlets, with heavy Py. and traces of chalco along edges. | 2301 | | | 1.4 | Tr. |
| 111.6-112.9 | Grano'd. A 3" and a 1" Qtz. vein, with some coarse Py. along edges. | 2302 | | | 1.3 | .03 |
| 116.8-118.8 | Grano'd. Two 2" and three 1/2" Qtz. veinlets, 2% Py. | 2303 | | | 2.0 | Tr. |
| 122.6-124.0 | Grano'd. A 2" and a 1" Qtz. veinlet, 1% Py. | 2304 | | | 1.4 | Tr. |
| 126.2-127.6 | Grano'd. Three 1/2" Qtz. veinlets, 2% Py. | 2305 | | | 1.4 | Tr. |
| 128.3-130.0 | Grano'd. Two 1" and three 1/2" Qtz. veinlets, 3% coarse Py. | 2306 | | | 1.7 | Tr. |
| 131.7-133.0 | Grano'd. A 2" and a 1" Qtz. veinlet, 2% Py. | 2307 | | | 1.3 | .01 |
| 133.5-134.5 | Grano'd. weak Q.C. alt'n. 3% coarse Py. | 2346 | | | 1.0 | Tr. |
| 134.5-135.3 | Grano'd. A 1" and a 1/2" Qtz. veinlet at 70° to core 4% coarse Py, 1 coarse speck of V.C. in massive Py. at 135.0. | 2347 | | | .8 | .04 |
| 135.3-136.3 | Grano'd. Minor Qtz. 1% Py. | 2348 | | | 1.0 | Tr. |
| 136.3-138.0 | Grano'd. Two 2" Qtz. veinlets, 3% coarse Py. | 2349 | | | 1.7 | .02 |
| 145.3-147.1 | Grano'd. Four 1/2" Qtz. veinlets, 1% Py. | 2350 | | | 1.8 | Tr. |
| 147.1-148.4 | Grano'd. A 2" and three 1/2" Qtz. veinlets, 5% coarse Py. | 2351 | | | 1.3 | .06 |

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DIAMOND DRILL RECORD

WINDFALL OILS & MINES LTD.

HOLE NO. 80 - 36 SHEET NO. 5

LATITUDE _____ DATUM _____ STARTED _____
 DEPARTURE _____ BEARING _____ COMPLETED _____
 ELEVATION _____ DIP _____ ULTIMATE DEPTH _____

| DEPTH FEET. | FORMATION | SAMPLE NO | FROM | TO | WIDTH | OZS Au |
|-------------|--|-----------|------|----|-------|--------|
| 149.9-152.3 | Grano'd. Five $\frac{1}{4}$ " Qtz. veinlets, 2% Py. | 2352 | | | 2.4 | Tr. |
| 153.3-154.0 | Grano'd. A 3" and a 1" Qtz. veinlet, 5% coarse Py. looks good. | 2353 | | | .7 | Tr. |
| 154.0-155.5 | Grano'd. Three $\frac{1}{2}$ " Qtz. veinlet, 1% Py. | 2354 | | | 1.5 | Tr. |
| 155.5-156.2 | Grano'd. A 2" Qtz. Carb. vein with three specks of V.C. at 155.8. | 2355 | | | .7 | 1.59 |
| 159.5-160.7 | Grano'd. A 1" ; and two $\frac{1}{2}$ " Qtz. veinlets, 1% Py. | 2356 | | | 1.2 | Tr. |
| 164.8-166.8 | Grano'd. Six $\frac{1}{2}$ " Qtz. veins, 3% coarse Py. | 2357 | | | 2.0 | Tr. |
| 168.0-169.6 | Grano'd. A 2" and three $\frac{1}{2}$ " Qtz. veinlets, 3% Py. | 2358 | | | 1.6 | Tr. |
| 170.4-170.9 | Grano'd. A $\frac{1}{2}$ " Qtz. veinlet, 3% Py. | 2359 | | | .5 | Tr. |
| 171.6-172.3 | Grano'd. A 1" Qtz. vein, 1% Py. | 2360 | | | .7 | Tr. |
| 174.0-176.7 | Grano'd. A 2" and four 1" Qtz. veinlets, 4% coarse Py. | 2361 | | | 2.7 | Tr. |
| 178.3-181.0 | Grano'd. Six $\frac{1}{2}$ " Qtz. veinlets, 4% Py. in massive streaks. | 2362 | | | 2.7 | Tr. |
| 182.0-184.7 | Grano'd. A 2" and two 1" Qtz. veinlets, 2% coarse Py. | 2363 | | | 2.7 | Tr. |
| 190.2-191.7 | Grano'd. Two 2" Qtz. veinlets, 3% coarse Py. | 2364 | | | 1.5 | Tr. |
| 191.7-192.8 | Grano'd. A three " glassy Qtz. vein, 3% coarse Py. | 2365 | | | 1.1 | Tr. |
| 193.5-195.2 | Grano'd. A 3" and two 2" Qtz. veinlets, 3% coarse Py. | 2366 | | | 1.7 | Tr. |

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DIAMOND DRILL RECORD

WINDFALL OILS & MINES LTD.

HOLE NO. R0 - 36 SHEET NO. 6

LATITUDE DATUM STARTED

DEPARTURE BEARING COMPLETED

ELEVATION DIP ULTIMATE DEPTH

| DEPTH FEET | FORMATION | SAMPLE NO | FROM | TO | WIDTH | OZS Au |
|-------------|---|-----------|------|----|-------|--------|
| 200.2-202.5 | Grano'd. Two 2" and two $\frac{1}{2}$ " glassy Qtz. veinlets, 1% Py. | 2367 | | | 2.3 | Tr. |
| 203.4-204.4 | Grano'd. 20% irregular Qtz. 10% coarse Py. | 2368 | | | 1.0 | .03 |
| 205.8-206.5 | Grano'd. A 2" glassy Qtz. vein, 2% Py. | 2369 | | | .7 | .77 |
| 210.7-212.2 | Grano'd. Four $\frac{1}{2}$ " Qtz. veinlets, 5% streaks of massive Py. | 2370 | | | 1.5 | .01 |
| 212.7-215.5 | Grano'd. Three $\frac{1}{2}$ " Qtz. veinlets, 2% Py. | 2371 | | | 2.8 | .01 |
| 217.8-219.7 | Grano'd. Two 1" and two $\frac{1}{2}$ " Qtz. veinlets, 5% coarse Py. | 2372 | | | 1.9 | .05 |
| 220.0-220.9 | Grano'd. A 3" glassy Qtz. vein, 3% coarse Py. | 2373 | | | .9 | Tr. |
| 222.5-225.0 | Grano'd. Two 2" and three $\frac{1}{2}$ " Qtz. veinlets, 3% Py. | 2374 | | | 2.5 | .01 |
| 229.0-231.0 | Grano'd. A 5" and three $\frac{1}{2}$ " Qtz. veinlets, 3% Py. | 2375 | | | 2.0 | .02 |
| 235.8-236.6 | Grano'd. A 1" Qtz. vein with 5% coarse Py. along edges. | 2376 | | | .8 | .01 |
| 239.0-250.0 | Feldspar porphyry dyke, 30% coarse feldspar pheno's well fractured with Qtz. veinlets. | | | | | |
| 250.0- | Grano'd. greyish, med. to coarse grained, well fractured with numerous Qtz. filled fractures that run at 55°- 70° to core axis. | | | | | |
| 240.0-241.2 | Feldspar porphyry dyke, two 4" and one 1" Qtz. veinlet, 2% coarse Py. | 2418 | | | 1.7 | Tr. |

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DIAMOND DRILL RECORD

WINDFALL OILS & MINES LTD.

HOLE NO. 80 - 36 SHEET NO. 7

LATITUDE _____ DATUM _____ STARTED _____
 DEPARTURE _____ BEARING _____ COMPLETED _____
 ELEVATION _____ DIP _____ ULTIMATE DEPTH _____

| DEPTH FEET | FORMATION | SAMPLE NO | FROM | TO | WIDTH | OZS Au |
|-------------|---|-----------|------|----|-------|--------|
| 241.7-243.8 | Feldspar porphyry, three $\frac{1}{8}$ " Qtz. veinlets, 1% Py. | 2419 | | | 2.1 | Tr. |
| 243.8-245.7 | Feldspar porphyry, four $\frac{1}{8}$ " Qtz. veinlets, 1% Py. | 2420 | | | 1.9 | Tr. |
| 249.0-251.0 | Feldspar porphyry. Four $\frac{1}{8}$ " Qtz. 1% Py. | 2421 | | | 2.0 | Tr. |
| 250.5-254.6 | Grano'd. two $\frac{1}{8}$ " Qtz. veinlet with 3% coarse Py. | 2422 | | | 1.1 | .03 |
| 256.0-256.8 | Grano'd. three $\frac{1}{8}$ " Qtz. veinlets, 1% Py. | 2423 | | | .8 | Tr. |
| 258.0-259.7 | Grano'd. Three 1" Qtz. veinlets, 1% Py. | 2424 | | | 1.7 | .05 |
| 261.3-263.1 | Grano'd. Two 1" Qtz. veinlets, 1% Py. | 2425 | | | 1.8 | Tr. |
| 265.4-267.5 | Grano'd. Three $\frac{1}{8}$ " Qtz. veinlets, 3% coarse Py. | 2426 | | | 2.1 | Tr. |
| 269.8-271.4 | Grano'd. A 4" glassy Qtz. vein, med. Q.C. alt'n. | 2427 | | | 1.6 | .01 |
| | 4% coarse Py. | | | | | |
| 271.4-273.3 | Grano'd. A 5" and two 1" Qtz. veinlets, 3% coarse Py. | 2428 | | | 1.9 | .02 |
| 273.3-274.7 | Grano'd. Two $\frac{1}{8}$ " Qtz. veinlets, 2% coarse Py. | 2429 | | | 1.4 | .05 |
| 276.5-277.3 | Grano'd. A 2" glassy Qtz. vein, 2% Py. | 2430 | | | .8 | Tr. |
| 278.5-279.5 | Grano'd. A 2" and a $\frac{1}{8}$ " glassy Qtz. vein, 3% coarse Py. | 2431 | | | 1.0 | .03 |
| 282.0-283.5 | Grano'd. Two 1" Qtz. veinlets, 2% coarse Py. | 2432 | | | 1.5 | Tr. |
| 284.2-285.3 | Grano'd. Two 2" Qtz. veinlets, 3% coarse Py. | 2433 | | | 1.1 | .02 |
| 287.0-287.5 | Grano'd. A 1" Qtz. veinlet, 2% coarse Py. | 2434 | | | .5 | .01 |
| 287.7-288.5 | Grano'd. A 2" Qtz. vein, with streaks of massive Py. along edge. | 2435 | | | .8 | Tr. |

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DIAMOND DRILL RECORD

WINDFALL OILS & MINES LTD.

HOLE NO. 80 - 36 SHEET NO. 8

LATITUDE _____ DATUM _____ STARTED _____
 DEPARTURE _____ BEARING _____ COMPLETED _____
 ELEVATION _____ DIP _____ ULTIMATE DEPTH _____

| DEPTH FEET | FORMATION | SAMPLE NO | FROM | TO | WIDTH | OZS | |
|-------------|---|-----------|------|----|-------|-----|--|
| 282.5-290.0 | Grano'd. A 1" glassy Qtz. vein, minor Py. | 2436 | | | .5 | .01 | |
| 293.0-295.0 | Grano'd. Four 1" Qtz. veinlets, 3% coarse Py. mostry along wall rock of veinlets. | 2437 | | | 2.0 | .04 | |
| 295.0-296.8 | Grano'd. A 5" and three 1/2" Qtz. veinlets, 3% coarse Py. | 2438 | | | 1.8 | .02 | |
| 298.0-299.8 | Grano'd. Three 1/2" Qtz. veinlets, 1% Py. | 2439 | | | 1.8 | .01 | |
| 304.5-305.7 | Grano'd. Two 1/2" Qtz. veinlets, 1% Py. | 2440 | | | 1.2 | Tr. | |
| 305.7-306.7 | Grano'd. A 2" and a 1/2" Qtz. veinlet, 3% coarse Py. | 2441 | | | 1.0 | .01 | |
| 313.2-315.4 | Grano'd. Three 1/2" Qtz. veinlets, minor Py. | 2442 | | | 1.2 | Tr. | |
| 315.4-316.2 | Grano'd. A 1/2" and a 1" Qtz. veinlet, the latter has 1/2" streak of massive Py. at 315.9 that carries a speck of V.G. in the Py. | 2443 | | | .8 | .02 | |
| 318.3-319.6 | Grano'd. Two 2" Qtz. veinlets, 3% coarse Py. | 2444 | | | 1.3 | Tr. | |
| 320.3-321.0 | Grano'd. Two 1/2" Qtz. veinlets, 1% Py. | 2445 | | | .7 | Tr. | |
| 321.9-322.9 | Grano'd. A 4" glassy Qtz. vein, with streaks of massive Py. along the edge. | 2446 | | | 1.0 | .03 | |
| 323.0-325.9 | Grano'd. Five 1/2" Qtz. veinlets, 3% coarse Py. | 2447 | | | 2.9 | .01 | |
| 326.8-327.6 | Grano'd. med. Q.C. alt'n. two 1/2" Qtz. veinlets, 4% coarse Py. | 2448 | | | .8 | .09 | |
| 328.2-328.9 | Grano'd. Two 1/2" Qtz. veinlets, the one at 328.3 carries three fine specks of V.G. in a patch. | 2449 | | | .7 | .02 | |

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DIAMOND DRILL RECORD

WINDFALL OILS & MINES LTD.

HOLE NO. 80 - 43 SHEET NO. 4

LATITUDE _____ DATUM _____ STARTED _____
 DEPARTURE _____ BEARING _____ COMPLETED _____
 ELEVATION _____ DIP _____ ULTIMATE DEPTH _____

| DEPTH FEET | FORMATION | SAMPLE No | FROM | TO | WIDTH | OZS Au |
|-------------|---|-----------|------|----|-------|--------|
| 231.0-231.8 | Grano'd. A $\frac{1}{8}$ " Qtz. vein with 5% coarse Py. in wall rock. | 3130 | | | .8 | Tr. |
| 232.3-233.3 | Grano'd. A $\frac{1}{2}$ " and a $\frac{1}{4}$ " Qtz. veinlet, 1% Py. | 3131 | | | 1.0 | Tr. |
| 234.4-235.6 | Grano'd. Med. Q.C. alt'n. 3% coarse Py. | 3132 | | | 1.2 | Tr. |
| 235.6-237.0 | Grano'd. Two 3" Qtz. veinlets, 2% coarse Py. | 3133 | | | 1.4 | .01 |
| 238.3-238.8 | Grano'd. A $\frac{1}{2}$ " Qtz. veinlet, minor Py. | 3134 | | | .5 | Tr. |
| 240.4-241.1 | Grano'd. A 3" Qtz. vein, 3% Py. in wall rock. | 3135 | | | .7 | .03 |
| 246.1-247.0 | Grano'd. A 2" and two $\frac{1}{2}$ " Qtz. veinlets, 2% coarse Py. | 3136 | | | .9 | .02 |
| 248.9-249.7 | Grano'd. A $\frac{1}{2}$ " Qtz. veinlets, 2% Py. 1% PO. | 3137 | | | .8 | .01 |
| 249.7-251.3 | Grano'd. 40% Qtz. in veinlets, 5% coarse Py. | 3138 | | | 1.6 | .02 |
| 255.3-255.8 | Grano'd. A $\frac{1}{2}$ " Qtz. veinlet, minor Py. | 3139 | | | .5 | .01 |
| 256.7-257.5 | Grano'd. A 2" Qtz. vein with Med. Q.C. wall rock alt'n. 4% coarse Py. | 3140 | | | .8 | .07 |
| 259.0-260.3 | Coarse Grano'd. A 2" and two 1" Qtz. veinlets, with 3% Py. 1% PO. | 3212 | | | 1.3 | .07 |
| 262.7-264.7 | Grano'd. One 2" and four 1" Qtz. veinlets, Med. Q.C. alt'n. 3% Py. 2% PO. | 3213 | | | 2.0 | .02 |
| 265.2-265.8 | Grano'd. A 4" Qtz. veinlet, 1% PO. 1% Py. | 3214 | | | .6 | Tr. |
| 271.7-272.5 | A 4" glassy Qtz. vein at contact between Grano'd. and feldspar porphyry. 1% Py. | 3215 | | | .8 | .87 |

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DIAMOND DRILL RECORD

WINDFALL OILS & MINES LTD.

HOLE NO. 80 - 43 SHEET NO. 5

LATITUDE _____ DATUM _____ STARTED _____
 DEPARTURE _____ BEARING _____ COMPLETED _____
 ELEVATION _____ DIP _____ ULTIMATE DEPTH _____

| DEPTH FEET | FORMATION | SAMPLE NO | FROM | TO | WIDTH | OZS Au |
|-------------|--|-----------|------|----|-------|--------|
| 272.0-280.5 | Feldspar porphyry kyke. 30% coarse white feldspar pheno'crysts. in a Qtz. biotite ground mass. | | | | | |
| 280.5- | Grano'd. Greenish, grey, coarse grained Qtz. filled fractures are not as well developed in this more massive, appearing Grano'd. from 330.0-345.0, fine grained, very blocky, Lost core at 331.0-333.0. and 344.0'-345.0'. | | | | | |
| 280.5-281.0 | Grano'd. A 1/2" Qtz. vein, 3% coarse Py. | 3216 | | | .5 | .12 |
| 285.6-286.7 | Grano'd. A 1" Qtz. vein, 1% Py. | 3217 | | | 1.1 | Tr. |
| 288.6-289.2 | Grano'd. A 1" glassy Qtz. vein that carries a few specks of chalco. | 3218 | | | .6 | Tr. |
| 298.3-299.0 | Grano'd. A 2" Qtz. vein, 2% Py. | 3219 | | | .7 | Tr. |
| 300.3-300.9 | Grano'd. A 1" Qtz. vein, minor Py. | 3220 | | | .6 | Tr. |
| 309.9-310.5 | Grano'd. A 1" Qtz. vein, 1% Py. | 3221 | | | .6 | .03 |
| 317.0-317.5 | Grano'd. A 1/2" glassy Qtz. vein, minor Py. | 3222 | | | .5 | Tr. |
| 322.2-323.5 | Grano'd. Two 1/2" Qtz. veinlets, 2% Py. | 3223 | | | 1.3 | Tr. |
| 326.8-327.5 | Grano'd. A 1/2" Qtz. vein, 1% Py. | 3224 | | | .7 | Tr. |
| 339.8-340.8 | Grano'd. Two 1/2" Qtz. veinlets, 1% Py. | 3225 | | | 1.0 | Tr. |
| 348.5-349.5 | Grano'd. Strong Q.C. alt'n. 7% coarse Py. | 3226 | | | 1.0 | .04 |
| 358.8-359.5 | Grano'd. Med. Q.C. alt'n. 5% coarse Py. | 3227 | | | .7 | .01 |

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WINDFALL OILS & MINES LTD.

HOLE NO. 80 - 43 SHEET NO. 6

LATITUDE _____ DATUM _____ STARTED _____
 DEPARTURE _____ BEARING _____ COMPLETED _____
 ELEVATION _____ DIP _____ ULTIMATE DEPTH _____

| DEPTH FEET | FORMATION | SAMPLE NO | FROM | TO | WIDTH | OZS Au |
|-------------|--|-----------|------|----|-------|--------|
| 368.5-369.4 | Grano'd. Med. Q.C. alt'n. 3% coarse Py. | 3228 | | | .9 | Tr. |
| 373.0-374.0 | Grano'd. Med. Q.C. alt'n. 3% coarse Py. | 3229 | | | 1.0 | Tr. |
| 377.4-378.4 | Grano'd. Strong Q.C. alt'n. 3% coarse Py. | 3230 | | | 1.0 | Tr. |
| 389.0-389.7 | Grano'd. Med. Q.C. alt'n. A 1" Qtz. Carb. veinlet at 70" to core. 7% coarse Py. | 3231 | | | .7 | .02 |
| 396.0-397.3 | Grano'd. A 2" Qtz. vein, Med. Q.C. alt'n. 5% coarse Py. | 3232 | | | 1.3 | .02 |
| 403.7-405.4 | Grano'd. Med. Q.C. alt'n. A 1" Qtz. vein, 3% Py. | 3233 | | | 1.7 | Tr. |
| 408.3-409.0 | Grano'd. Strong Q.C. alt'n. 7% coarse Py. Three fine specks of <u>V.G.</u> in a 1/8" fracture near the Py. | 3234 | | | .7 | .30 |
| 418.3-419.4 | Grano'd. Four 1/8" Qtz. veinlets, 2% Py. | 3235 | | | 1.1 | Tr. |
| 421.5-422.3 | Grano'd. Med. Q.C. alt'n. Two 1/8" Qtz. Carb. veinlets, 2% Py. 1% PO. | 3236 | | | .8 | Tr. |
| 422.6-423.4 | Grano'd. Strong Q.C. alt'n. A 1" Qtz. veins, 2% Py. | 3237 | | | .8 | .09 |
| 425.3-425.9 | Grano'd. A 1" Qtz. vein, 1% Py. | 3238 | | | .6 | Tr. |
| 426.8-427.4 | Grano'd. A 1" Qtz. vein, with 4% Py. | 3239 | | | .6 | Tr. |
| 428.7-429.5 | Grano'd. A 1" and two 1/8" Qtz. veinlets, 2% Py. 1% PO. | 3240 | | | .8 | Tr. |
| 429.5-430.1 | Grano'd. Two 1/8" Qtz. veinlets, 3% Py. | 3241 | | | .6 | .03 |

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DIAMOND DRILL RECORD

WINDFALL OILS & MINES LTD.

HOLE NO. 80 - 43 SHEET NO. 7

LATITUDE _____ DATUM _____ STARTED _____
 DEPARTURE _____ BEARING _____ COMPLETED _____
 ELEVATION _____ DIP _____ ULTIMATE DEPTH _____

| DEPTH FEET | FORMATION | SAMPLE NO | FROM | TO | WIDTH | OZS Au |
|-----------------------|--|-----------|------|----|-------|--------|
| 430.9-431.4 | Grano'd. A two " glassy Qtz. vein, minor Py. | 3242 | | | .5 | Tr. |
| 433.0-433.7 | Grano'd. A 1" Qtz. Carb. veinlet, 3% Py. 1% PO. | 3243 | | | .7 | .04 |
| 435.0-437.2 | Grano'd. Six 1" Qtz. veinlets, 2% Py. | 3244 | | | 2.2 | .01 |
| 438.7-439.3 | Grano'd. A 1" Qtz. veinlet, 1% Py. | 3245 | | | .6 | Tr. |
| 442.0-443.2 | Grano'd. Med. Q.C. alt'n. Three ½" Qtz. veinlets, 5% coarse Py. | 3246 | | | 1.2 | .07 |
| 444.4-445.4 | Grano'd. A 2" and a 1" Qtz. 2% Py. | 3247 | | | 1.0 | Tr. |
| 446.6-447.2 | Grano'd. A 2" Qtz. vein, 2% Py. Trace of chalco. | 3248 | | | .6 | .03 |
| 449.0-449.6 | Grano'd. A 2" glassy Qtz. vein, 2% Py. | 3249 | | | .6 | Tr. |
| 452.3-452.8 | Grano'd. A 1" glassy Qtz. vein, 2% Py. | 3250 | | | .5 | .02 |
| 453.5-455.5 | Grano'd. A 2" and two ½" Qtz. veinlets, 2% Py. | 3251 | | | 2.0 | Tr. |
| 457.3-458.0 | Grano'd. A ½" Qtz. veinlet, Med. Q.C. alt'n. 3% Py. | 3252 | | | .7 | .02 |
| END OF HOLE AT 458.0' | | | | | | |
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SIGNED *C. J. Kureplin*


DIAMOND DRILL RECORD

WINDFALL OILS & MINES LTD.

HOLE NO. 80 - 44 SHEET NO. 1

LATITUDE 12991.0 DATUM B.Q. Case
Stred in rack Windfall STARTED Nov. 3, 1980
 DEPARTURE 9960.0 BEARING S - 70° E COMPLETED Nov. 6, 1980
 ELEVATION 9894.97 DIP - 60° ULTIMATE DEPTH 503.0'

| DEPTH FEET | FORMATION | SAMPLE NO | FROM | TO | WIDTH | OZS Au |
|------------|---|-----------|------|----|-------|--------|
| 0 - 30.0 | Casing in overburden. | | | | | |
| 30.0-280.0 | Grano'd. dark greyish, med. grained with Qtz. filled fractures that are well developed and carry some wall rock Qtz. Carb. alt'n. and pyritic mineralization. | | | | | |
| 33.0-34.3 | Grano'd. strong Q.C. alt'n. with a 2" Qtz. Carb. vein, 7% coarse Py in wall rock. Three fine specks of V.G. at 33.5'. | 3300 | | | 1.3 | .17 |
| 35.6-37.1 | Grano'd. med. Q.C. alt'n. Two ½" Qtz. veinlets, 2% Py. | 3301 | | | 1.5 | .02 |
| 39.4-40.0 | Grano'd. A ½" Qtz. vein, 1% Py. | 3302 | | | .6 | .02 |
| 41.0-42.2 | Grano'd. Strong Q.C. alt'n. A 2" Qtz. vein, 7% coarse Py. | 3303 | | | 1.2 | .09 |
| 46.3-47.4 | Grano'd. A 3" glassy Qtz. vein, strong Q.C. alt'n. 7% coarse Py. | 3304 | | | 1.1 | .05 |
| 52.5-53.0 | Grano'd. A 1" Qtz. vein, minor Py. | 3305 | | | .5 | Tr. |
| 55.8-57.0 | Grano'd. Strong Q.C. alt'n. A 2" Qtz. Carb. vein, 7% coarse Py. | 3306 | | | 1.2 | Tr. |
| 63.4-64.5 | Grano'd. Strong Q.C. alt'n. A 1" Qtz. Carb. vein, 4% coarse Py. | 3307 | | | .1 | Tr. |

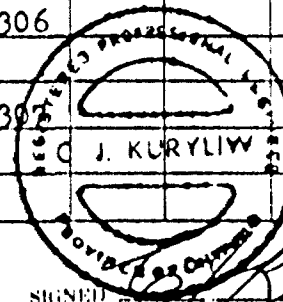

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SIGNED J. Kuryliw

DIAMOND DRILL RECORD

WINDFALL OILS & MINES LTD.

HOLE NO. 80 - 44 SHEET NO. 2

LATITUDE DATUM STARTED

DEPARTURE BEARING COMPLETED

ELEVATION DIP ULTIMATE DEPTH

| DEPTH FEET | FORMATION | SAMPLE NO | FROM | TO | WIDTH | OZS Ag |
|-------------|--|-----------|------|----|-------|--------|
| 66.9-67.5 | Grano'd. Two $\frac{1}{8}$ " Qtz. veinlets, 2% Py. | 3308 | | | .6 | Tr. |
| 73.0-73.5 | Grano'd. A $\frac{1}{8}$ " Qtz. vein, 2% Py. | 3309 | | | .5 | Tr. |
| 75.3-75.8 | Grano'd. A $\frac{1}{8}$ " Qtz. vein, 1% Py. Traces of chalco. | 3310 | | | .5 | Tr. |
| 76.8-77.5 | Grano'd. Three $\frac{1}{8}$ " Qtz. veinlets, 1% Py. | 3311 | | | .7 | Tr. |
| 87.2-88.2 | Grano'd. Two $\frac{1}{8}$ " Qtz. veins, minor Py. | 3312 | | | 1.0 | |
| 93.0-93.5 | Grano'd. A 1" Qtz. vein, minor Py. | 3313 | | | | Tr. |
| 94.3-94.8 | Grano'd. A 1" Qtz. vein, minor Py. | 3314 | | | | Tr. |
| 95.7-97.0 | Grano'd. Three $\frac{1}{8}$ " Qtz. veinlets, 1% Py. Traces of chalco. | 3315 | | | 1.3 | .01 |
| 106.0-106.5 | Grano'd. A 2" glassy Qtz. vein, minor Py. | 3316 | | | .5 | Tr. |
| 107.3-108.7 | Grano'd. Three $\frac{1}{8}$ " Qtz. veinlets, 3% coarse Py. | 3317 | | | 1.4 | .07 |
| 109.3-110.1 | Grano'd. Strong Q.C. alt'n. $\frac{1}{8}$ " Qtz. Carb. vein, 5% coarse Py. | 3318 | | | .8 | .03 |
| 124.4-125.4 | Grano'd. strong Qtz. Carb. alt'n. A 1" Qtz. vein, 3% Py. | 3319 | | | 1.0 | .15 |
| 125.7-126.5 | Grano'd. A 1" Qtz. vein, 1% Py. | 3320 | | | .8 | Tr. |
| 128.0-128.6 | Grano'd. A $\frac{1}{8}$ " Qtz. vein, 1% Py. 1% PC. | 3321 | | | .6 | .01 |
| 133.0-133.5 | Grano'd. A $\frac{1}{8}$ " Qtz. vein, 2% Py. | 3322 | | | .5 | Tr. |
| 142.0-143.0 | Grano'd. A 2" Qtz. Carb. vein, 4% coarse Py. | 3323 | | | 1.0 | .03 |
| 153.0-155.0 | Grano'd. A 2" and two $\frac{1}{8}$ " Qtz. veinlets, 1% Py. | 3324 | | | 2.0 | Tr. |
| 156.2-159.0 | Grano'd. A 3" glassy Qtz. vein, minor Py. | 3325 | | | 2.8 | Tr. |

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DIAMOND DRILL RECORD

WINDFALL OILS & MINES LTD.

HOLE NO. 80 - 44 SHEET NO. 3

LATITUDE DATUM STARTED

DEPARTURE BEARING COMPLETED

ELEVATION DIP ULTIMATE DEPTH

| DEPTH FEET | FORMATION | SAMPLE NO | FROM | TO | WIDTH | OZS Au |
|-------------|--|-----------|------|----|-------|--------|
| 173.5-174.5 | Grano'd. A $\frac{1}{2}$ " and two $\frac{1}{4}$ " Qtz. veinlets, minor Py. | 3326 | | | 1.0 | Tr. |
| 176.0-177.0 | Grano'd. Three $\frac{1}{2}$ " Qtz. veins, 1% Py. | 3327 | | | 1.0 | Tr. |
| 187.3-187.8 | Grano'd. A $\frac{1}{2}$ " Qtz. vein, 5% coarse Py. | 3328 | | | .5 | .36 |
| 192.3-193.8 | Grano'd. A 2" and a $\frac{1}{2}$ " Qtz. veins, 3% coarse Py. | 3329 | | | 1.5 | .03 |
| 197.3-198.3 | Grano'd. 70% Qtz. veins, strong Q.C. alt'n. 10% coarse Py. Looks good. | 3330 | | | 1.0 | .08 |
| 198.3-199.2 | Grano'd. A 1" Qtz. vein, 1% Py. | 3331 | | | .9 | .04 |
| 206.6-207.2 | Grano'd. Two 1/8" Qtz. Carb. veinlets, 3% Py. | 3332 | | | .6 | .33 |
| 214.1-214.0 | Grano'd. Two 1" Qtz. veinlets, 3% Py. | 3333 | | | .8 | .03 |
| 215.5-217.0 | Grano'd. A 2" and a 1" Qtz. veinlet, 3% coarse Py | 3334 | | | 1.5 | .03 |
| 218.8-219.8 | Grano'd. Two $\frac{1}{2}$ " Qtz. Carb. veinlets, with streaks of massive Py. Med. Q.C. alt'n. | 3335 | | | 1.0 | .02 |
| 220.5-221.5 | Grano'd. Strong Q.C. alt'n. $\frac{1}{2}$ " Qtz. Carb. veinlet 5% coarse Py. | 3336 | | | 1.0 | .05 |
| 225.0-226.0 | Grano'd. strong Q.C. alt'n. A $\frac{1}{2}$ " Qtz. Carb. vein 4% coarse Py. | 3337 | | | 1.0 | .05 |
| 229.0-229.7 | Grano'd. A 6" glassy Qtz. vein, 2% Py. in wall rock. | 3338 | | | .7 | .04 |
| 236.5-237.4 | Grano'd. Strong Q.C. alt'n. A $\frac{1}{2}$ " Carb. vein, 5% coarse Py. | 3339 | | | .9 | .13 |

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DIAMOND DRILL RECORD

WINDFALL OILS & MINES LTD.

HOLE NO. 80 - 44 SHEET NO. 4

LATITUDE DATUM STARTED

DEPARTURE BEARING COMPLETED

ELEVATION DIP ULTIMATE DEPTH

| DEPTH FEET | FORMATION | SAMPLE NO | FROM | TO | WIDTH | OZS Au |
|-------------|---|-----------|------|----|-------|--------|
| 245.1-246.2 | Grano'd. Strong Q.C. alt'n. A $\frac{1}{4}$ " Carb. veinlet, 5% coarse Py. | 3340 | | | 1.1 | .03 |
| 247.4-248.8 | Grano'd. Med. Qtz. Carb. alt'n. A $\frac{1}{4}$ " Qtz. Carb. vein, 3% Py. | 3341 | | | 1.4 | .01 |
| 251.8-252.6 | Grano'd. Strong Q.C. alt'n. A 2" Qtz. vein, 5% coarse Py. | 3342 | | | .8 | Tr. |
| 255.1-255.7 | Grano'd. A $\frac{1}{2}$ " Qtz. Carb. vein, med. Q.C. alt'n. 1% Py. | 3343 | | | .6 | .02 |
| 257.6-258.4 | Grano'd. Med. Q.C. alt'n. A 1" glassy Qtz. vein, 2% Py. | 3344 | | | .8 | .01 |
| 260.7-261.6 | Grano'd. Med. Q.C. alt'n. A 1" Qtz. Carb. vein, 2% Py. | 3345 | | | .9 | Tr. |
| 262.3-263.0 | Grano'd. A 3" glassy Qtz. tourmaline vein, locks barren. | 3346 | | | .7 | Tr. |
| 264.0-264.9 | Grano'd. Strong Q.C. alt'n. Two $\frac{1}{4}$ " Qtz. veinlets, 3% coarse Py. | 3347 | | | .9 | .09 |
| 265.8-266.5 | Grano'd. Med. Q.C. alt'n. A 2" Qtz. vein, 3% Py. | 3348 | | | .7 | .05 |
| 272.2-272.9 | Grano'd. Med. Q.C. alt'n. A 2" glassy Qtz. vein, 4% coarse Py. | 3349 | | | .7 | .03 |
| 276.2-276.9 | Grano'd. Med. Q.C. alt'n. A $\frac{1}{2}$ " Qtz. vein, 3% coarse Py. | 3350 | | | .7 | .04 |

DRILLED BY _____

SIGNED _____

CJK

DIAMOND DRILL RECORD

WINDFALL OILS & MINES LTD.

HOLE NO. 80 - 44 SHEET NO. 5

LATITUDE DATUM STARTED

DEPARTURE BEARING COMPLETED

ELEVATION DIP ULTIMATE DEPTH

| DEPTH FEET | FORMATION | SAMPLE NO | FROM | TO | WIDTH | OZS Ag |
|-------------|---|-----------|------|----|-------|--------|
| 278.2-280.0 | Grano'd. Four $\frac{1}{4}$ " glassy Qtz. veinlets, 1% Py. | 3351 | | | 1.8 | Tr. |
| 280.0-289.6 | Feldspar porphyry dyke, 25% coarse feldspar pheno'crysts in the Qtz. biotite ground mass. | | | | | |
| 289.6-503.0 | Grano'd. dark greyish, med. to coarse grained looks massive, the Qtz. filled fractured are not as well developed. | | | | | |
| 286.8-289.0 | Feldspar porphyry, four $\frac{1}{4}$ " Qtz. veinlets with tourmaline and minor Py. | 3352 | | | 2.2 | Tr. |
| 289.8-290.4 | Grano'd. A $\frac{1}{8}$ " Qtz. veinlet at 50' to core, carries a streak of mixed massive Py and PO. and several specks of V.C. in a patch. | 3353 | | | .6 | 1.65 |
| 291.2-291.8 | Grano'd. A $\frac{1}{2}$ " Qtz. Carb. veinlet, 1% Py. | 3354 | | | .6 | .05 |
| 293.6-294.2 | Grano'd. A $\frac{1}{2}$ " Qtz. Carb. vein, 1% Py. | 3355 | | | .6 | .03 |
| 298.0-298.5 | Grano'd. A 1" Qtz. vein, 1% Py. | 3356 | | | .5 | .04 |
| 300.5-301.0 | Grano'd. A 1" glassy Qtz. vein, minor Py. | 3357 | | | .5 | Tr. |
| 306.8-308.8 | Grano'd. A 2" and two 1" Qtz. veinlets, 2% Py., 1% PO. | 3358 | | | 2.0 | .05 |
| 324.7-325.3 | Grano'd. Med. Q.C. alt'n. A $\frac{1}{4}$ " Qtz. veinlet, 1% Py. | 3359 | | | .6 | .01 |
| 329.2-329.7 | Grano'd. Med. Q.C. alt'n. A $\frac{1}{8}$ " Carb. vein, 2% Py. | 3360 | | | .5 | Tr. |

DRILLED BY _____

SIGNED CJL

DIAMOND DRILL RECORD

WINDFALL OILS & MINES LTD.

HOLE NO. 80 - 44 SHEET NO. 6

LATITUDE _____ DATUM _____ STARTED _____
 DEPARTURE _____ BEARING _____ COMPLETED _____
 ELEVATION _____ DIP _____ ULTIMATE DEPTH _____

| DEPTH FEET | FORMATION | SAMPLE NO | FROM | TO | WIDTH | OZS Au |
|-------------|--|-----------|------|----|-------|--------|
| 343.0-344.2 | Grano'd. A 2" and a $\frac{1}{2}$ " Qtz. veinlet, 2% Py. along edges. | 3361 | | | 1.2 | Tr. |
| 352.5-353.0 | Grano'd. A 2" glassy Qtz. vein, 4% coarse Py. along wall rock. | 3362 | | | .5 | .01 |
| 366.3-367.7 | Grano'd. Two $\frac{1}{2}$ " Qtz. veinlets, One with streaks oc massive Py. carries a speck of galena. | 3363 | | | 1.4 | .01 |
| 378.4-379.8 | Grano'd. Two $\frac{1}{2}$ " Qtz. veinlets, each with come coarse Py. along the edges. | 3364 | | | 1.4 | .02 |
| 386.0-387.0 | Grano'd. Three $\frac{1}{2}$ " Qtz. veinlets, minor Py. | 3365 | | | 1.0 | Tr. |
| 390.7-391.3 | Grano'd. A 5" glassy Qtz. vein, 4% Py. along edges. | 3366 | | | .6 | .02 |
| 396.0-397.5 | Grano'd. A 1" Qtz. vein, 2% Py. | 3367 | | | 1.5 | .01 |
| 405.5-406.0 | Grano'd. A $\frac{1}{2}$ " Qtz. vein, 1% Py. | 3368 | | | .5 | .01 |
| 407.5-408.7 | Grano'd. Two $\frac{1}{2}$ " Qtz. veins, 1% Py. | 3369 | | | 1.2 | .02 |
| 418.4-429.9 | Grano'd. A 3" and a $\frac{1}{2}$ " Qtz. veinlet, with streaks of massive Py. looks good. | 3370 | | | 1.5 | .08 |
| 422.5-423.0 | Grano'd. A 1" Qtz. vein, minor Py. | 3371 | | | .5 | Tr. |
| 426.3-426.9 | Grano'd. A $\frac{1}{2}$ " Carb. vein, 2% Py. | 3372 | | | .6 | Tr. |
| 428.6-429.5 | Grano'd. A 1" Qtz. vein, 3% Py. 2% PO. | 3373 | | | .9 | Tr. |
| 433.0-433.8 | Grano'd. A 2" glassy Qtz. vein, 1% Py. A trace of chalco in wall rock. | 3374 | | | .8 | Tr. |

DRILLED BY _____

SIGNED _____

[Handwritten Signature]

DIAMOND DRILL RECORD

WINDFALL OILS & MINES LTD.

HOLE NO. 80 - 114 SHEET NO. 7

LATITUDE _____ DATUM _____ STARTED _____
 DEPARTURE _____ BEARING _____ COMPLETED _____
 ELEVATION _____ DIP _____ ULTIMATE DEPTH _____

| DEPTH FEET | FORMATION | SAMPLE NO | FROM | TO | WIDTH | OZS. Au |
|-------------|--|-----------|------|----|-------|---------|
| 435.0-435.8 | Grano'd. A 3" glassy Qtz. vein, 2% Py. 1% PO. | 3375 | | | .8 | Tr. |
| 439.5-442.0 | Grano'd. Four $\frac{1}{2}$ " Qtz. veinlets, 2% Py. | 3376 | | | 1.5 | Tr. |
| 445.5-446.6 | Grano'd. Two $\frac{1}{2}$ " Qtz. veinlets, 3% Py. Traces of chalco. | 3377 | | | 1.1 | .01 |
| 448.5-449.0 | Grano'd. Two $\frac{1}{2}$ " Qtz. veinlets, 1% Py. | 3378 | | | .5 | .02 |
| 449.0-451.0 | Grano'd. Two 2" Qtz. veinlets with streaks of coarse Py. along edges. | 3379 | | | 2.0 | .03 |
| 452.0-453.0 | Grano'd. Four $\frac{1}{2}$ " Qtz. stringers, one with 50% streak of massive Py. | 3380 | | | 1.0 | Tr. |
| 459.0-460.0 | Grano'd. A 6" glassy Qtz. vein with streaks of massive Py. looks good. | 3381 | | | 1.0 | .07 |
| 460.0-461.0 | Grano'd. Two $\frac{1}{2}$ " Qtz. veinlets, 3% coarse Py. | 3382 | | | 1.0 | Tr. |
| 462.5-463.5 | Grano'd. Two $\frac{1}{2}$ " Qtz. veinlets, one with streaks of massive Py. | 3383 | | | 1.0 | Tr. |
| 465.3-467.0 | Grano'd. Eight $\frac{1}{2}$ " Qtz. veinlets, some with streaks of massive Py. | 3384 | | | 1.7 | .02 |
| 468.8-469.8 | Grano'd. Two 2" Qtz. veins, 3% Py. | 3385 | | | 1.0 | .02 |
| 469.8-472.5 | Grano'd. Six $\frac{1}{2}$ " Qtz. veinlets, 3% Py. | 3386 | | | 1.7 | Tr. |
| 472.4-473.5 | Grano'd. Two $\frac{1}{2}$ " Qtz. veinlets, one with streaks of massive Py. | 3387 | | | 1.1 | Tr. |
| 474.0-475.0 | Grano'd. Strong Q.C. alt'n. 4% Py. | 3388 | | | 1.0 | Tr. |

DRILLED BY _____

SIGNED _____

[Signature]

DIAMOND DRILL RECORD

WINDFALL OILS & MINES LTD.

HOLE NO. 80 - 44 SHEET NO. 8

LATITUDE _____ DATUM _____ STARTED _____
 DEPARTURE _____ BEARING _____ COMPLETED _____
 ELEVATION _____ DIP _____ ULTIMATE DEPTH _____

| DEPTH FEET | FORMATION | SAMPLE NO | FROM | TO | WIDTH | OZS Au |
|-----------------------|--|-----------|------|----|-------|--------|
| 476.8-479.0 | Grano'd. A 2" and four 1/2" Qtz. veinlets, 1% Py. | 3389 | | | 2.2 | .03 |
| 479.8-480.4 | Grano'd. A 1" Qtz. vein, 1% Py. | 3390 | | | .6 | Tr. |
| 482.3-483.0 | Grano'd. A 2" Qtz. vein, 2% Py. 1% PO. | 3391 | | | .7 | Tr. |
| 484.4-485.3 | Grano'd. Two 1/2" Qtz. vein, one with a streak of chalco, 1% Py. | 3392 | | | .9 | Tr. |
| 490.0-491.3 | Grano'd. Several fine Qtz. filled fractures, 1% Py. | 3393 | | | 1.3 | Tr. |
| 491.3-492.5 | Grano'd. Several 1/8" Qtz. filled fractures, 4% Py. One fracture carries streaks of galena and a speck of V.G. at 492.0' | 3394 | | | 1.2 | .10 |
| 493.0-493.7 | Grano'd. A 1/2" Qtz. vein, 2% Py. 1% PO. | 3395 | | | .7 | Tr. |
| 495.0-496.5 | Grano'd. Two 1/2" Qtz. Carb. veinlets, 2% Py. | 3396 | | | 1.5 | Tr. |
| 498.0-498.8 | Grano'd. A 1/2" Qtz. Carb. vein, 1% Py. 1/2% PO. | 3397 | | | .8 | .02 |
| END OF HOLE AT 503.0' | | | | | | |
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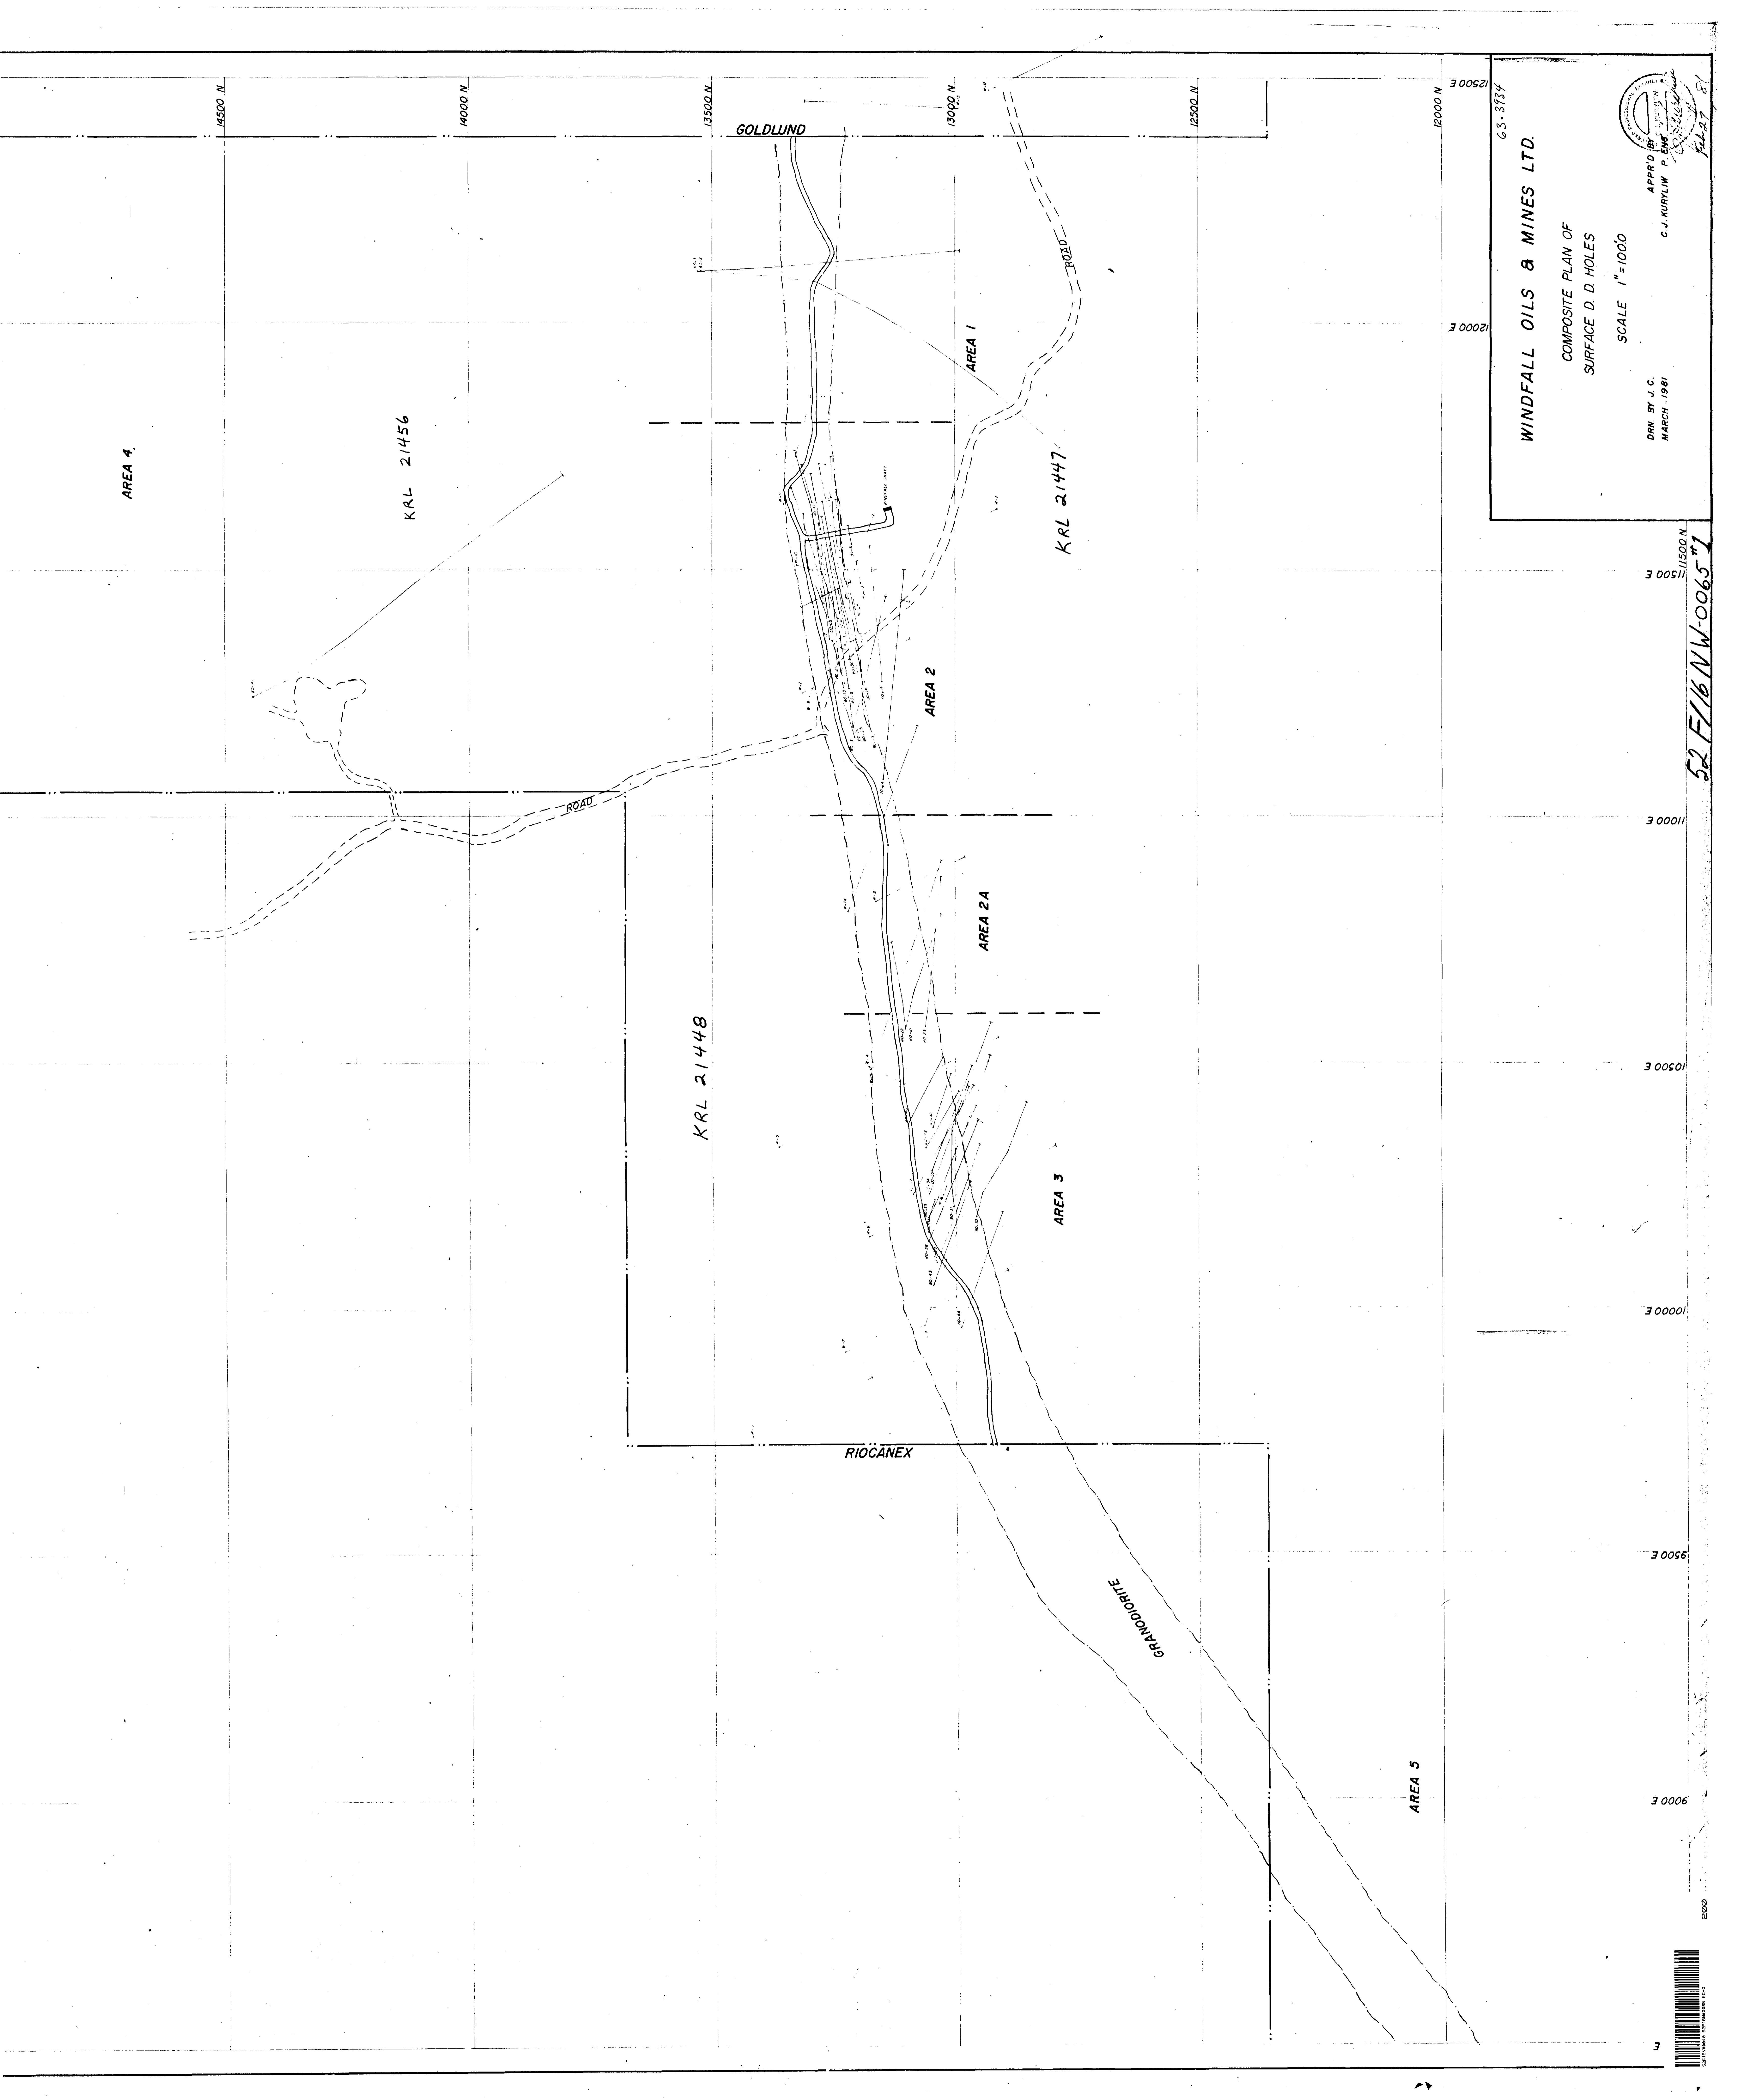
DRILLED BY _____

SIGNED *L. H. Kurepew*


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INFORMATION


SEE MAPS:

52F/16NW-0065 # (1-11)



WINDFALL OILS & MINES LTD.
 G.S. 3734
 COMPOSITE PLAN OF
 SURFACE D. D. HOLES
 SCALE 1" = 1000'
 DRAWN BY J.C.
 MARCH 1981
 APPROVED BY
 C.J. KURLIN P. ENG.
 11/27/81
 52 F/16 NW-0065 T1

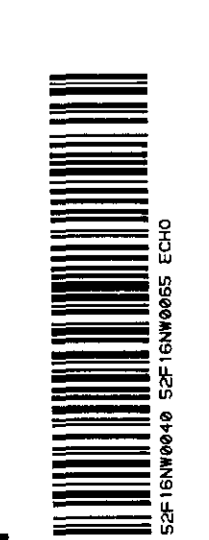

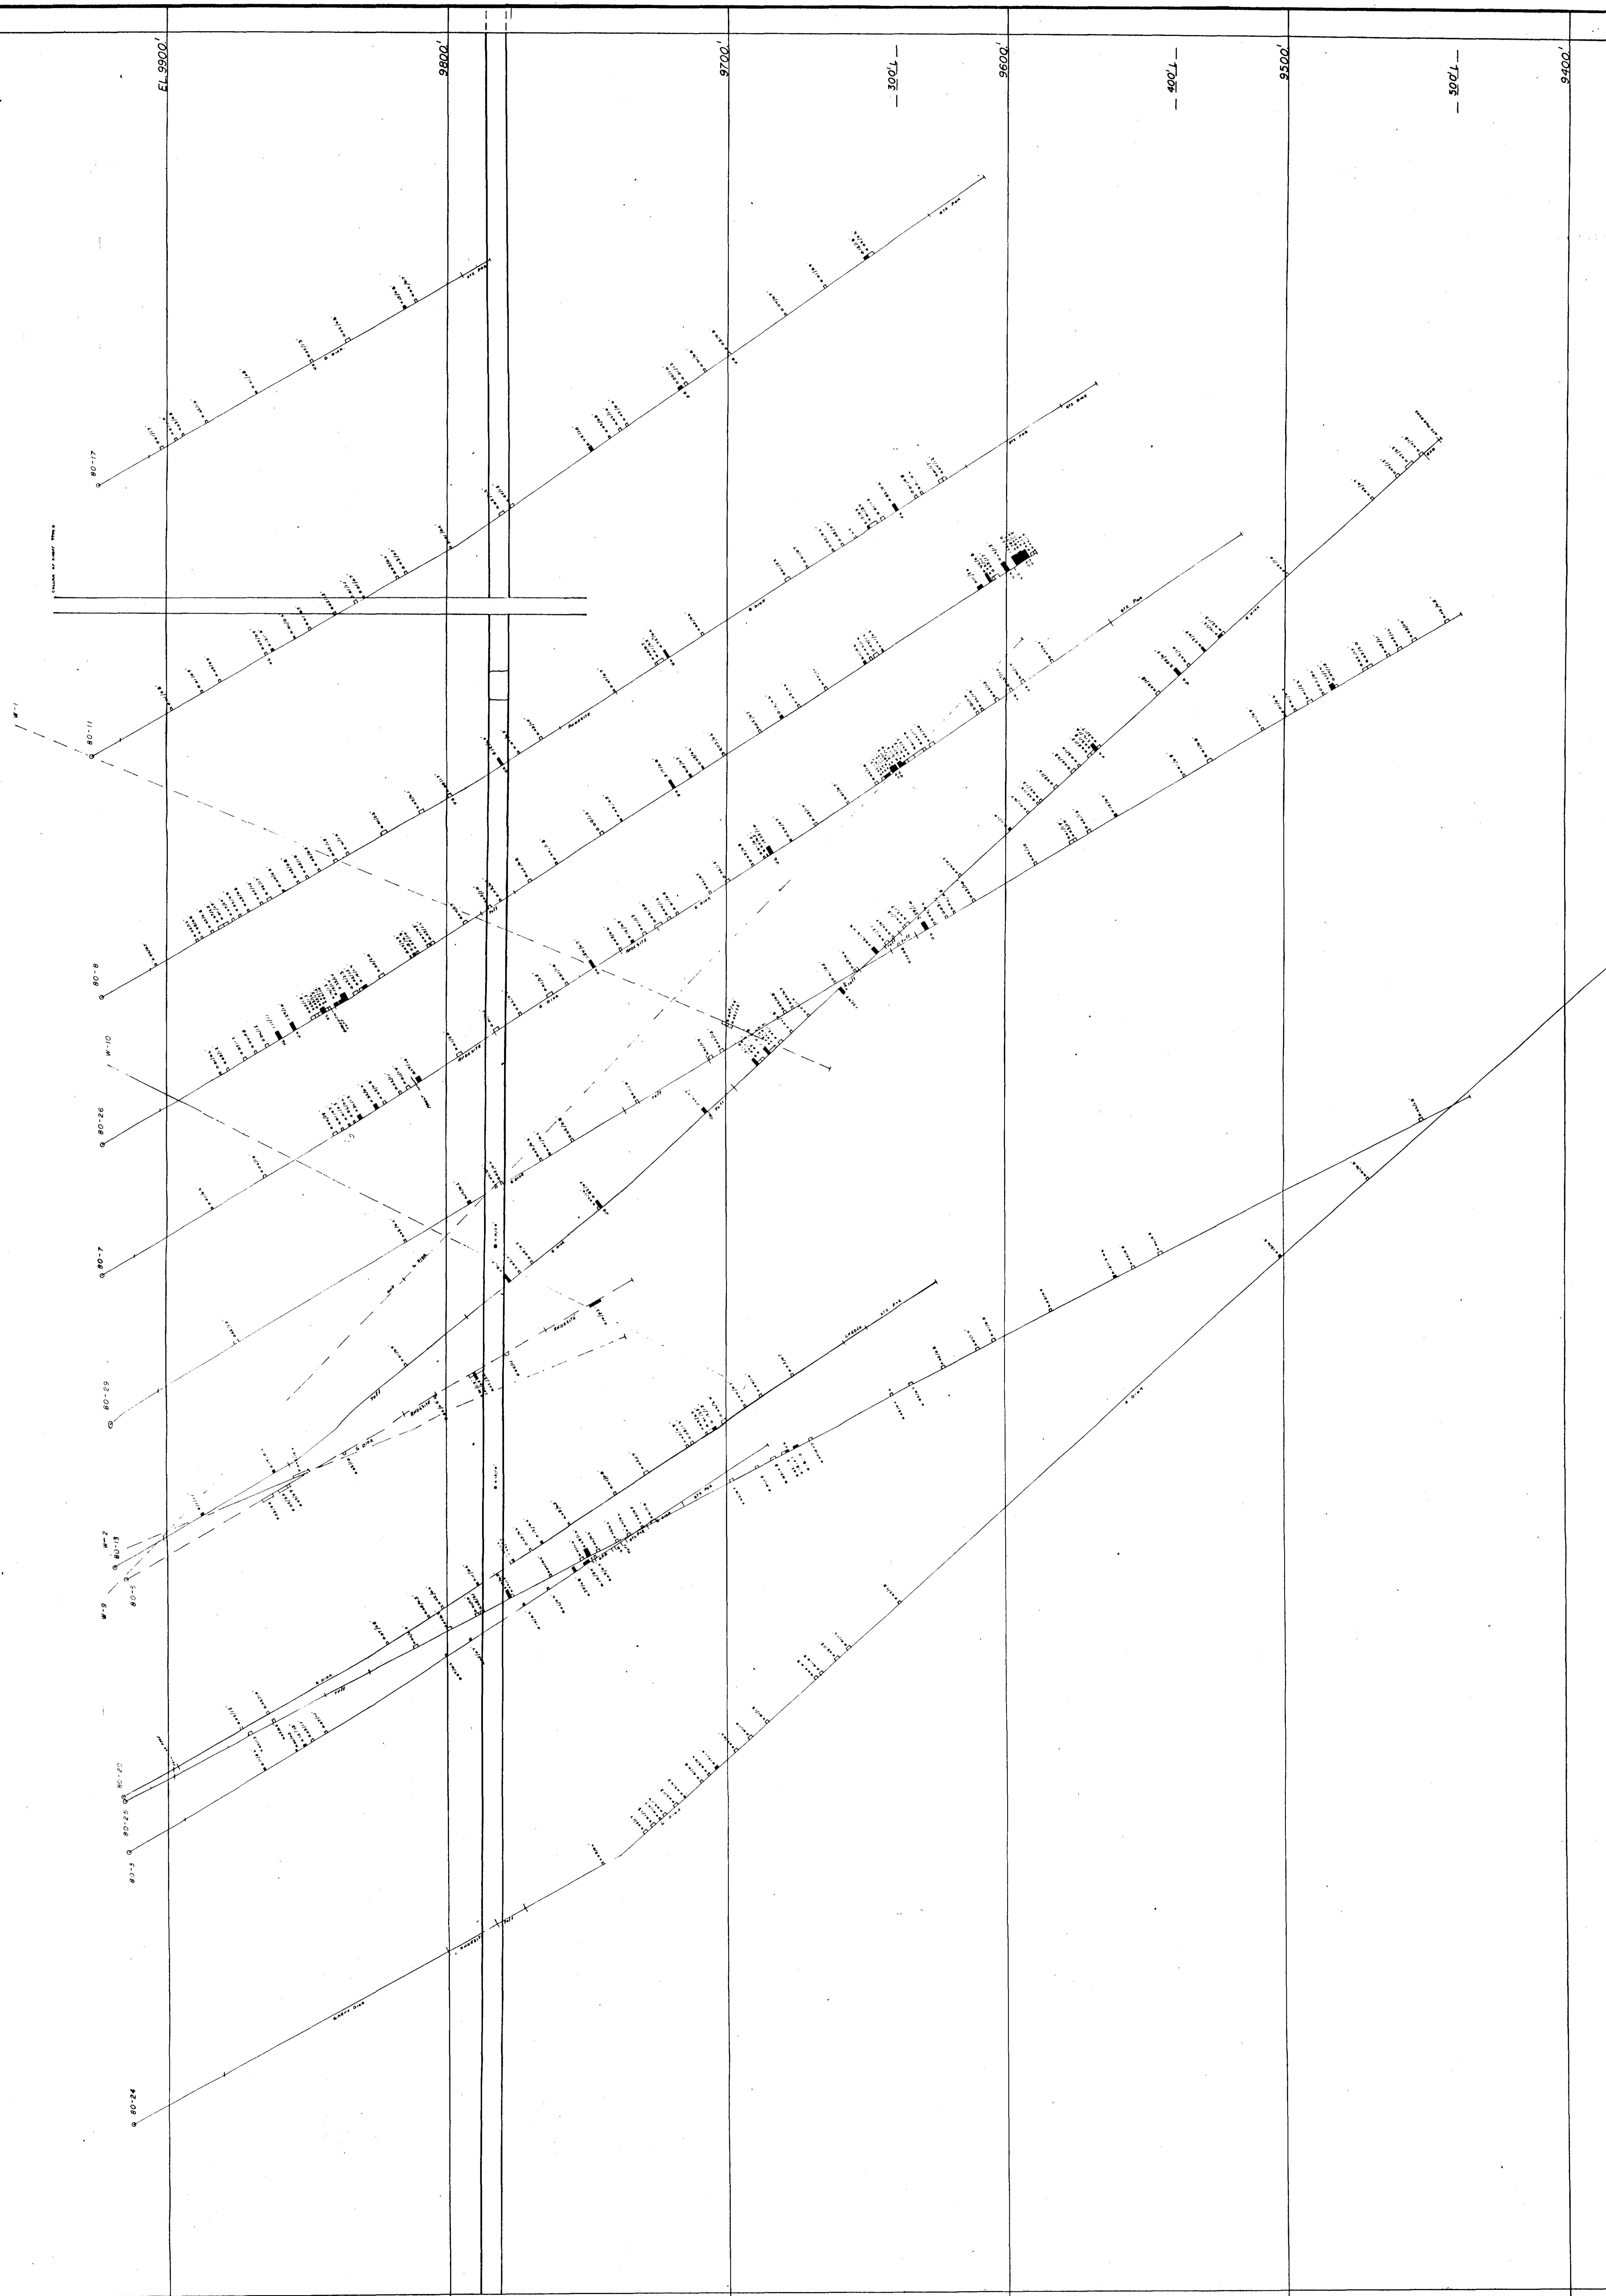


63-3734

WINDFALL OILS & MINES LTD.
AREA-2
 VERTICAL SECTION N-80°E
 NORTH GRANODIORITE
 SCALE: 1"=20'0"


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 MARCH-1981

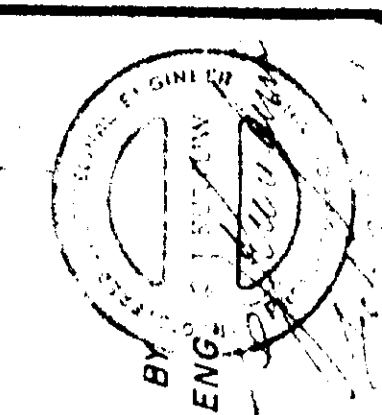

52 F/16 NW-0065 2



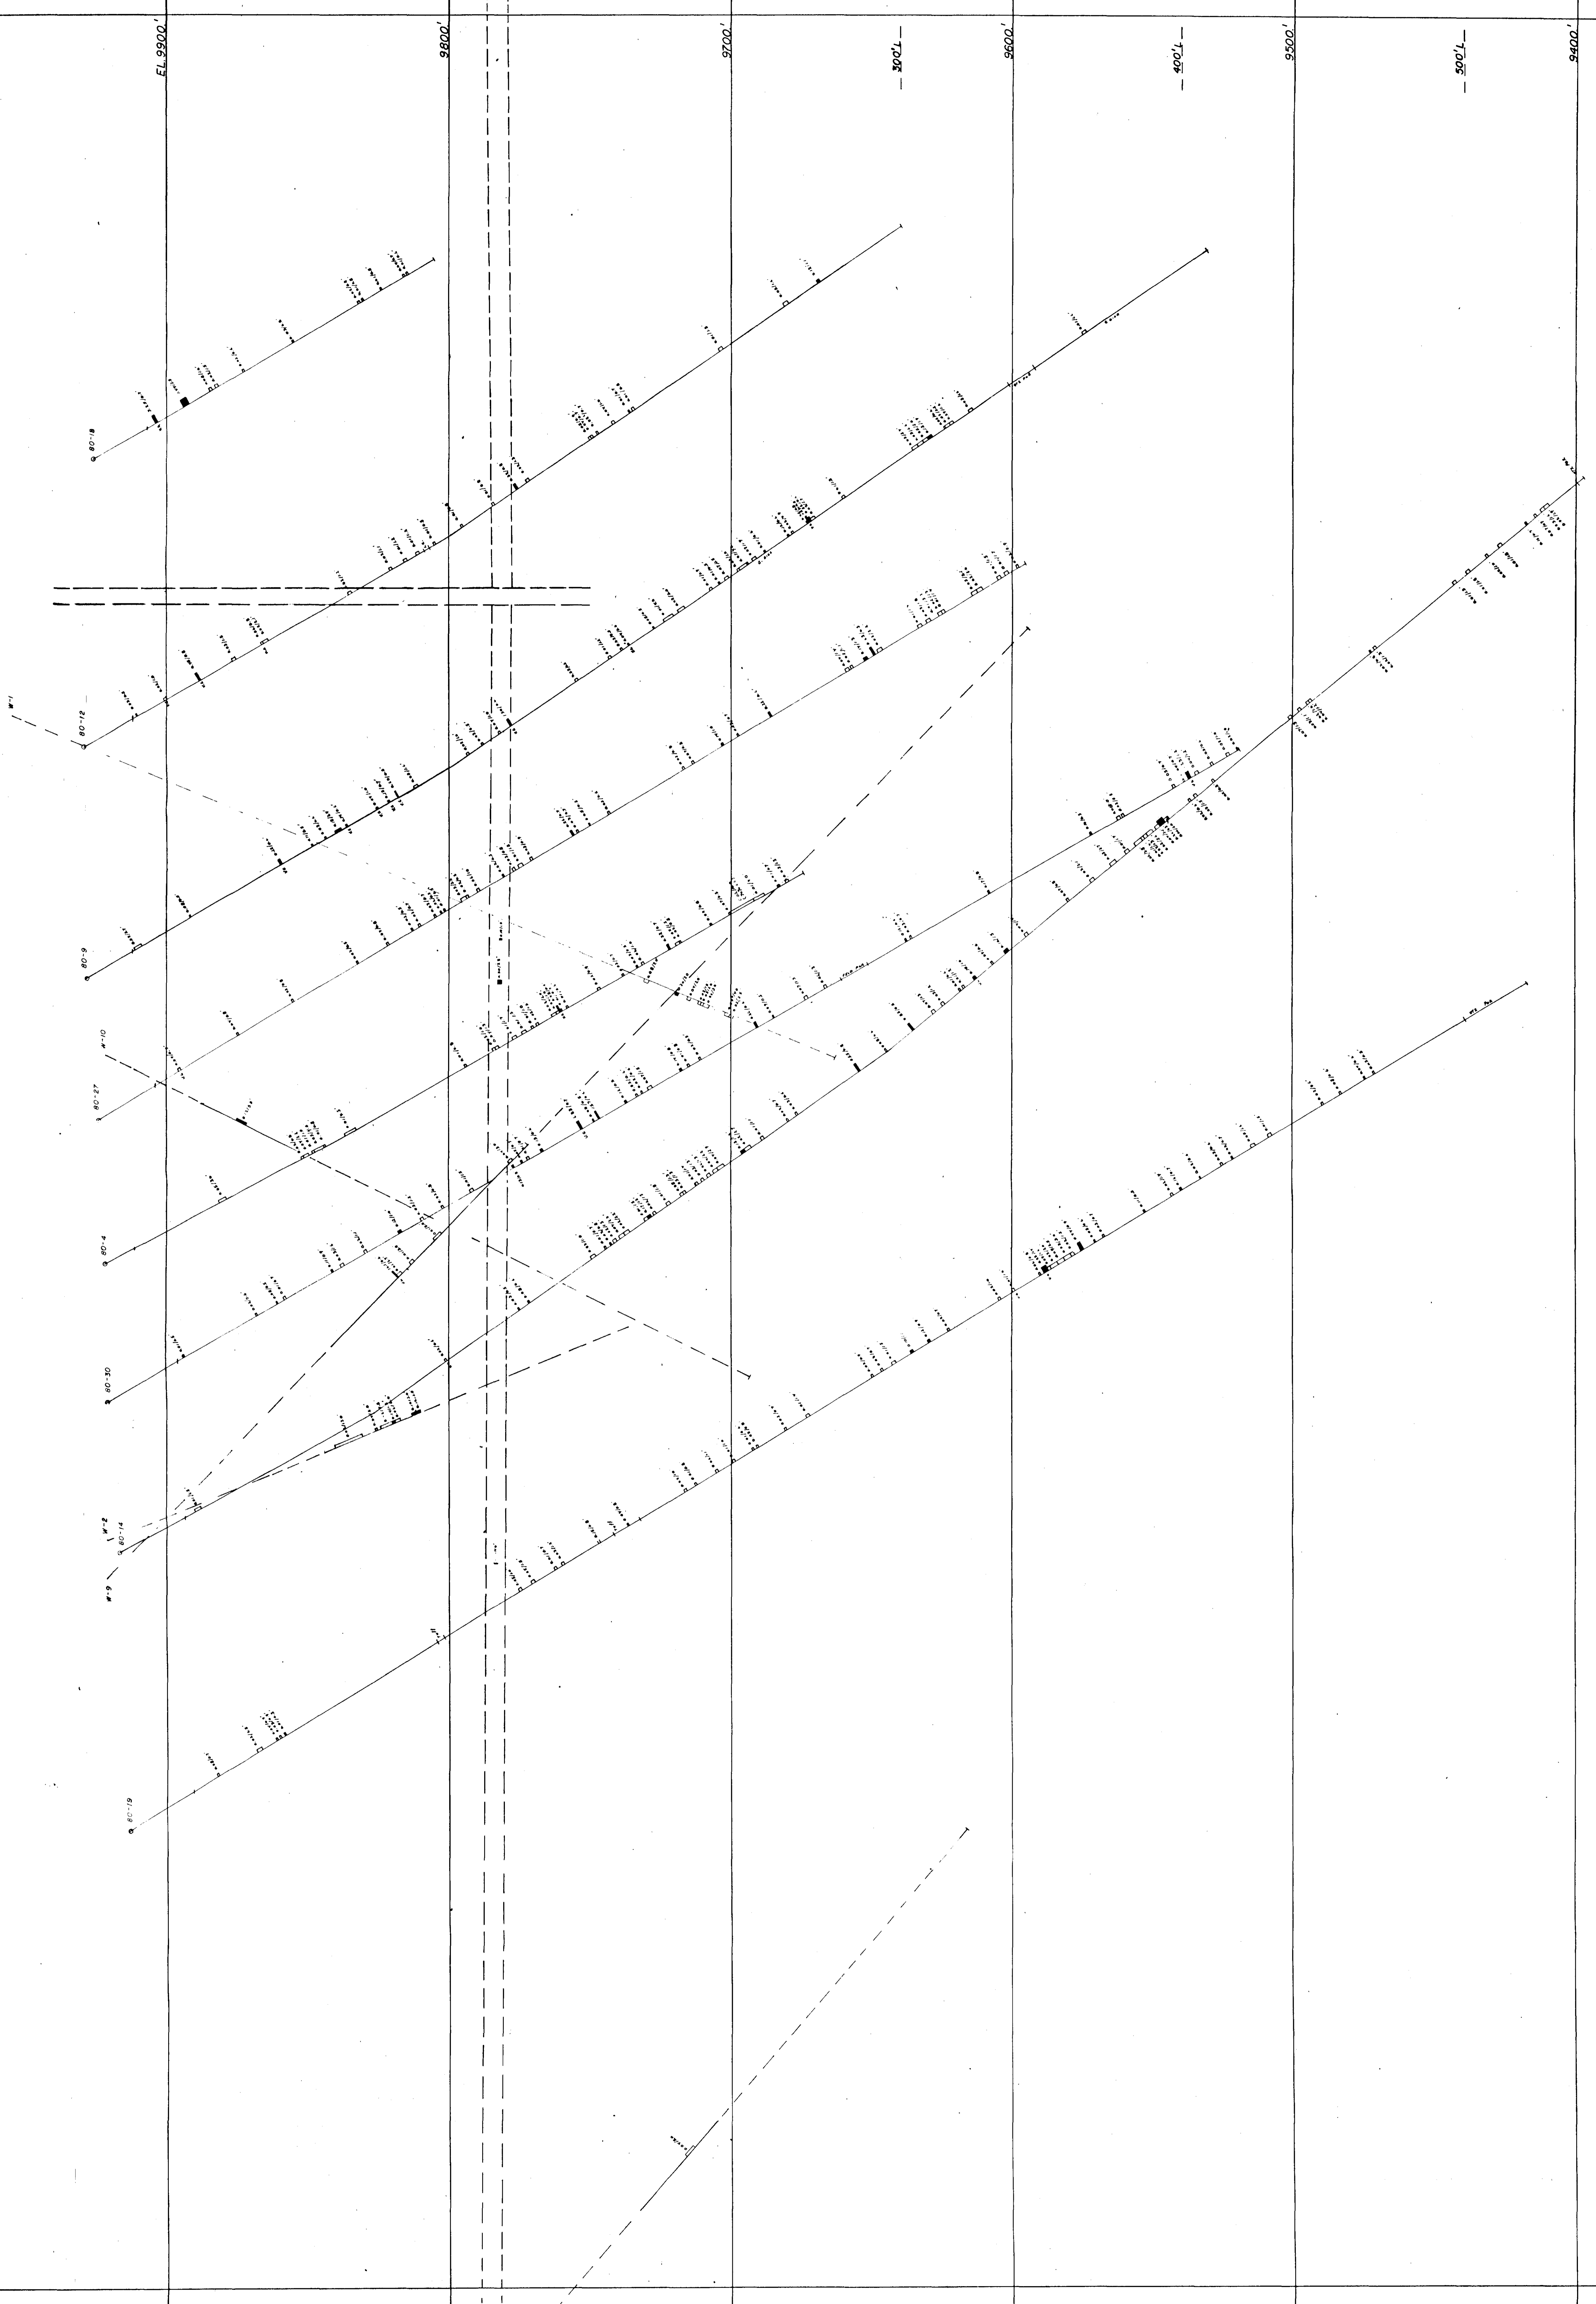

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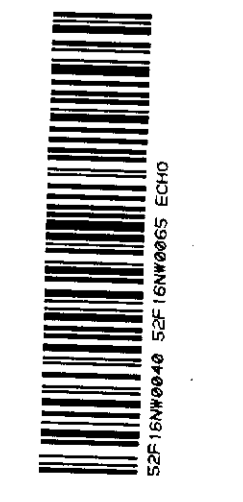
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AREA-2
 VERTICAL SECTION N-80°E
 CENTRAL GRANODIORITE
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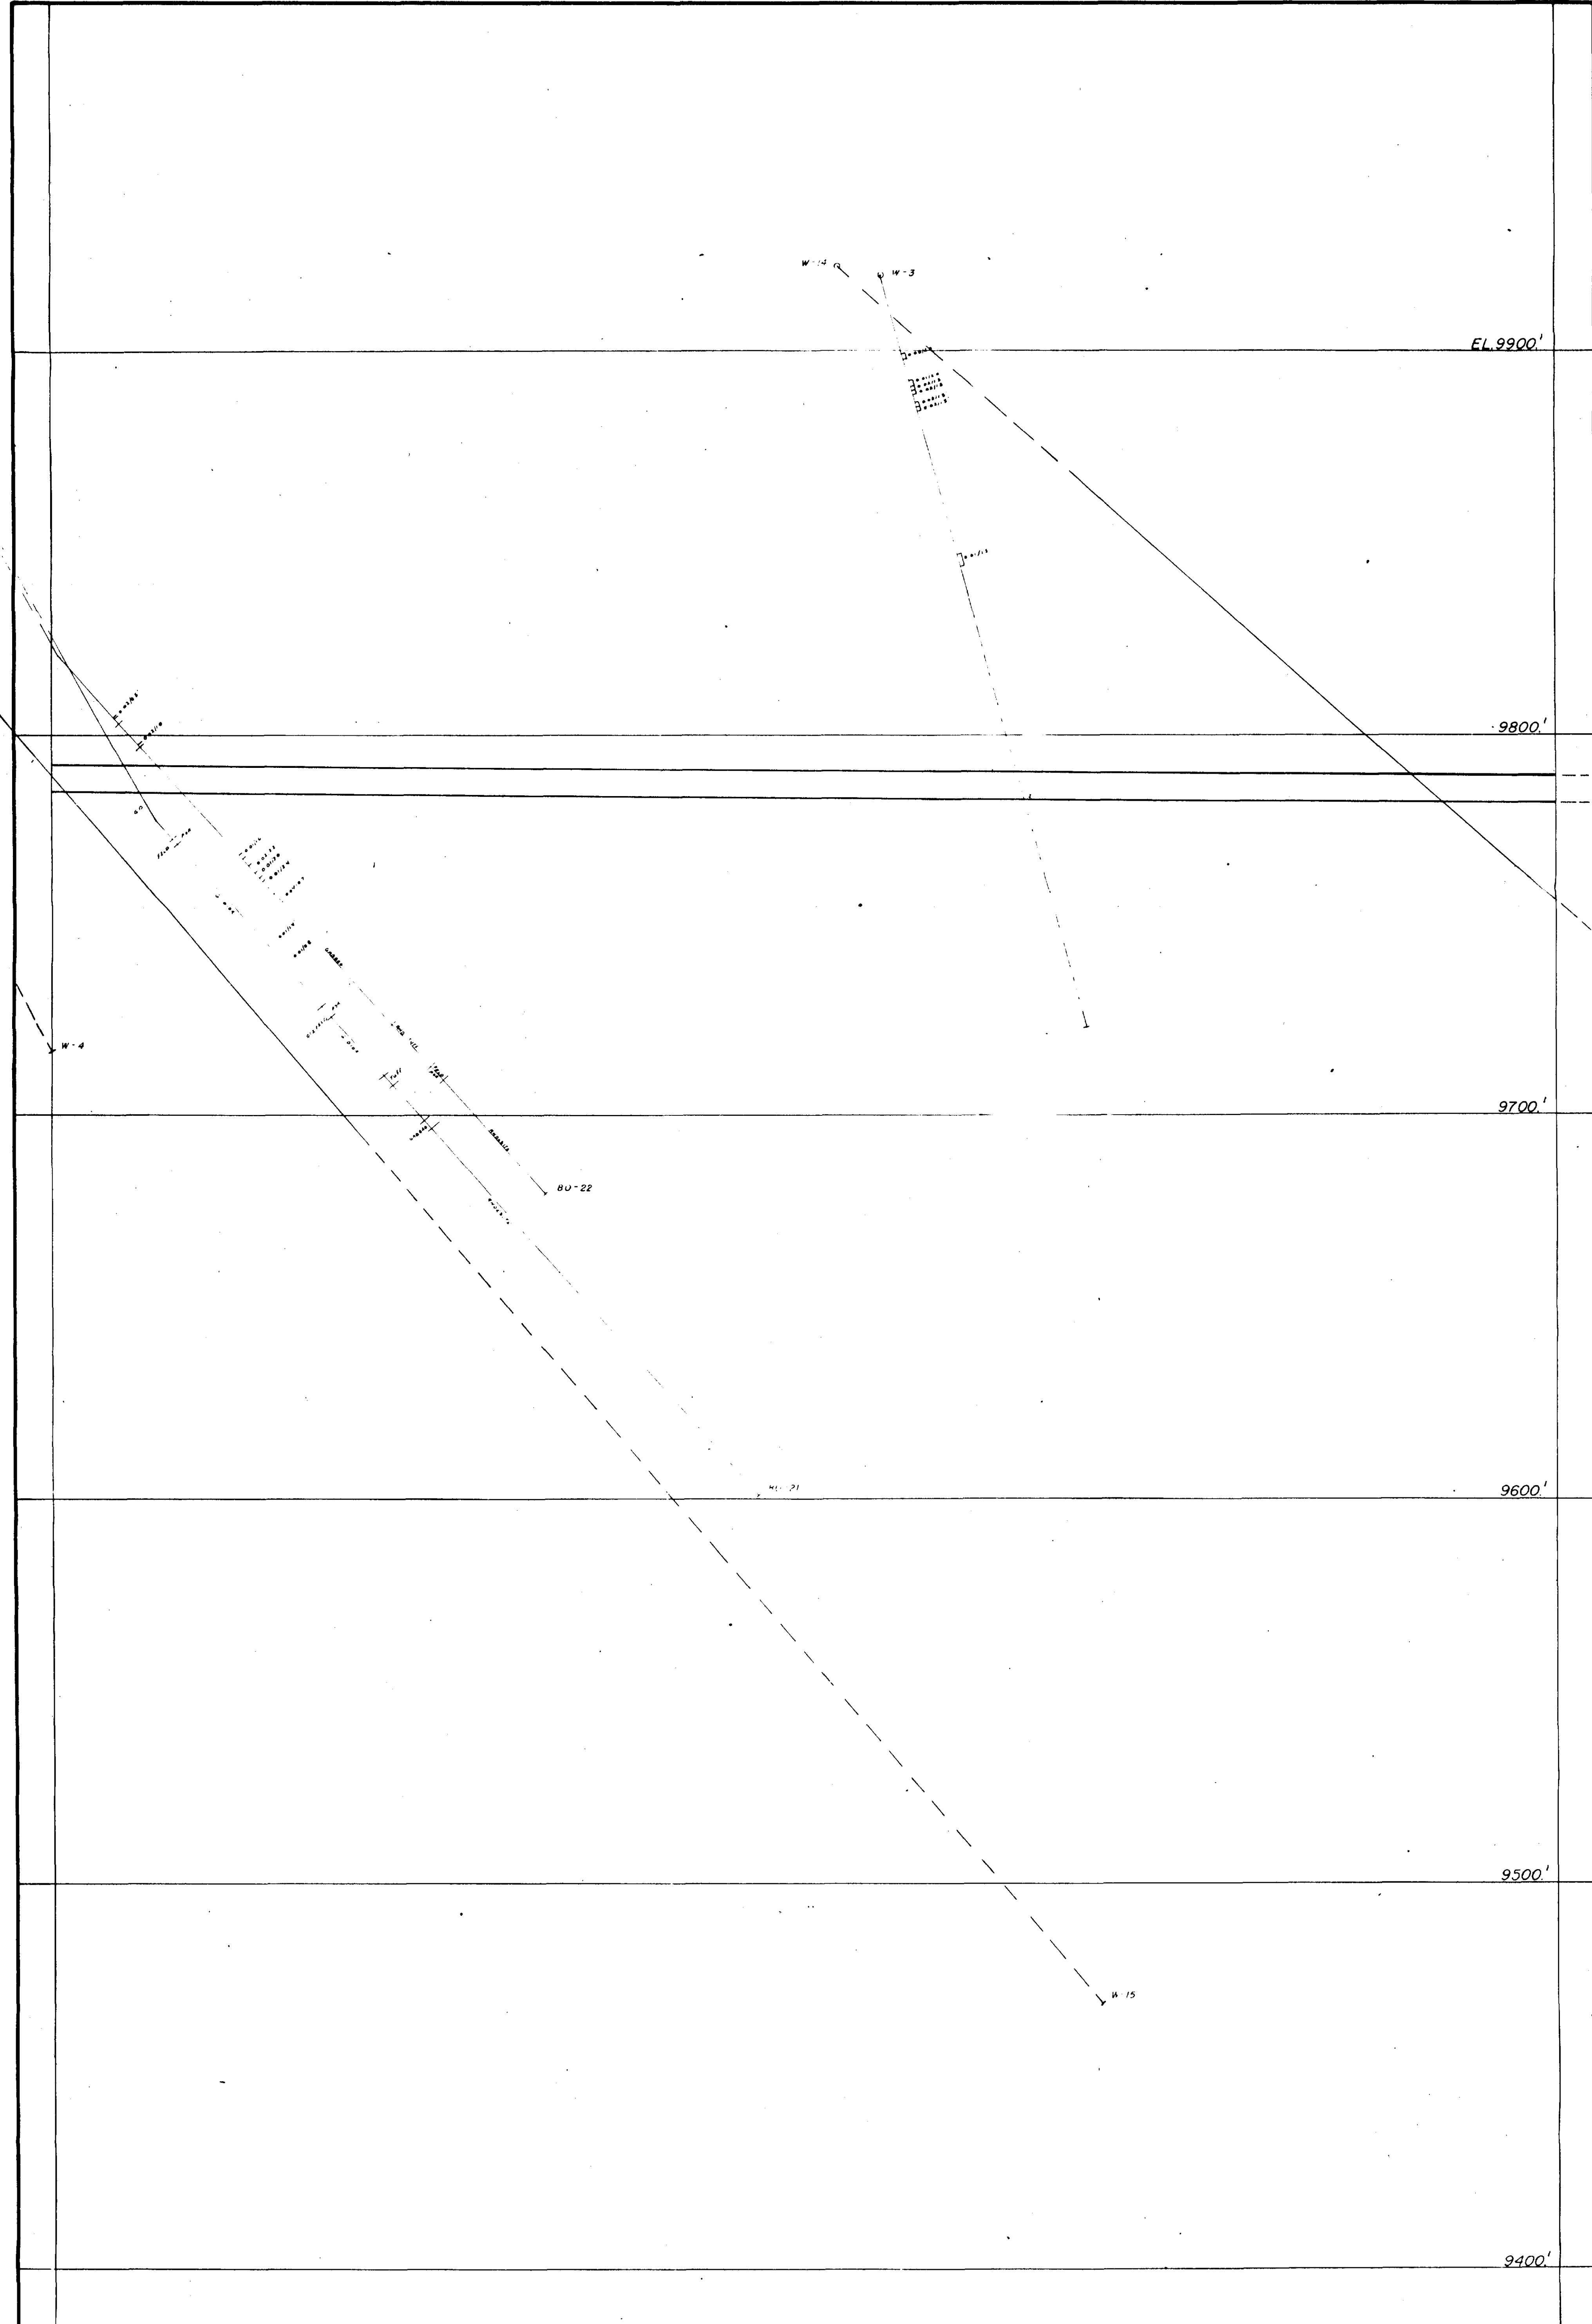
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 MARCH 1981

APPROVED BY
 C.J. KURYLW P. ENG.



52.F/16 NW-0065 #3





EL. 9900'

9800'

9700'

9600'

9500'

9400'


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WINDFALL OILS & MINES LTD.
AREA-2A
 COMPOSITE LONGITUDINAL SECTION OF D.D.H.
 NORTH GRANODIORITE

SCALE: 1" = 20' 0

DRN. BY J.C.
 MARCH - 1981

APPR'D BY
 C.J. KURLIOW P. ENG.

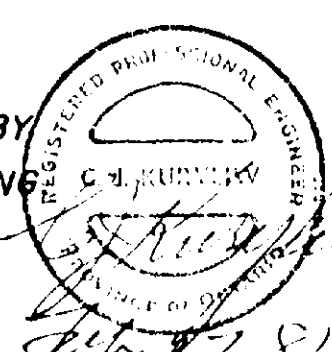

W 14 R Q W 15

EL. 9900'

9800'

9700'

9600'

9500'

9400'

63-3934


WINDFALL OILS & MINES LTD.
AREA-2A
COMPOSITE LONGITUDINAL SECTION OF D.D.H.
SOUTH GRANODIORITE


SCALE: 1"=20' 0



DRN. BY J.C.
MARCH 1981

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C. J. KURYLIW, P. ENG.

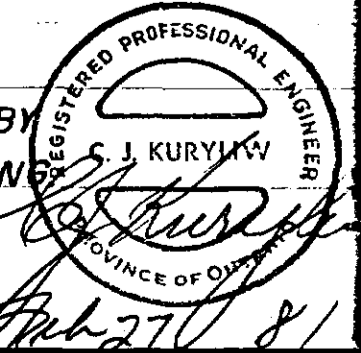

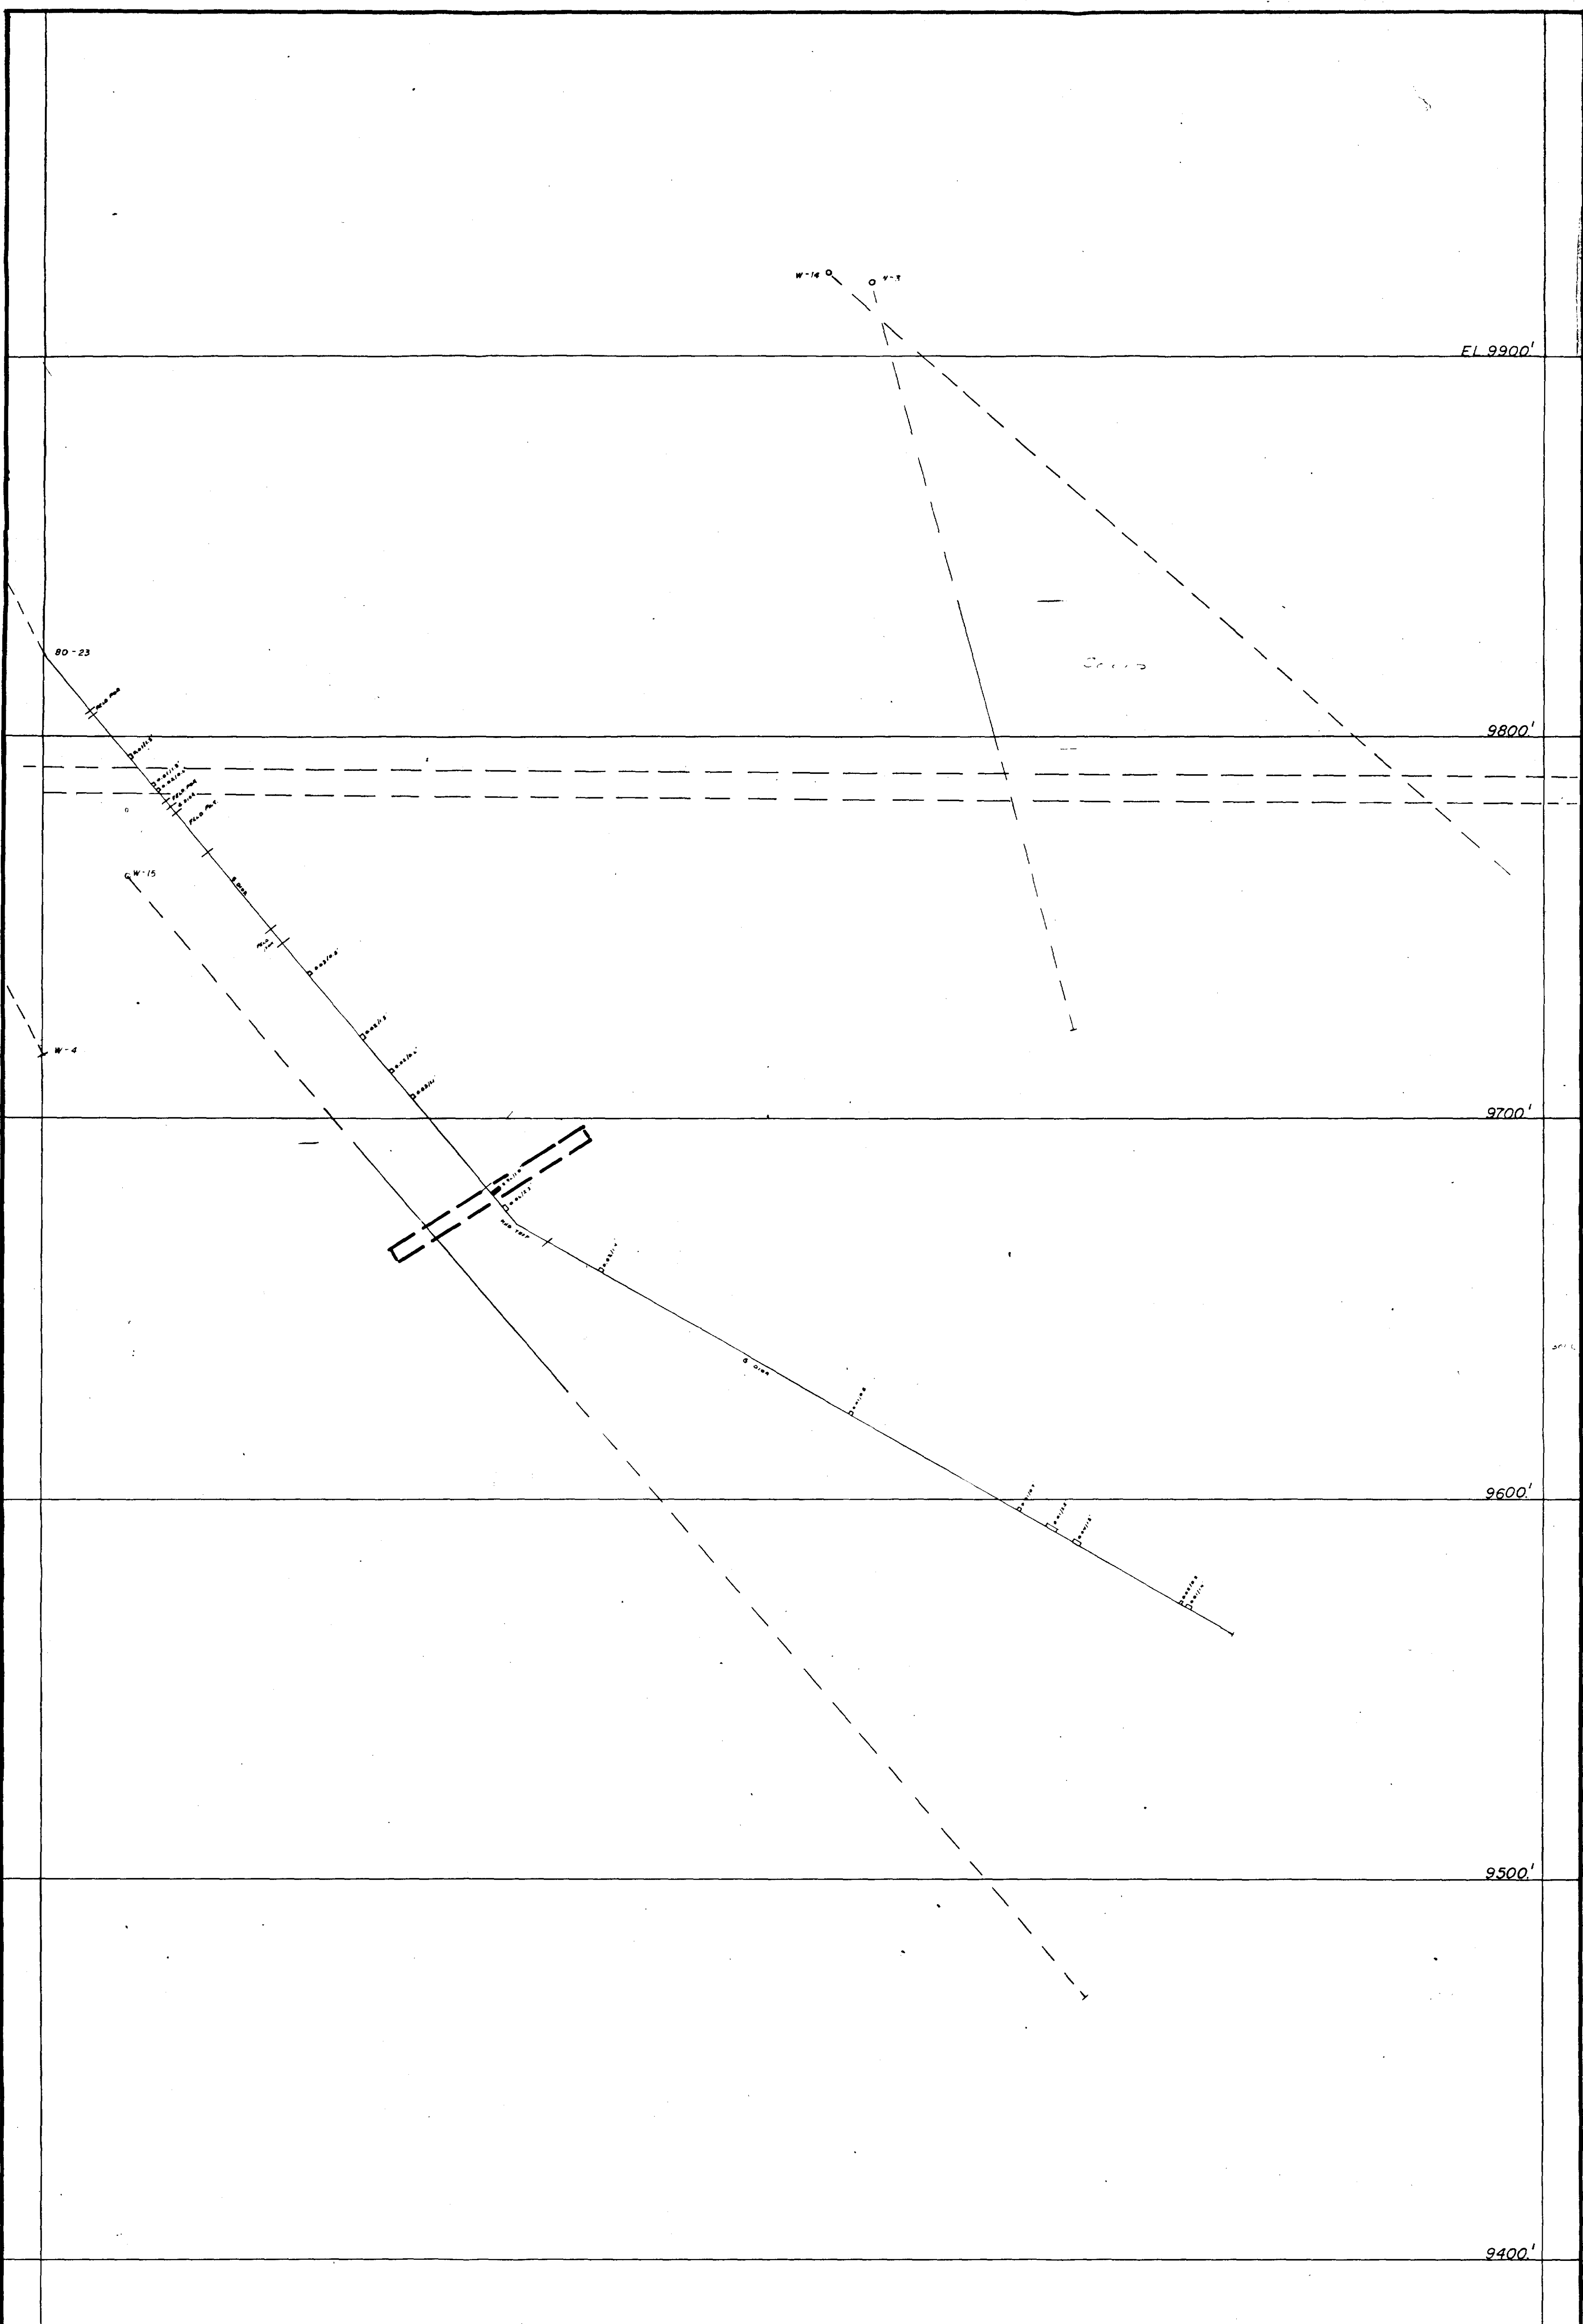

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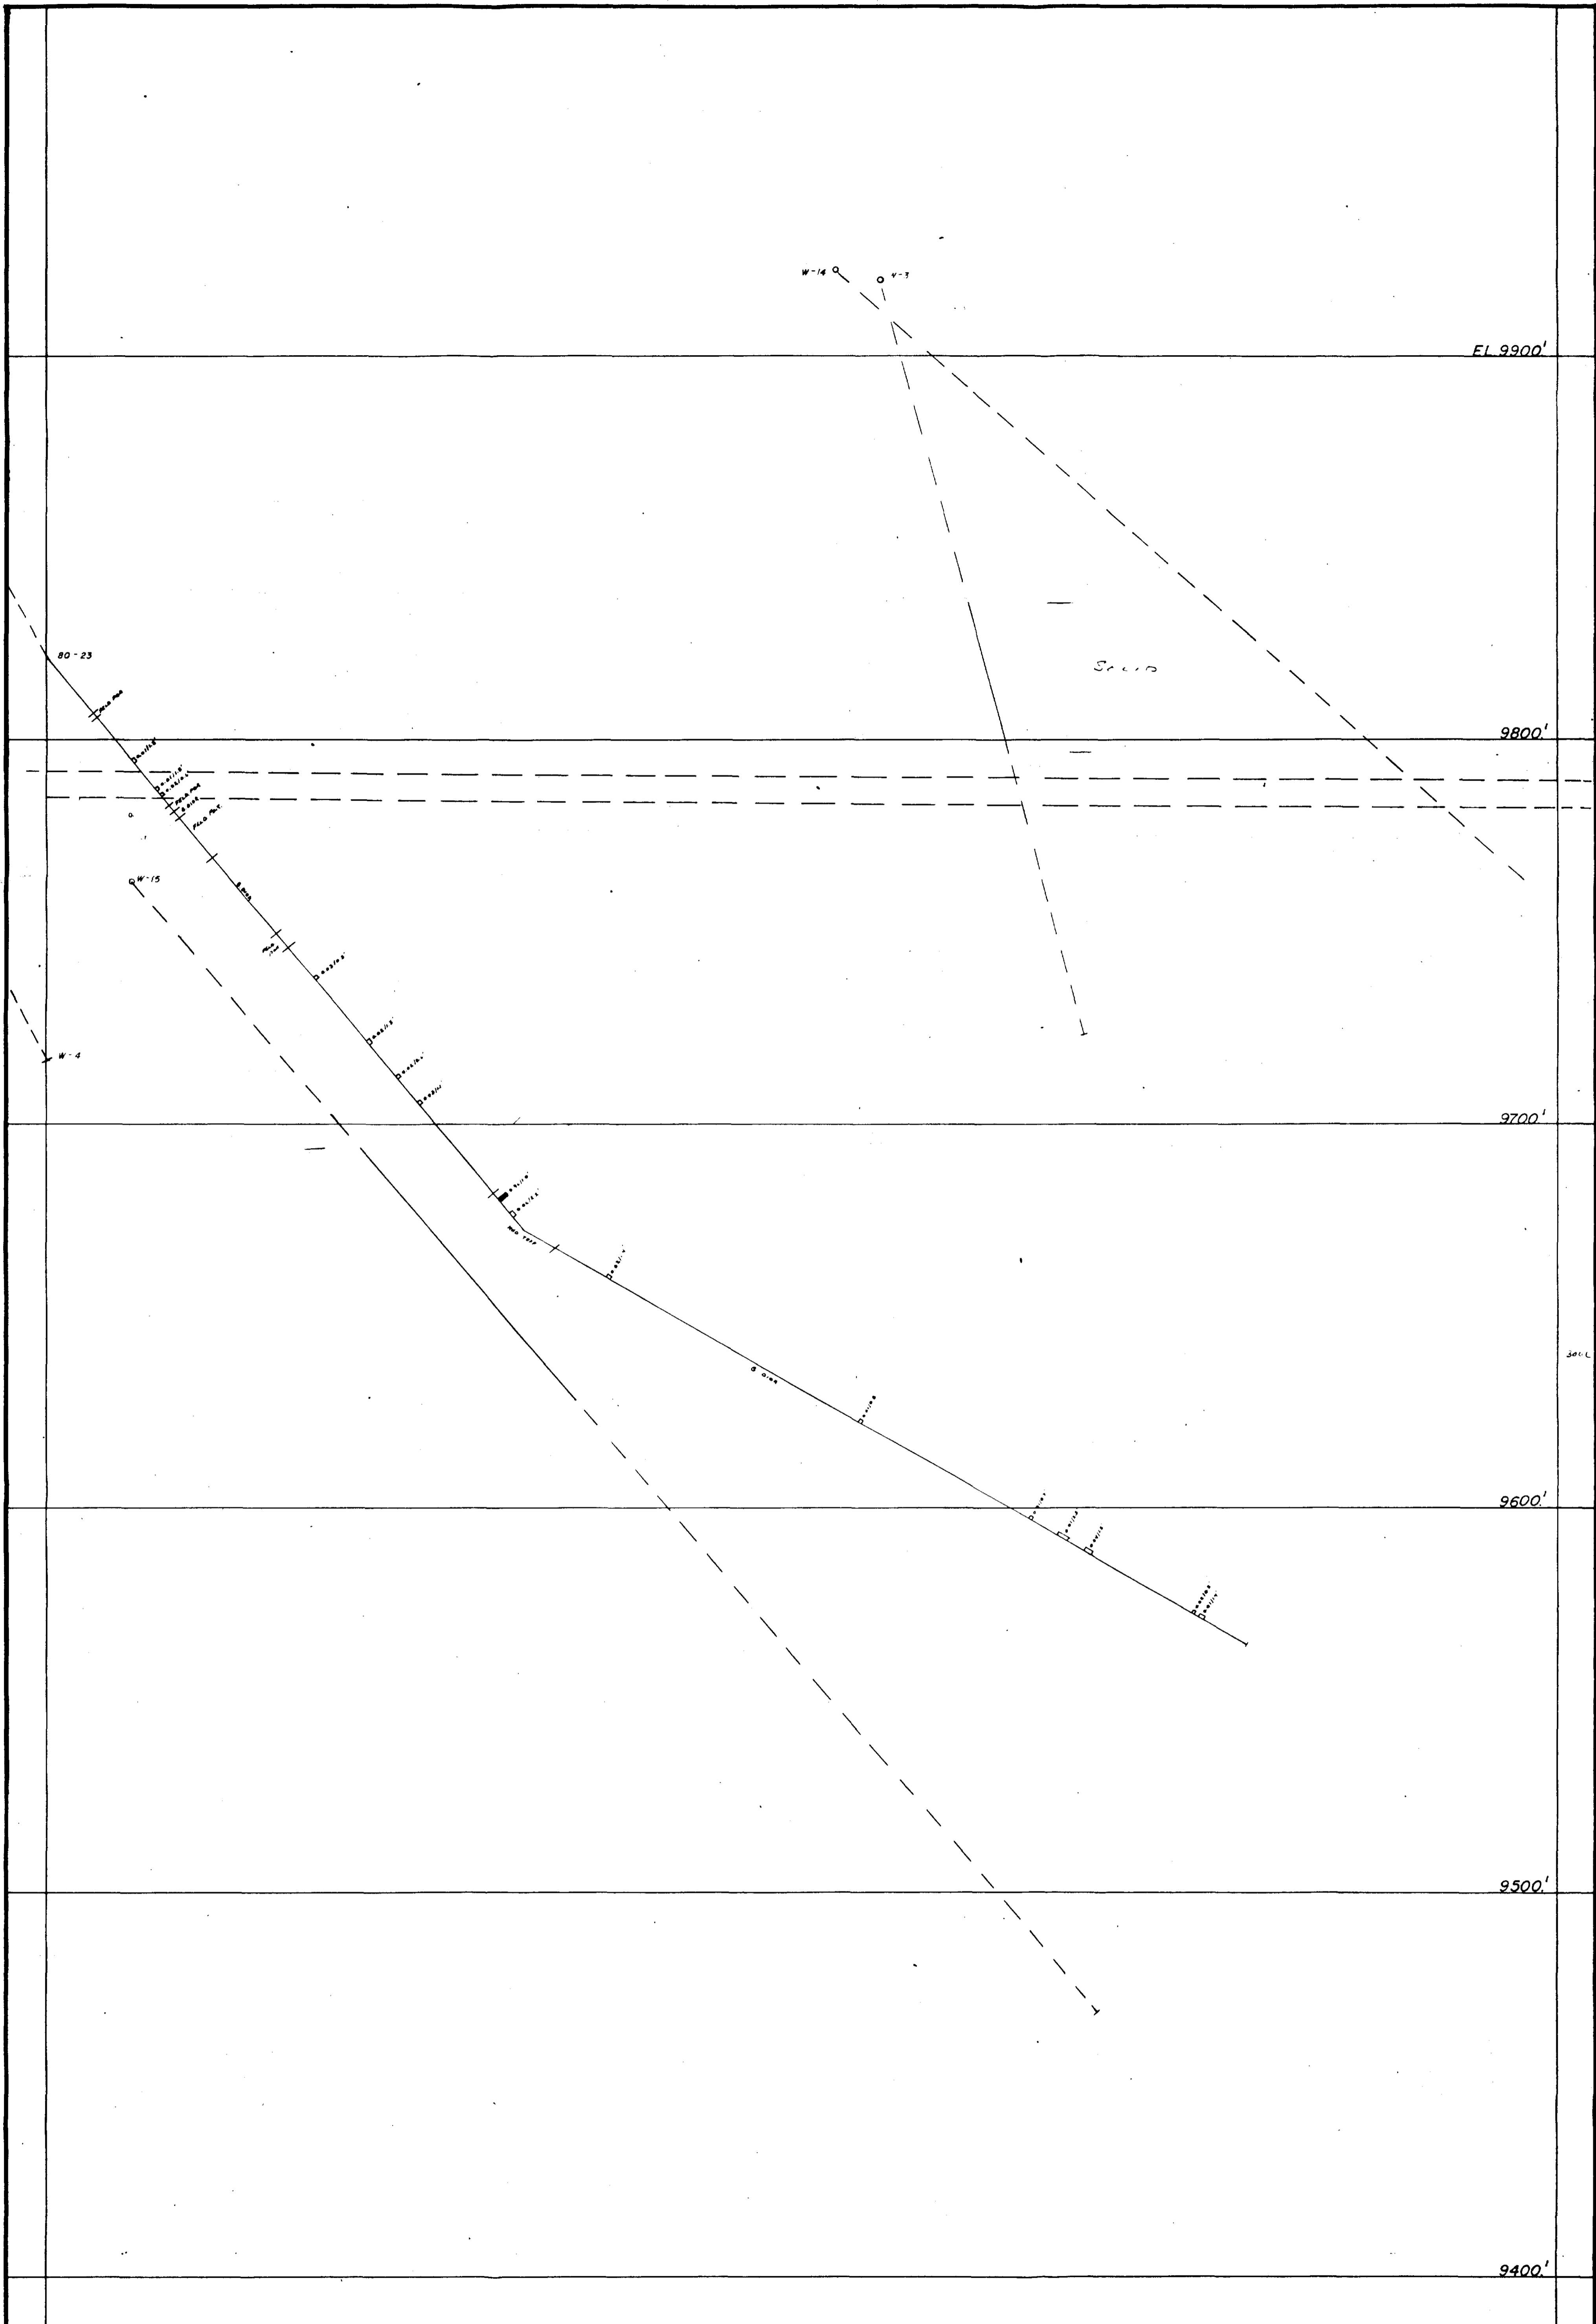
□ OUTLINES OF "ORE"
WINDFALL OILS & MINES LTD.
AREA-2A
 COMPOSITE LONGITUDINAL SECTION OF D.D.H.
 CENTRAL GRANODIORITE

SCALE: 1" = 20' 0

DRN. BY J.C.
 MARCH - 1981

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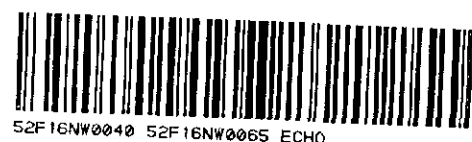
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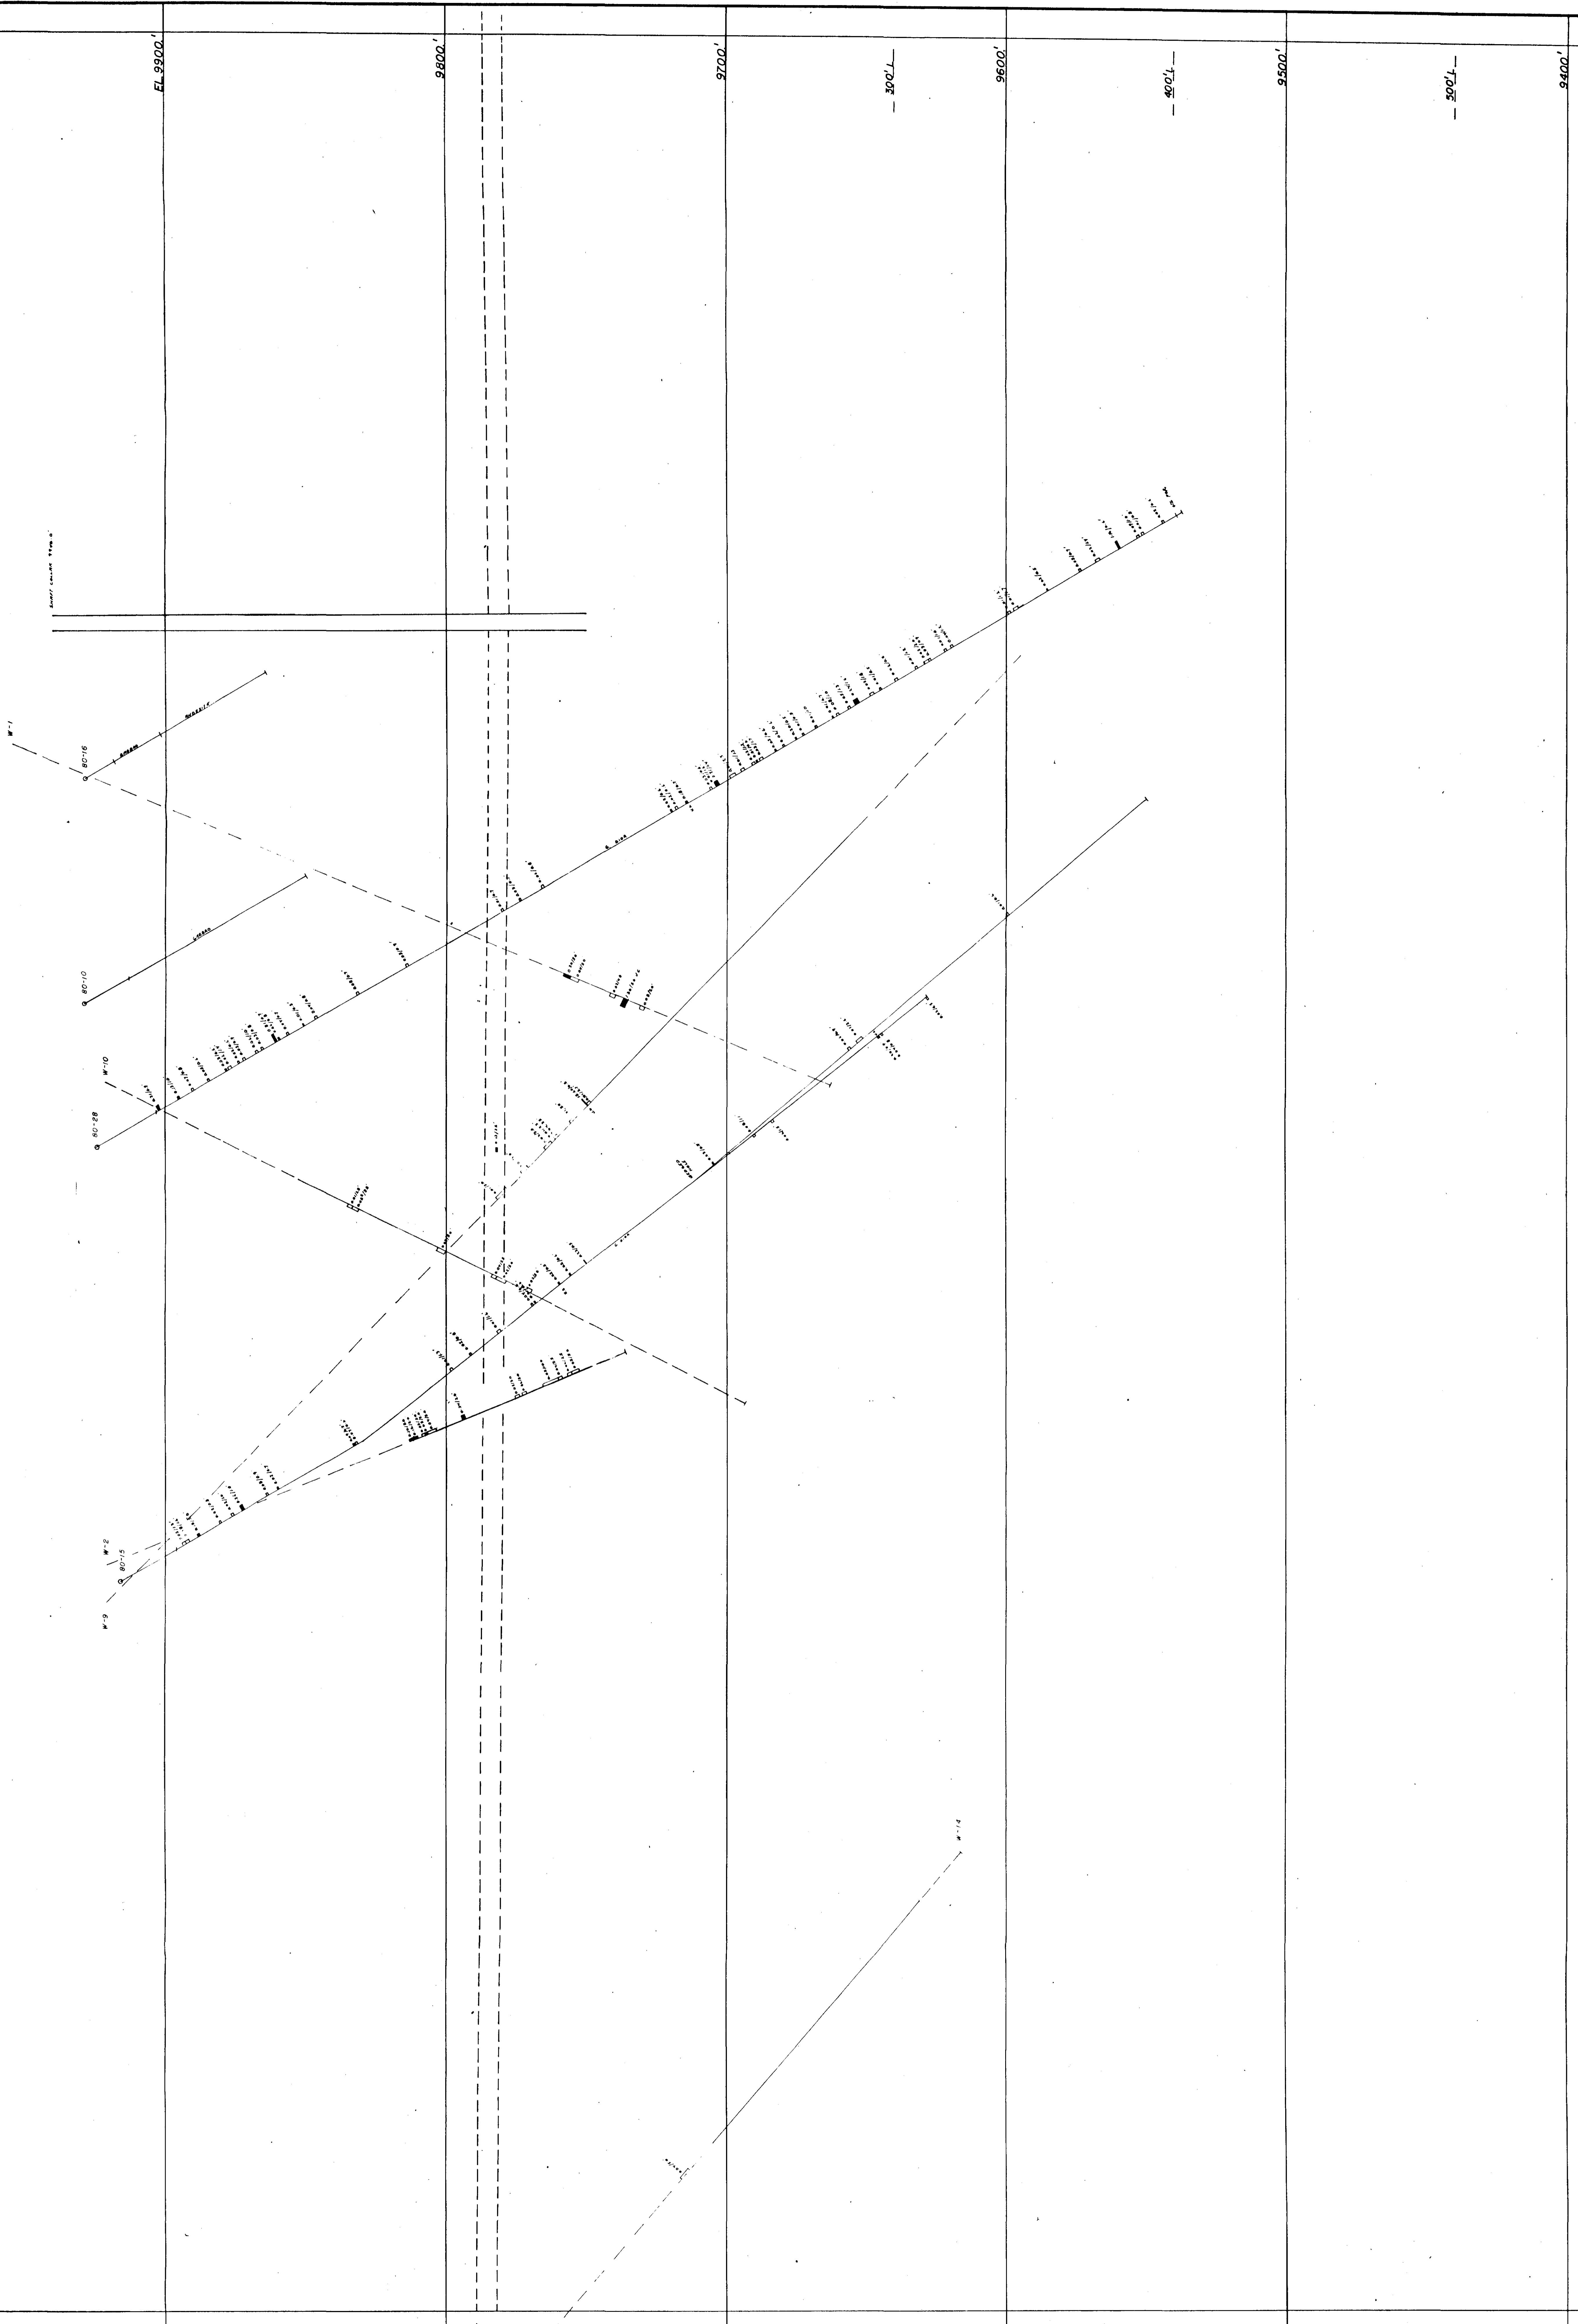
WINDFALL OILS & MINES LTD.
AREA-2A
 COMPOSITE LONGITUDINAL SECTION OF D.D.H.
 CENTRAL GRANODIORITE

SCALE: 1"=20' 0


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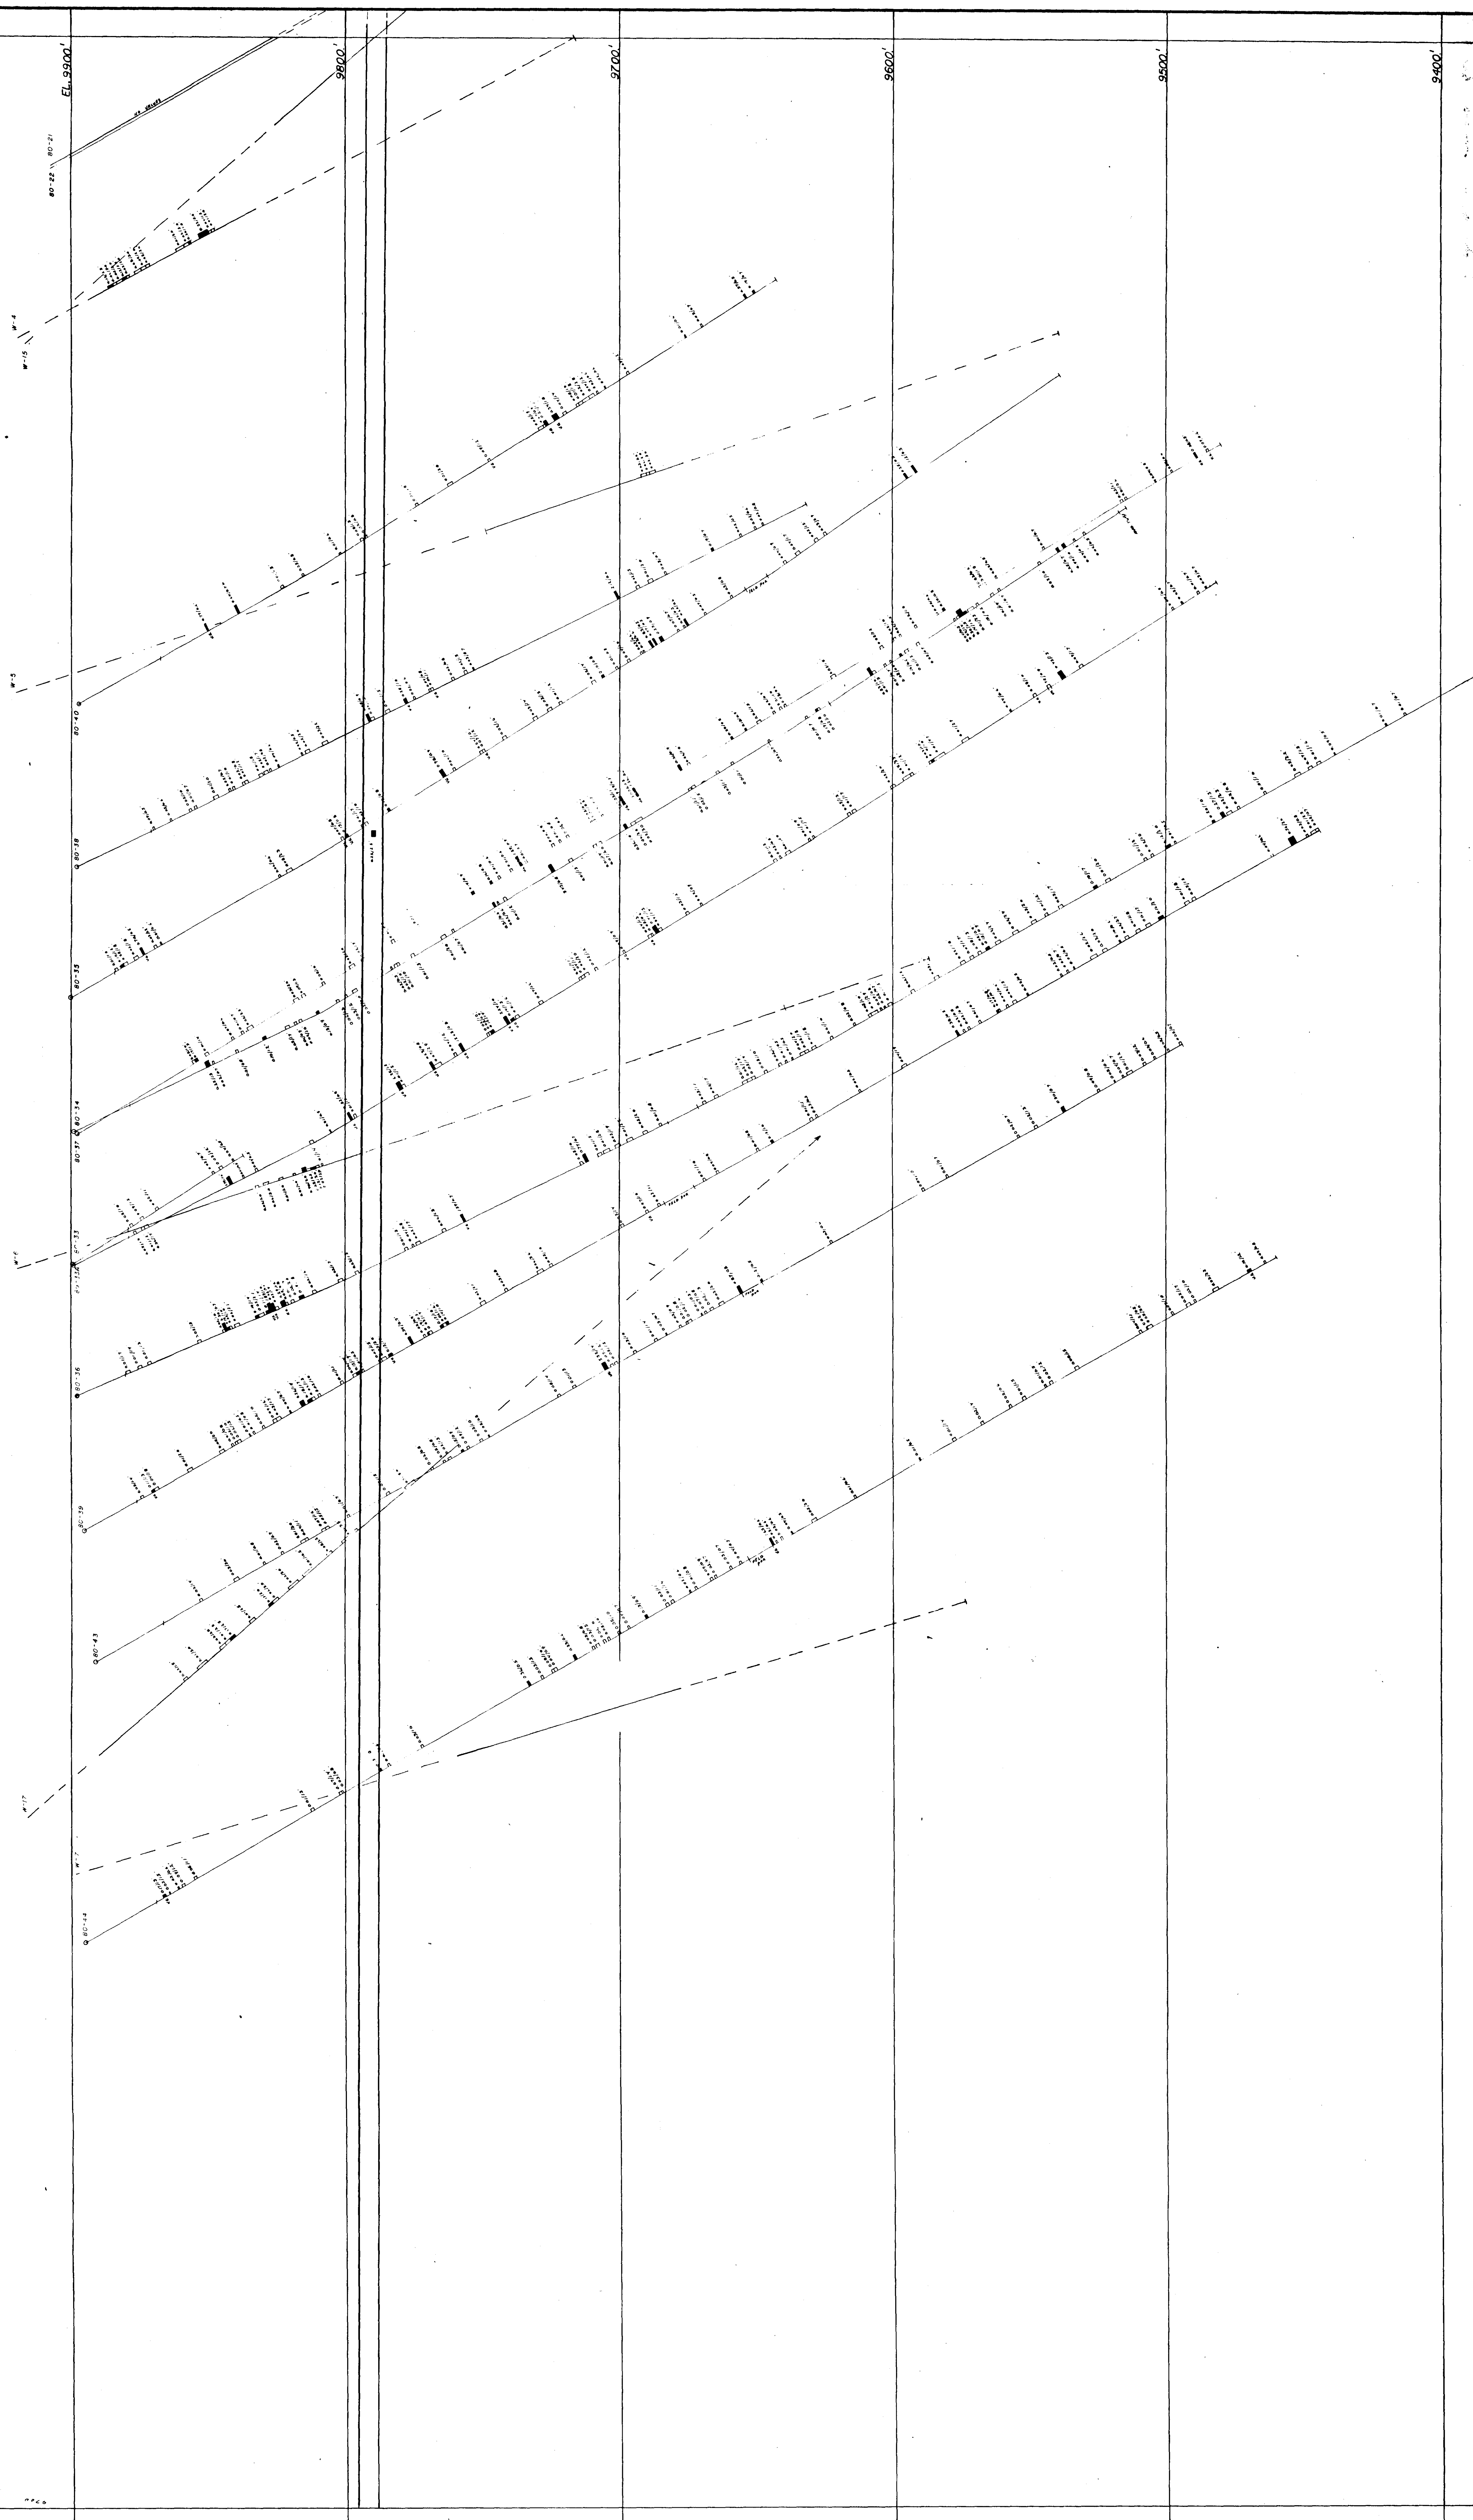
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 C.J. KURLIOW P. ENG.





52 F/16NW-0065 #2



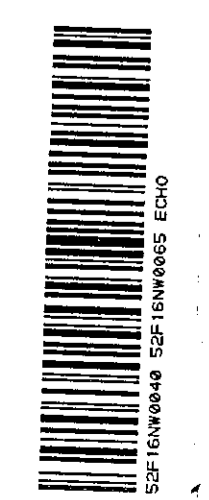

63-3737

WINDFALL OILS & MINES LTD.
AREA - 3
 COMPOSITE LONGITUDINAL SECTION OF D.D.H.
 NORTH GRANDIORITE

SCALE: 1"=20'.0

APP'D BY
 G.J. KURTILW P. ENG.


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 MARCH 1981



52 F/1/2 NU-0065-79



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63-3934

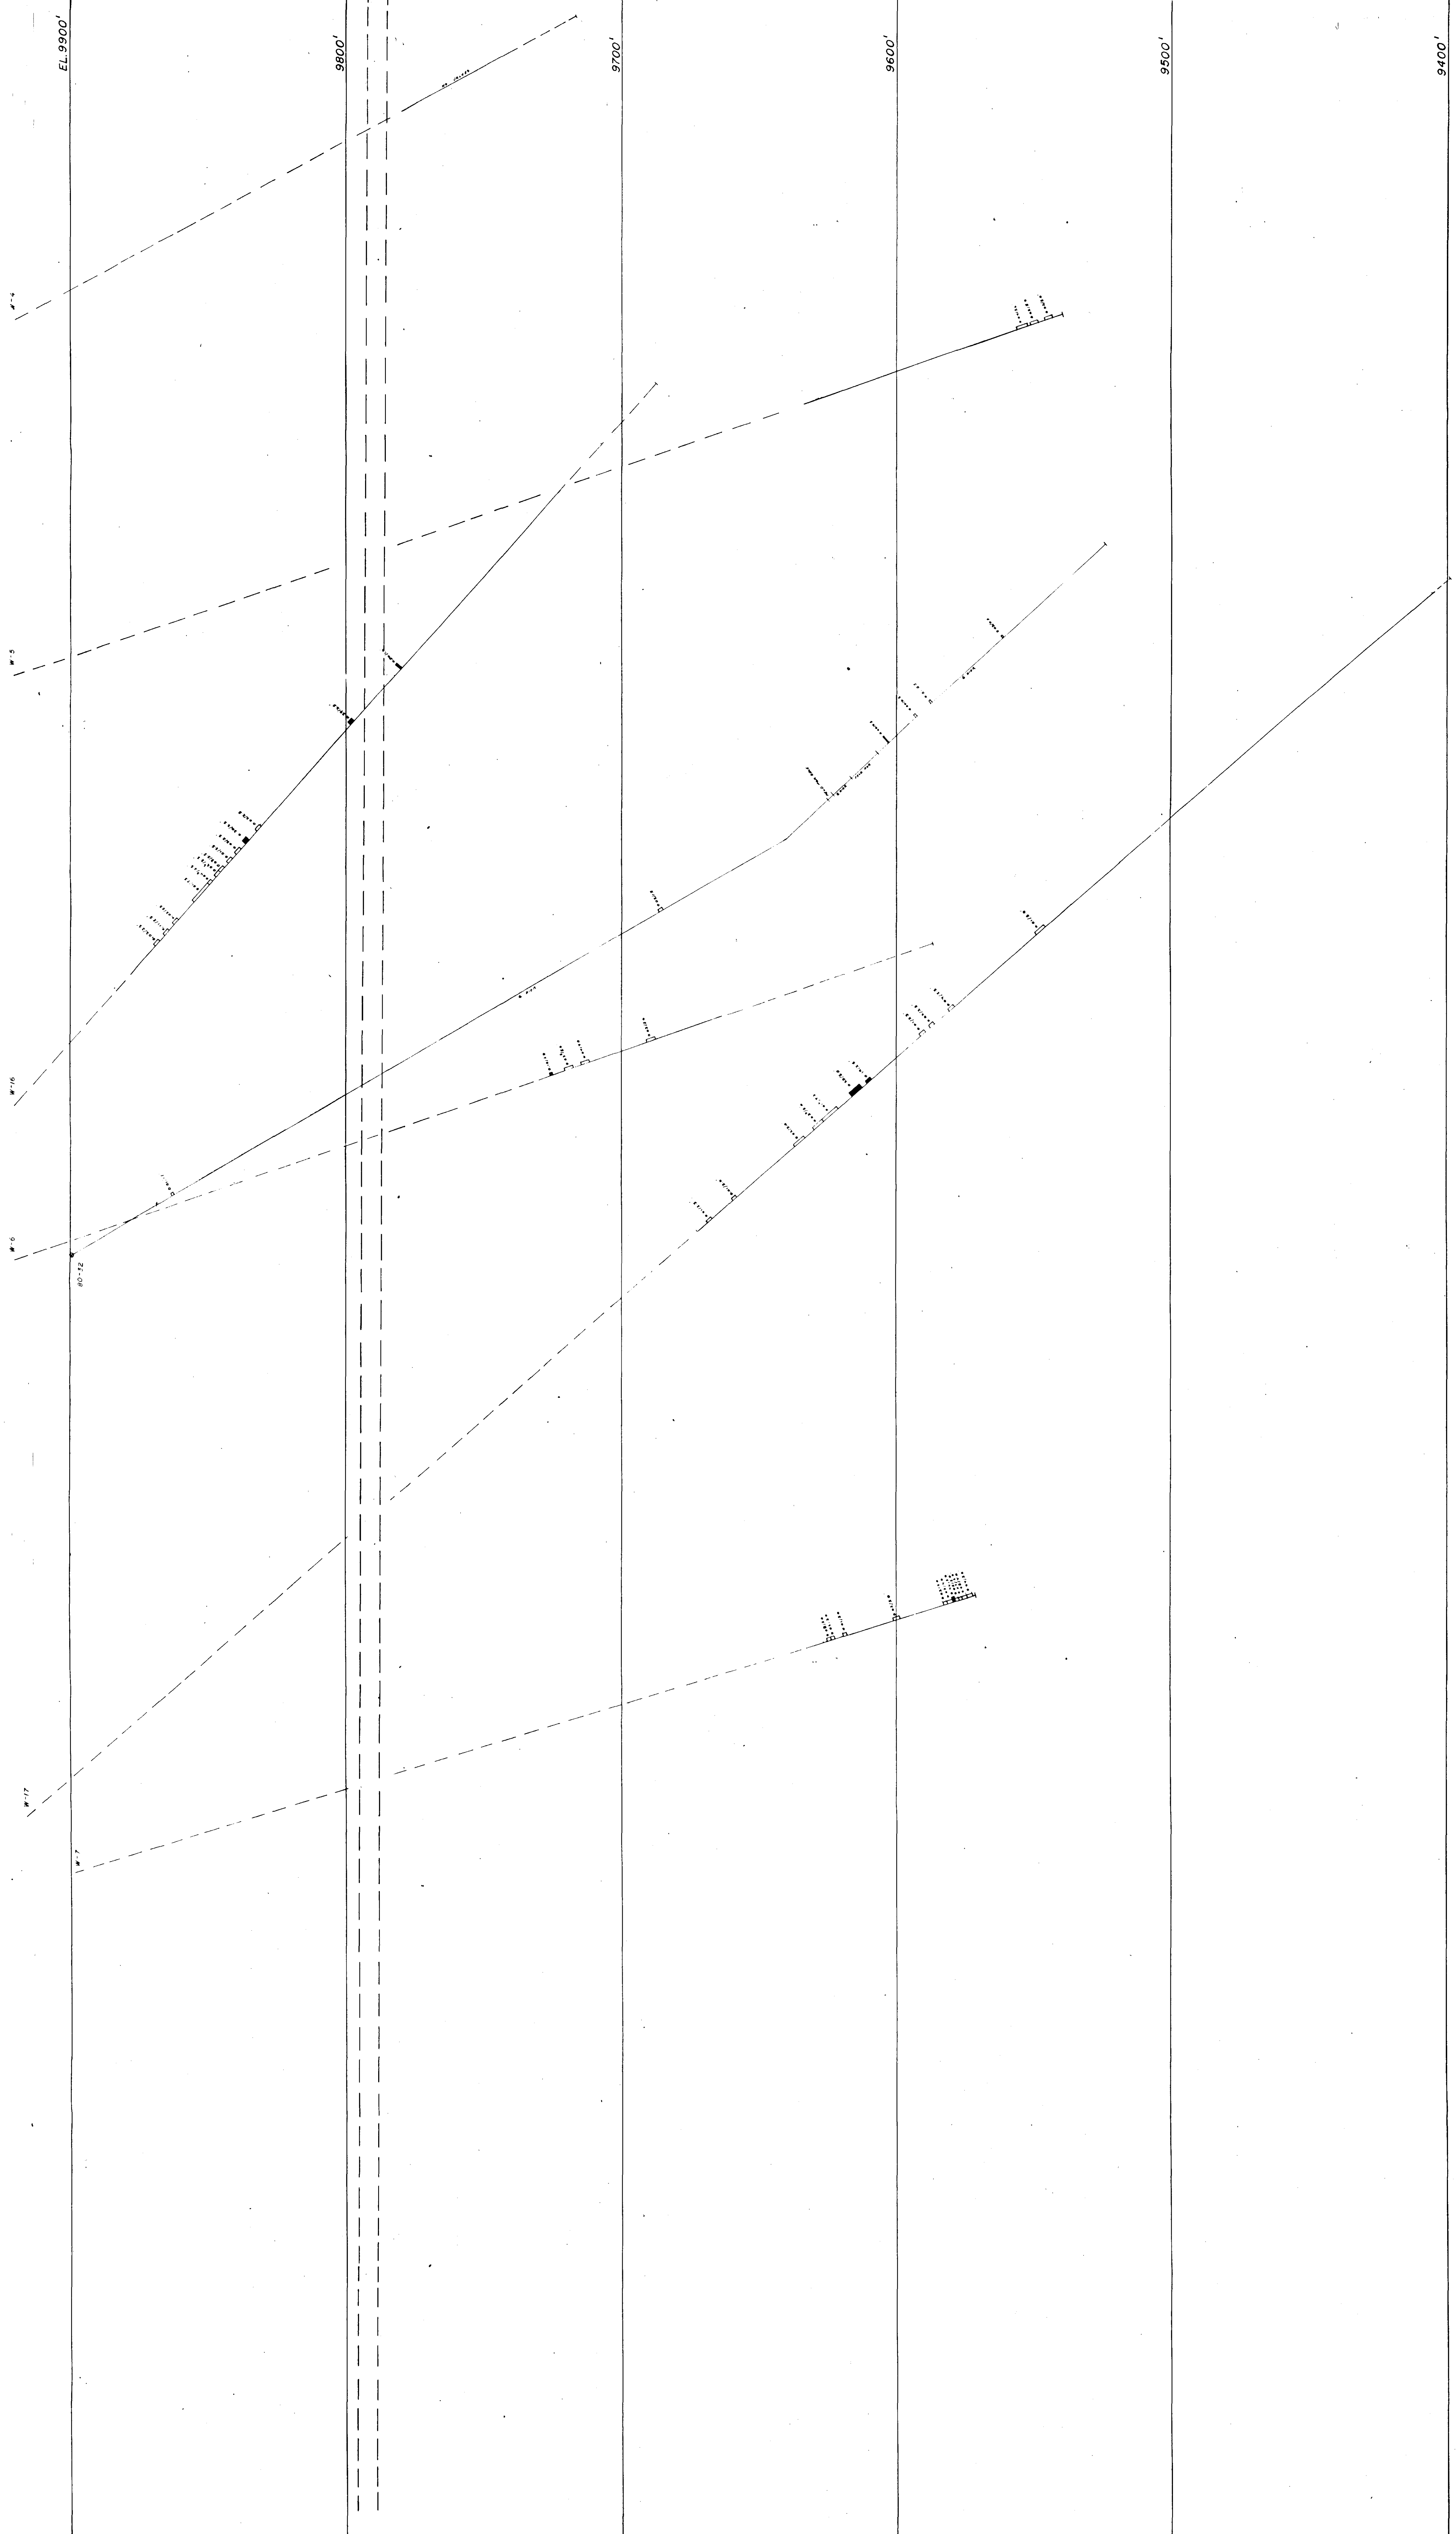WINDFALL OILS & MINES LTD.
AREA - 3

COMPOSITE LONGITUDINAL SECTION OF D. D. H.
 SOUTH GRANODIORITE


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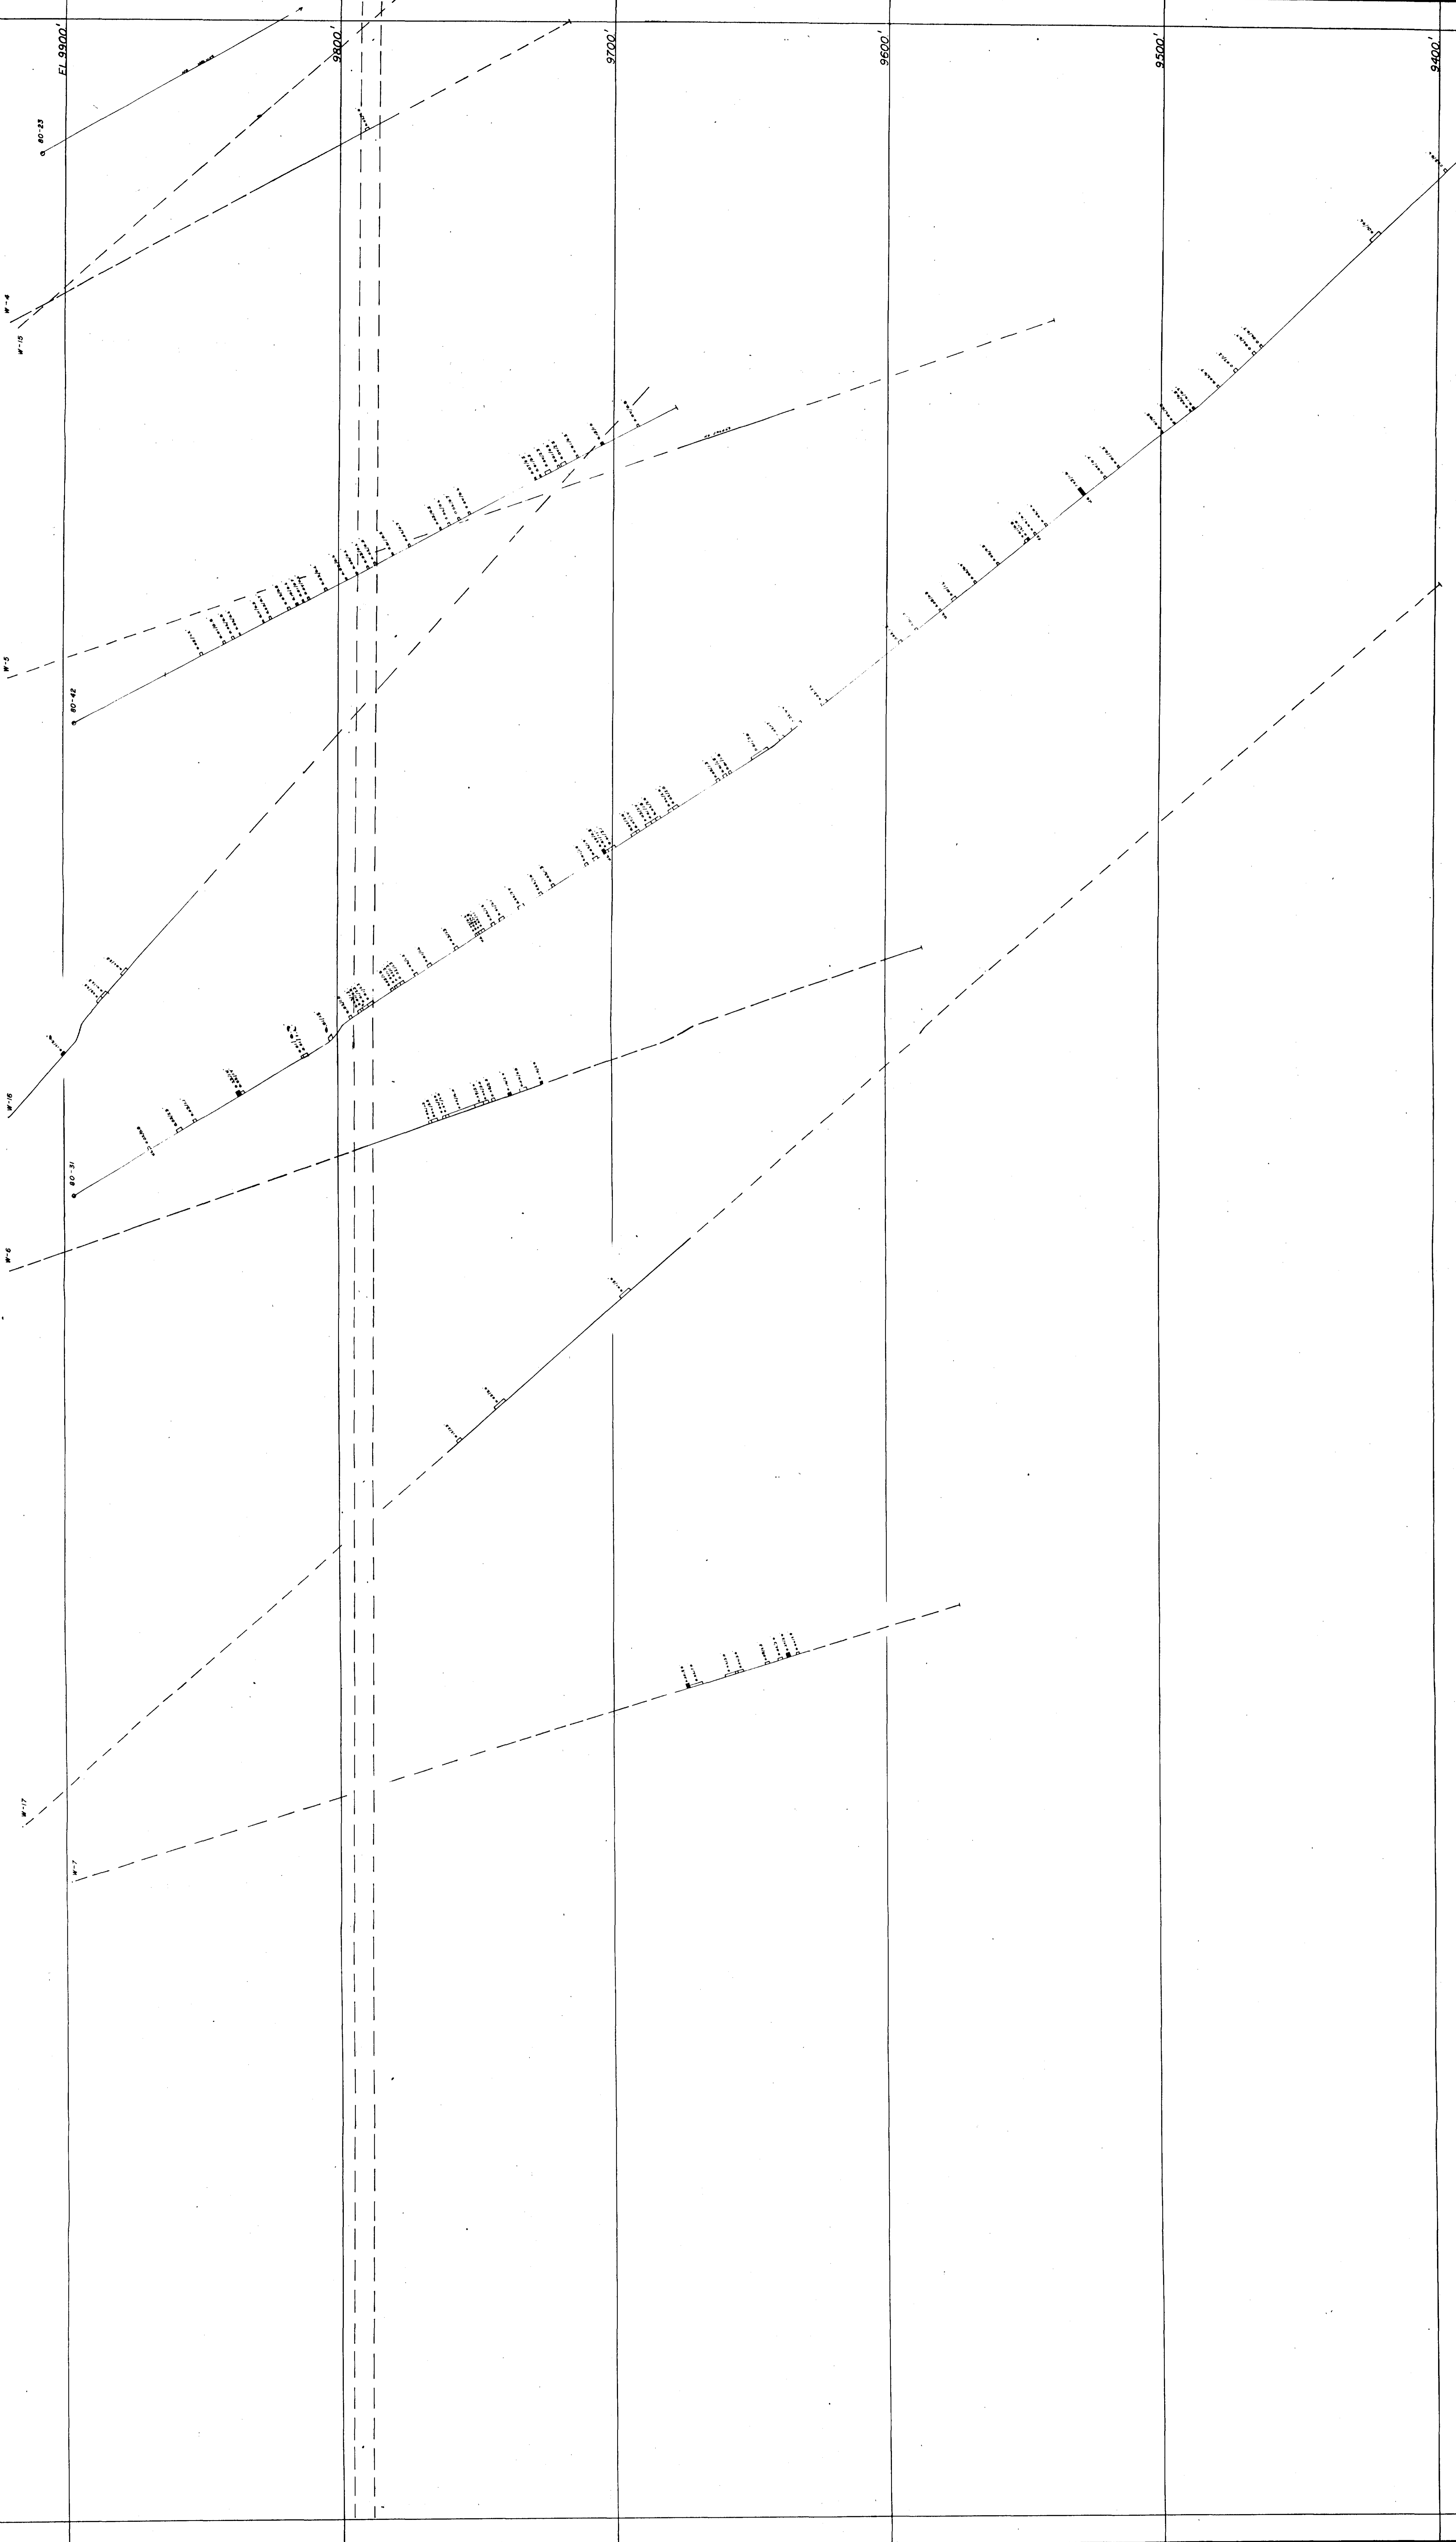
DRN. BY J. C.
 MARCH - 1981

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52-F-16-AW-0065-10





63-37374

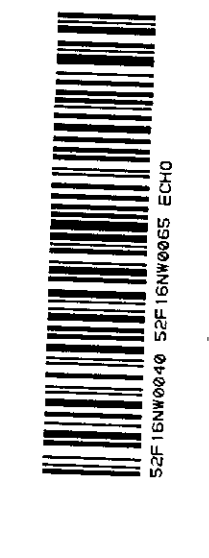WINDFALL OILS & MINES LTD.
 COMPOSITE LONGITUDINAL SECTION OF D.D.H.
 CENTRAL GRANODIORITE

SCALE: 1" = 20' 0

DRN. BY J.C.
 MARCH 1981

APPR'D BY
 C.J. KURTLEW F. ENG.

52 F/16 NW-0065 #11

